


2 ENLARGED FLOOR PLAN
 1/8" = 1'-0"

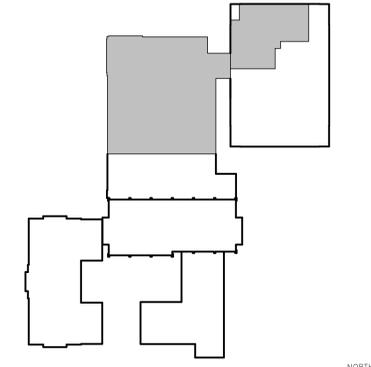

PLAN KEY
 NOT TO SCALE


GENERAL FINISH NOTES

- EXISTING FINISHES TO REMAIN UNLESS NOTED OTHERWISE ON FINISH PLAN OR IN OTHER AREAS OF THE DOCUMENTS.
- SEE GENERAL DEMOLITION DRAWINGS FOR IMPORTANT ADDITIONAL FLOOR FINISH INFORMATION.
- SEE SPECIFICATIONS FOR SPECIFIC FINISH INFORMATION.
- ALL EXPOSED STEEL TO BE ARCHITECTURALLY FINISHED AND PAINTED. ALL EXPOSED STEEL, COLUMNS AND RAILS TO RECEIVE PAINT, TO BE ARCHITECTURALLY FINISHED PER SPECIFICATION SECTION 05.12.13.00.
- SEE REFLECTED CEILING PLAN FOR CEILING FINISHES.
- COORDINATE FLOORING WITH PLUMBING FLOOR DRAINS. SEE PLUMBING PLANS FOR LOCATIONS.
- BASE TO BE 6" IN TOILET ROOMS.
- EXPOSED CEILINGS TO BE PAINTED (INCLUDES DUCTWORK, CONDUIT, STRUCTURE, ETC.)
- VERIFY CONCRETE SLAB RECESSES FOR FLOORING WITH STRUCTURAL AND MANUFACTURER REQUIREMENTS AT TERRAZZO FLOORING LOCATIONS.

PLAN KEYED NOTES

- PAINT EXISTING DOOR FRAME. PREP AS NECESSARY.
- PAINT EXISTING DOOR AND FRAME.
- PATCH VOT AS REQUIRED AND INSTALL BASE AS REQUIRED FOR NEW CONSTRUCTION.

FINISH PLAN LEGEND

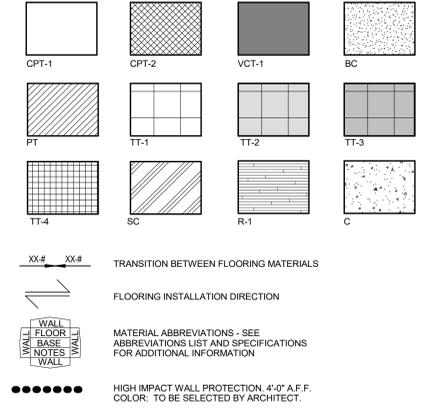


ROOM FINISH ABBREVIATIONS

- FLOORS**
- CPT-1 MODULAR CARPET: INTERFACE: GRILLWORK. COLOR: CONSTRUCTION 5994. PATTERN: 13812. QUARTER TURN. COORDINATE REQUIRED QUANTITIES OF NEW MATERIAL WITH EXISTING AVAILABLE FOR RE-USE. SEE DEMOLITION DRAWINGS. ANY EXISTING CARPET IDENTIFIED AS BEING AVAILABLE FOR RE-USE, BUT DEEMED UNUSABLE BY THE OWNER, SHALL BE SITE CLEARED AT NO EXTRA CHARGE TO THE OWNER. THE CONTRACTOR SHALL SUPPLY AN APPROPRIATE QUANTITY OF NEW CARPET TO MEET THE REQUIREMENTS OF THE CONSTRUCTION DOCUMENTS AND FOR A COMPLETE PROJECT AS PART OF THE BASE BID.
 - CPT-2 MODULAR CARPET: INTERFACE: GRILLWORK. COLOR: TO BE SELECTED BY ARCHITECT. PATTERN: QUARTER TURN.
 - TT-1 TERRAZZO TILE: TECTURA: 18" X 18" TERRAZZO TILE. COLOR: TZ15 GRAY MATTER.
 - TT-2 TERRAZZO TILE: TECTURA: 18" X 18" TERRAZZO TILE. COLOR: TZ80 NORTHERN LIGHTS.
 - TT-3 TERRAZZO TILE: TECTURA: 18" X 18" TERRAZZO TILE. COLOR: TZ19 EARTHBOUND.
 - TT-4 PRECAST EPOXY TERRAZZO SELF-SUPPORTING STAIR TREAD. COLOR: TZ80 NORTHERN LIGHTS.
 - VCT-1 VINYL COMPOSITION TILE. COLOR: SELECTED BY ARCHITECT. 12"x12".
 - PT PORCELAIN TILE: SEE ENLARGED RESTROOM FLOOR PLANS FOR SPECIFIC LOCATIONS OF THE BELOW:
 - PT-1: PORCELAIN TILE: FACTORY MOUNTED GLAZED CERAMIC TILE. COLOR: MATCH EXISTING.
 - PT-3: PORCELAIN TILE: FACTORY MOUNTED GLAZED CERAMIC TILE. COLOR: MATCH EXISTING.
 - SC SEALED CONCRETE.
 - BC SEALED CONCRETE, BROOM FINISH.
 - C CONCRETE
 - R-1 RUBBER: NORA: RUBBER TREADS AND RISERS. COLOR: TO BE SELECTED BY ARCHITECT.
 - EX-T EXISTING TERRAZZO: STRIP AND CLEAN EXISTING TERRAZZO FLOORS - SEE SPECIFICATIONS
- BASE**
- V-1 VINYL: ARMSTRONG, JOHNSONITE. VPI. COLOR: TO BE SELECTED BY ARCHITECT. 4"
 - V-2 VINYL BASE TO MATCH EXISTING. FIELD VERIFY COLOR.
 - PT-1 PORCELAIN TILE: FACTORY MOUNTED GLAZED CERAMIC TILE. COLOR: MATCH EXISTING. COVED
 - WD WOOD BASE
 - TT-1 TERRAZZO TILE: TECTURA. COLOR: TZ15 GRAY MATTER. 4" HEIGHT, BEVELED TOP.
 - TT-3 TERRAZZO TILE: TECTURA. COLOR: TZ19 EARTHBOUND. 4" HEIGHT, BEVELED TOP.
- WALLS**
- P-1 PAINT: PITTSBURGH PAINTS: SPEEDHIDE INTERIOR FLAT LATEX. COLOR: WHITE ROCK 511-2
 - P-2 PAINT: PITTSBURGH PAINTS. COLOR: TO BE SELECTED BY ARCHITECT.
 - P-3 PAINT: PITTSBURGH PAINTS. COLOR: TO BE SELECTED BY ARCHITECT.
 - EP EPOXY PAINT: PITTSBURGH PAINTS. COLOR: TO BE SELECTED BY ARCHITECT
 - WD WOOD PANELING: MATCH WOOD DOOR FINISH
 - PT PORCELAIN TILE: SEE INTERIOR ELEVATIONS FOR SPECIFIC LOCATIONS OF THE BELOW:
 - PT-1 PORCELAIN TILE: FACTORY MOUNTED GLAZED CERAMIC TILE. COLOR: MATCH EXISTING.
 - PT-2 PORCELAIN TILE: FACTORY MOUNTED GLAZED CERAMIC TILE. COLOR: MATCH EXISTING.
 - PT-3 PORCELAIN TILE: FACTORY MOUNTED GLAZED CERAMIC TILE. COLOR: MATCH EXISTING.

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NO.	DATE	REVISION

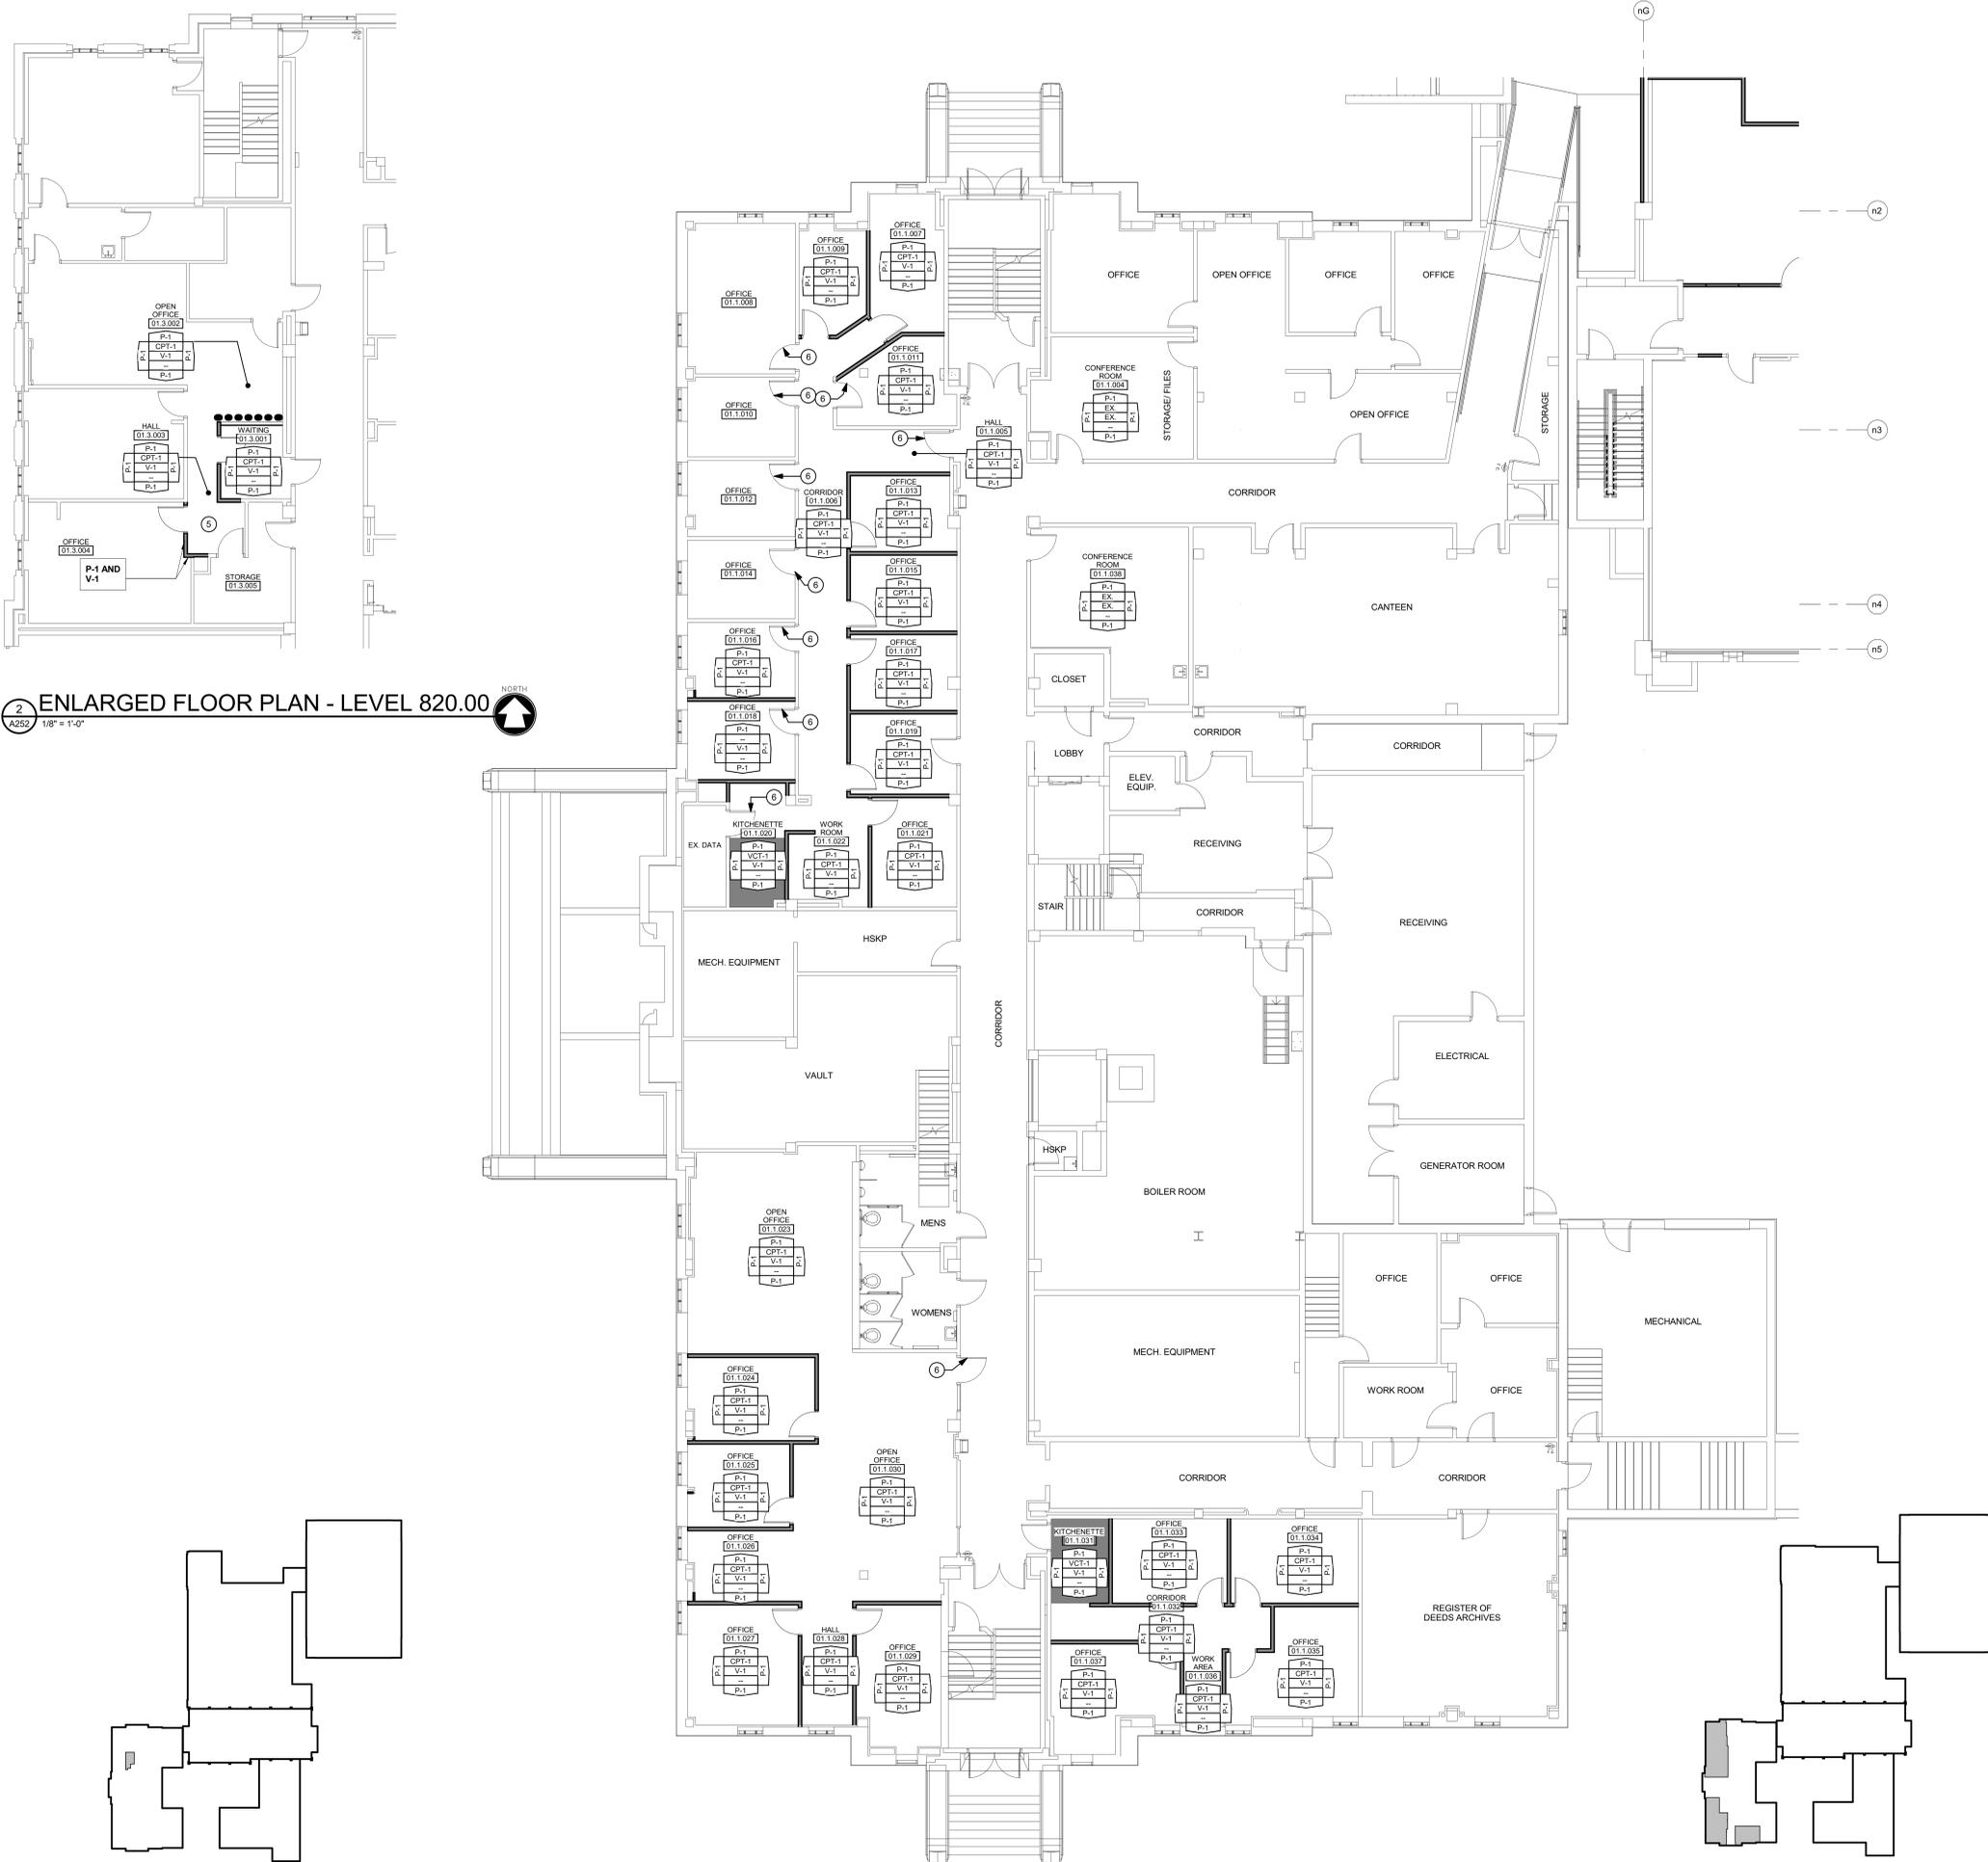

2 ENLARGED FLOOR PLAN - LEVEL 820.00
 NORTH
 1/8" = 1'-0"

1 ENLARGED FLOOR PLAN
 NORTH
 1/8" = 1'-0"

PLAN KEY
 NOT TO SCALE

PLAN KEY
 NOT TO SCALE


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- COORDINATE FLOORING WITH PLUMBING FLOOR DRAINS. SEE PLUMBING PLANS FOR LOCATIONS.
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- EXPOSED CEILING TO BE PAINTED (INCLUDES DUCTWORK, CONDUIT, STRUCTURE, ETC.)
- VERIFY CONCRETE SLAB RECESSES FOR FLOORING WITH STRUCTURAL AND MANUFACTURER REQUIREMENTS AT TERRAZZO FLOORING LOCATIONS.

PLAN KEYED NOTES

- PATCH CARPET TILES AS REQUIRED AND INSTALL BASE AS REQUIRED FOR NEW CONSTRUCTION.
- PAINT EXISTING DOOR FRAME. PREP AS NECESSARY.

FINISH PLAN LEGEND

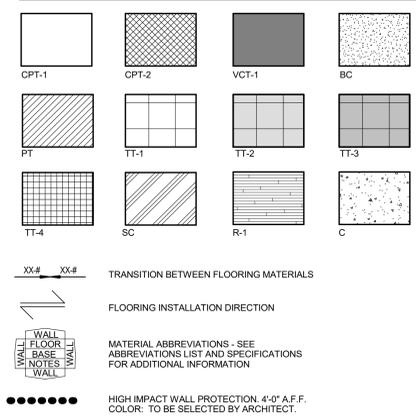


ROOM FINISH ABBREVIATIONS

FLOORS	DESCRIPTION
CPT-1	MODULAR CARPET. INTERFACE: GRILLWORK. COLOR: CONSTRUCTION 5994. PATTERN: 13812, QUARTER TURN. COORDINATE REQUIRED QUANTITIES OF NEW MATERIAL WITH EXISTING AVAILABLE FOR RE-USE. SEE DEMOLITION DRAWINGS. ANY EXISTING CARPET IDENTIFIED AS BEING AVAILABLE FOR RE-USE, BUT DEEMED UNUSABLE BY THE OWNER, SHALL BE SITE CLEARED AT NO EXTRA CHARGE TO THE OWNER. THE CONTRACTOR SHALL SUPPLY AN APPROPRIATE QUANTITY OF NEW CARPET TO MEET THE REQUIREMENTS OF THE CONSTRUCTION DOCUMENTS AND FOR A COMPLETE PROJECT AS PART OF THE BASE BID.
CPT-2	MODULAR CARPET. INTERFACE: GRILLWORK. COLOR: TO BE SELECTED BY ARCHITECT. PATTERN: QUARTER TURN.
TT-1	TERRAZZO TILE: TECTURA: 18" X 18" TERRAZZO TILE. COLOR: TZ15 GRAY MATTER.
TT-2	TERRAZZO TILE: TECTURA: 18" X 18" TERRAZZO TILE. COLOR: TZ20 NORTHERN LIGHTS.
TT-3	TERRAZZO TILE: TECTURA: 18" X 18" TERRAZZO TILE. COLOR: TZ19 EARTHBOUND.
TT-4	PRECAST EPOXY TERRAZZO SELF-SUPPORTING STAIR TREAD. COLOR: TZ20 NORTHERN LIGHTS.
VCT-1	VINYL COMPOSITION TILE. COLOR: SELECTED BY ARCHITECT, 12"X12".
PT	PORCELAIN TILE. SEE ENLARGED RESTROOM FLOOR PLANS FOR SPECIFIC LOCATIONS OF THE BELOW: PT-1: PORCELAIN TILE: FACTORY MOUNTED GLAZED CERAMIC TILE. COLOR: MATCH EXISTING. PT-3: PORCELAIN TILE: FACTORY MOUNTED GLAZED CERAMIC TILE. COLOR: MATCH EXISTING.
SC	SEALED CONCRETE.
BC	SEALED CONCRETE, BROOM FINISH.
C	CONCRETE.
R-1	RUBBER: NORA: RUBBER TREADS AND RISERS. COLOR: TO BE SELECTED BY ARCHITECT.
EX-T	EXISTING TERRAZZO: STRIP AND CLEAN EXISTING TERRAZZO FLOORS - SEE SPECIFICATIONS
BASE	DESCRIPTION
V-1	VINYL: ARMSTRONG, JOHNSONITE, VPI. COLOR: TO BE SELECTED BY ARCHITECT, 4"
V-2	VINYL BASE TO MATCH EXISTING. FIELD VERIFY COLOR.
PT-1	PORCELAIN TILE: FACTORY MOUNTED GLAZED CERAMIC TILE. COLOR: MATCH EXISTING. COVED
WD	WOOD BASE
TT-1	TERRAZZO TILE: TECTURA. COLOR: TZ15 GRAY MATTER. 4" HEIGHT, BEVELED TOP.
TT-3	TERRAZZO TILE: TECTURA. COLOR: TZ19 EARTHBOUND. 4" HEIGHT, BEVELED TOP.
WALLS	DESCRIPTION
P-1	PAINT: PITTSBURGH PAINTS. SPEEDHIDE INTERIOR FLAT LATEX. COLOR: WHITE ROCK 511-2
P-2	PAINT: PITTSBURGH PAINTS. COLOR: TO BE SELECTED BY ARCHITECT.
P-3	PAINT: PITTSBURGH PAINTS. COLOR: TO BE SELECTED BY ARCHITECT.
EP	EPOXY PAINT: PITTSBURGH PAINTS. COLOR: TO BE SELECTED BY ARCHITECT
WD	WOOD PANELING: MATCH WOOD DOOR FINISH
PT	PORCELAIN TILE: SEE INTERIOR ELEVATIONS FOR SPECIFIC LOCATIONS OF THE BELOW: PT-1: PORCELAIN TILE: FACTORY MOUNTED GLAZED CERAMIC TILE. COLOR: MATCH EXISTING. PT-2: PORCELAIN TILE: FACTORY MOUNTED GLAZED CERAMIC TILE. COLOR: MATCH EXISTING. PT-3: PORCELAIN TILE: FACTORY MOUNTED GLAZED CERAMIC TILE. COLOR: MATCH EXISTING.

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NO.	DATE	REVISION

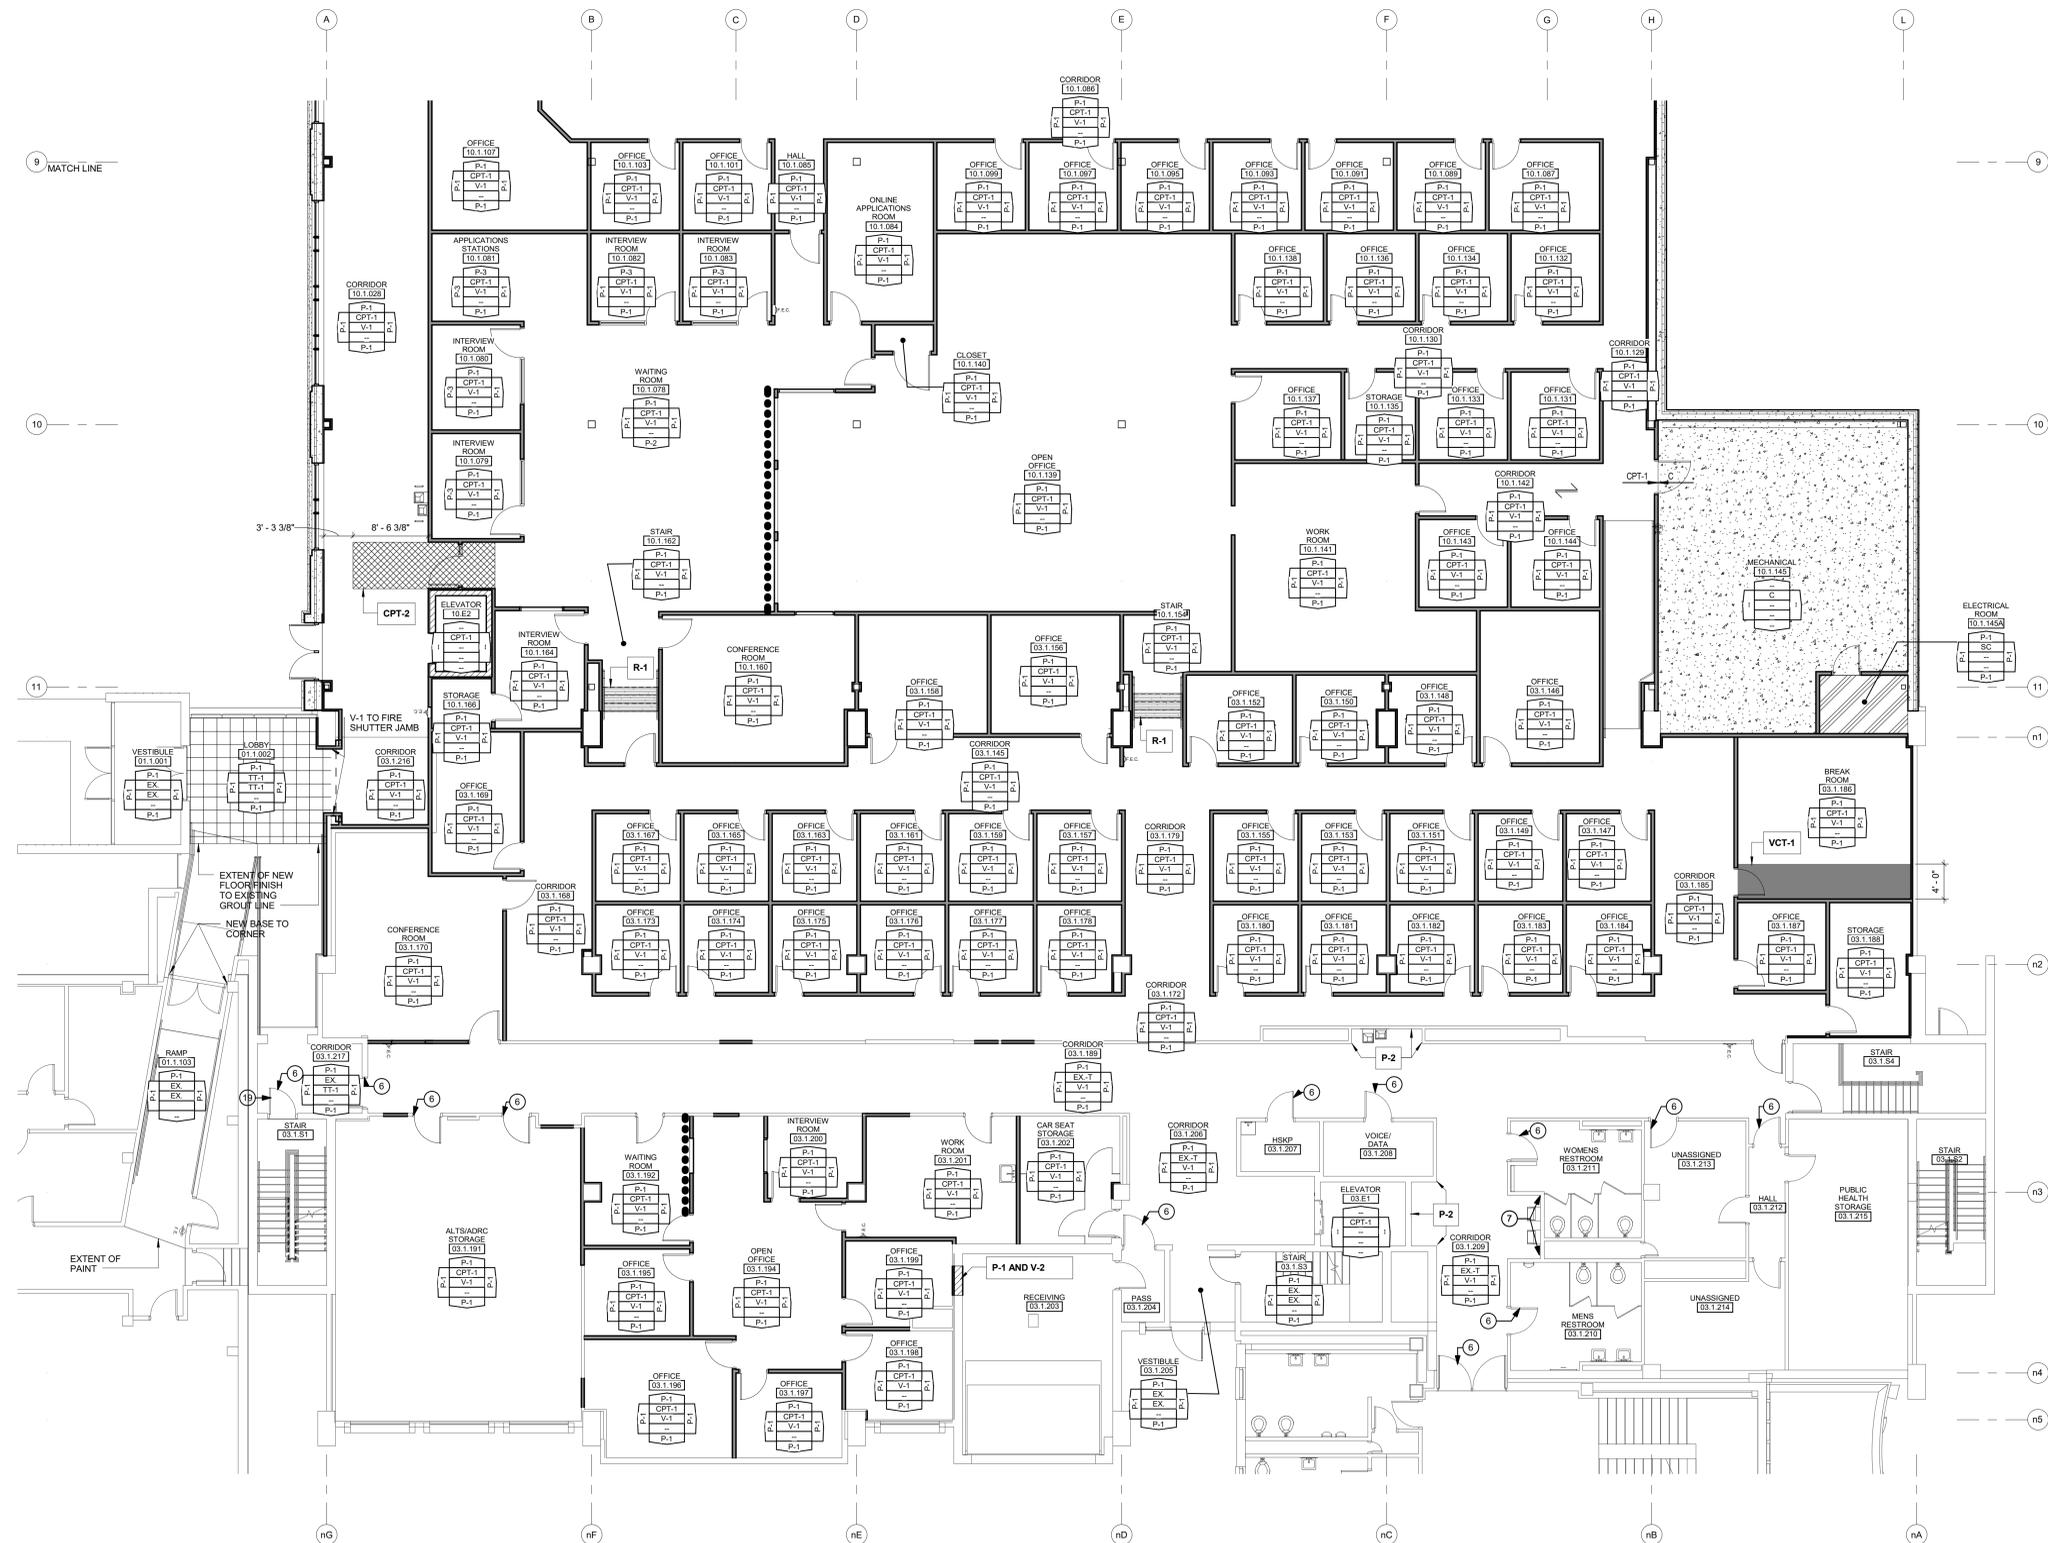


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- SEE REFLECTED CEILING PLAN FOR CEILING FINISHES.
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- VERIFY CONCRETE SLAB RECESSES FOR FLOORING WITH STRUCTURAL AND MANUFACTURER REQUIREMENTS AT TERRAZZO FLOORING LOCATIONS.

PLAN KEYED NOTES

- PAINT EXISTING DOOR FRAME. PREP AS NECESSARY.
- PATCH EXISTING CERAMIC TILE WALL WHERE TRIM IS REMOVED.
- TOUCH-UP FINISH OF EXISTING WOOD DOOR.

FINISH PLAN LEGEND

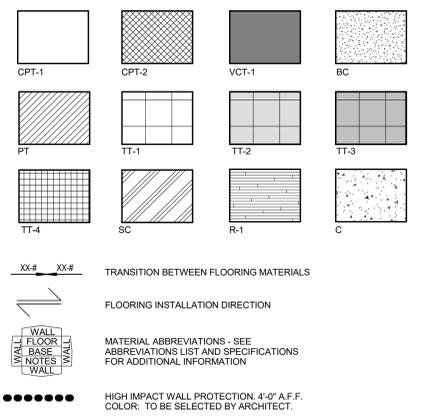

ROOM FINISH ABBREVIATIONS

FLOORS	DESCRIPTION
CPT-1	MODULAR CARPET: INTERFACE: GRILLWORK. COLOR: CONSTRUCTION 5994. PATTERN: 13912 QUARTER TURN. COORDINATE REQUIRED QUANTITIES OF NEW MATERIAL WITH EXISTING AVAILABLE FOR RE-USE. SEE DEMOLITION DRAWINGS. ANY EXISTING CARPET IDENTIFIED AS BEING AVAILABLE FOR RE-USE, BUT DEEMED UNUSABLE BY THE OWNER, SHALL BE SITE CLEARED AT NO EXTRA CHARGE TO THE OWNER. THE CONTRACTOR SHALL SUPPLY AN APPROPRIATE QUANTITY OF NEW CARPET TO MEET THE REQUIREMENTS OF THE CONSTRUCTION DOCUMENTS AND FOR A COMPLETE PROJECT AS PART OF THE BASE BID.
CPT-2	MODULAR CARPET: INTERFACE: GRILLWORK. COLOR: TO BE SELECTED BY ARCHITECT. PATTERN: QUARTER TURN.
TT-1	TERRAZZO TILE: TECTURA: 18" X 18" TERRAZZO TILE. COLOR: TZ15 GRAY MATTER.
TT-2	TERRAZZO TILE: TECTURA: 18" X 18" TERRAZZO TILE. COLOR: TZ80 NORTHERN LIGHTS.
TT-3	TERRAZZO TILE: TECTURA: 18" X 18" TERRAZZO TILE. COLOR: TZ19 EARTHBOUND.
TT-4	PRECAST EPOXY TERRAZZO SELF-SUPPORTING STAIR TREAD. COLOR: TZ30 NORTHERN LIGHTS.
VCT-1	VINYL COMPOSITION TILE: COLOR: SELECTED BY ARCHITECT, 12"X12"
PT	PORCELAIN TILE: SEE ENLARGED RESTROOM FLOOR PLANS FOR SPECIFIC LOCATIONS OF THE BELOW:
PT-1	PORCELAIN TILE: FACTORY MOUNTED GLAZED CERAMIC TILE. COLOR: MATCH EXISTING.
PT-3	PORCELAIN TILE: FACTORY MOUNTED GLAZED CERAMIC TILE. COLOR: MATCH EXISTING.
SC	SEALED CONCRETE.
BC	SEALED CONCRETE, BROOM FINISH.
C	CONCRETE
R-1	RUBBER: NORA: RUBBER TREADS AND RISERS. COLOR: TO BE SELECTED BY ARCHITECT.
EX-T	EXISTING TERRAZZO: STRIP AND CLEAN EXISTING TERRAZZO FLOORS - SEE SPECIFICATIONS
BASE	DESCRIPTION
V-1	VINYL: ARMSTRONG, JOHNSONITE, VPI. COLOR: TO BE SELECTED BY ARCHITECT, 4"
V-2	VINYL BASE TO MATCH EXISTING. FIELD VERIFY COLOR.
PT-1	PORCELAIN TILE: FACTORY MOUNTED GLAZED CERAMIC TILE. COLOR: MATCH EXISTING. COVERED
WD	WOOD BASE
TT-1	TERRAZZO TILE: TECTURA. COLOR: TZ15 GRAY MATTER. 4" HEIGHT, BEVELED TOP.
TT-3	TERRAZZO TILE: TECTURA. COLOR: TZ19 EARTHBOUND. 4" HEIGHT, BEVELED TOP.
WALLS	DESCRIPTION
P-1	PAINT: PITTSBURGH PAINTS: SPEEDHIDE INTERIOR FLAT LATEX. COLOR: WHITE ROCK 511-2
P-2	PAINT: PITTSBURGH PAINTS. COLOR: TO BE SELECTED BY ARCHITECT.
P-3	PAINT: PITTSBURGH PAINTS. COLOR: TO BE SELECTED BY ARCHITECT.
EP	EPOXY PAINT: PITTSBURGH PAINTS. COLOR: TO BE SELECTED BY ARCHITECT
WD	WOOD PANELING: MATCH WOOD DOOR FINISH
PT	PORCELAIN TILE: SEE INTERIOR ELEVATIONS FOR SPECIFIC LOCATIONS OF THE BELOW:
PT-1	PORCELAIN TILE: FACTORY MOUNTED GLAZED CERAMIC TILE. COLOR: MATCH EXISTING.
PT-2	PORCELAIN TILE: FACTORY MOUNTED GLAZED CERAMIC TILE. COLOR: MATCH EXISTING.
PT-3	PORCELAIN TILE: FACTORY MOUNTED GLAZED CERAMIC TILE. COLOR: MATCH EXISTING.

1 ENLARGED FLOOR PLAN
 1/8" = 1'-0"



PLAN KEY
 NOT TO SCALE





GENERAL FINISH NOTES

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- BASE TO BE 6" IN TOILET ROOMS.
- EXPOSED CEILINGS TO BE PAINTED (INCLUDES DUCTWORK, CONDUIT, STRUCTURE, ETC.).
- VERIFY CONCRETE SLAB RECESSES FOR FLOORING WITH STRUCTURAL AND MANUFACTURER REQUIREMENTS AT TERRAZZO FLOORING LOCATIONS.

PLAN KEYED NOTES

FINISH PLAN LEGEND

XX# XX# TRANSITION BETWEEN FLOORING MATERIALS

FLOORING INSTALLATION DIRECTION

WALL FLOOR WALL NOTES WALL

MATERIAL ABBREVIATIONS - SEE ABBREVIATIONS LIST AND SPECIFICATIONS FOR ADDITIONAL INFORMATION

●●●●● HIGH IMPACT WALL PROTECTION. 4'-0" A.F.F. COLOR: TO BE SELECTED BY ARCHITECT.

ROOM FINISH ABBREVIATIONS

- FLOORS**
- CPT-1 MODULAR CARPET; INTERFACE: GRILLWORK; COLOR: CONSTRUCTION 5994 PATTERN: 13812, QUARTER TURN. COORDINATE REQUIRED QUANTITIES OF NEW MATERIAL WITH EXISTING AVAILABLE FOR RE-USE. SEE DEMOLITION DRAWINGS. ANY EXISTING CARPET IDENTIFIED AS BEING AVAILABLE FOR RE-USE, BUT DEEMED UNUSABLE BY THE OWNER, SHALL BE SITE CLEARED AT NO EXTRA CHARGE TO THE OWNER. THE CONTRACTOR SHALL SUPPLY AN APPROPRIATE QUANTITY OF NEW CARPET TO MEET THE REQUIREMENTS OF THE CONSTRUCTION DOCUMENTS AND FOR A COMPLETE PROJECT AS PART OF THE BASE BID.
 - CPT-2 MODULAR CARPET; INTERFACE: GRILLWORK; COLOR: TO BE SELECTED BY ARCHITECT. PATTERN: QUARTER TURN.
 - TT-1 TERRAZZO TILE; TECTURA: 18" X 18" TERRAZZO TILE. COLOR: T215 GRAY MATTER.
 - TT-2 TERRAZZO TILE; TECTURA: 18" X 18" TERRAZZO TILE. COLOR: T280 NORTHERN LIGHTS.
 - TT-3 TERRAZZO TILE; TECTURA: 18" X 18" TERRAZZO TILE. COLOR: T219 EARTHBOUND.
 - TT-4 PRECAST EPOXY TERRAZZO SELF-SUPPORTING STAIR TREAD. COLOR: T280 NORTHERN LIGHTS.
 - VCT-1 VINYL COMPOSITION TILE; COLOR: SELECTED BY ARCHITECT, 12"X12".
 - PT PORCELAIN TILE; SEE ENLARGED RESTROOM FLOOR PLANS FOR SPECIFIC LOCATIONS OF THE BELOW:
 - PT-1 PORCELAIN TILE; FACTORY MOUNTED GLAZED CERAMIC TILE. COLOR: MATCH EXISTING.
 - PT-3 PORCELAIN TILE; FACTORY MOUNTED GLAZED CERAMIC TILE. COLOR: MATCH EXISTING.
 - SC SEALED CONCRETE.
 - BC SEALED CONCRETE, BROOM FINISH.
 - C CONCRETE
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 - EX-T EXISTING TERRAZZO; STRIP AND CLEAN EXISTING TERRAZZO FLOORS - SEE SPECIFICATIONS
- BASE**
- V-1 VINYL; ARMSTRONG, JOHNSONITE, VPI. COLOR: TO BE SELECTED BY ARCHITECT. 4"
 - V-2 VINYL BASE TO MATCH EXISTING. FIELD VERIFY COLOR.
 - PT-1 PORCELAIN TILE; FACTORY MOUNTED GLAZED CERAMIC TILE. COLOR: MATCH EXISTING. COVED
 - WD WOOD BASE
 - TT-1 TERRAZZO TILE; TECTURA. COLOR: T215 GRAY MATTER. 4" HEIGHT, BEVELED TOP.
 - TT-3 TERRAZZO TILE; TECTURA. COLOR: T219 EARTHBOUND. 4" HEIGHT, BEVELED TOP.
- WALLS**
- P-1 PAINT; PITTSBURGH PAINTS; SPEEDHIDE INTERIOR FLAT LATEX. COLOR: WHITE ROCK 511-2
 - P-2 PAINT; PITTSBURGH PAINTS. COLOR: TO BE SELECTED BY ARCHITECT.
 - P-3 PAINT; PITTSBURGH PAINTS. COLOR: TO BE SELECTED BY ARCHITECT.
 - EP EPOXY PAINT; PITTSBURGH PAINTS. COLOR: TO BE SELECTED BY ARCHITECT
 - WD WOOD PANELING; MATCH WOOD DOOR FINISH
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 - PT-3 PORCELAIN TILE; FACTORY MOUNTED GLAZED CERAMIC TILE. COLOR: MATCH EXISTING.

1 ENLARGED FLOOR PLAN
A254 1/8" = 1'-0"


PLAN KEY
NOT TO SCALE

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NO.	DATE	REVISION

ALTERATION / ADDITION
OUTAGAMIE COUNTY ADMINISTRATION CENTER
S. WALNUT & W. 8TH, APPLETON WI 54911
LEVEL 790.00 ENLARGED FINISH PLAN - OCAC NORTH

DESIGNED	DRAWN
ASF/MAG	BLG
PROJECT NO. 0002-61600160	
DATE MARCH 3, 2017	
SHEET NO. A254	

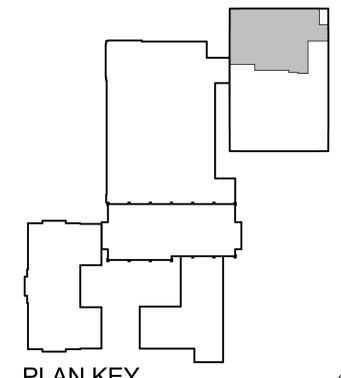

1 ENLARGED FLOOR PLAN
A255 1/8" = 1'-0"


PLAN KEY
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- BASE TO BE 6" IN TOILET ROOMS.
- EXPOSED CEILINGS TO BE PAINTED (INCLUDES DUCTWORK, CONDUIT, STRUCTURE, ETC.)
- VERIFY CONCRETE SLAB RECESSES FOR FLOORING WITH STRUCTURAL AND MANUFACTURER REQUIREMENTS AT TERRAZZO FLOORING LOCATIONS.

PLAN KEYED NOTES

FINISH PLAN LEGEND



ROOM FINISH ABBREVIATIONS

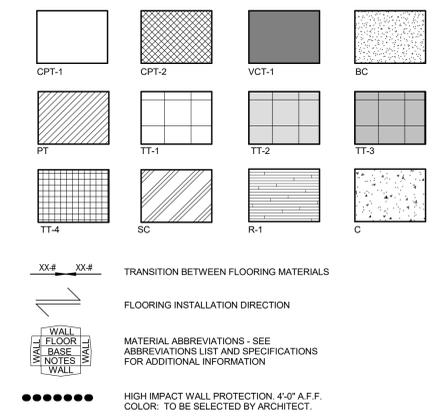
- FLOORS**
- CPT-1 MODULAR CARPET. INTERFACE: GRILLWORK. COLOR: CONSTRUCTION 5994. PATTERN: 13812. QUARTER TURN. COORDINATE REQUIRED QUANTITIES OF NEW MATERIAL WITH EXISTING AVAILABLE FOR RE-USE. SEE DEMOLITION DRAWINGS. ANY EXISTING CARPET IDENTIFIED AS BEING AVAILABLE FOR RE-USE, BUT DEEMED UNSALABLE BY THE OWNER, SHALL BE SITE CLEARED AT NO EXTRA CHARGE TO THE OWNER. THE CONTRACTOR SHALL SUPPLY AN APPROPRIATE QUANTITY OF NEW CARPET TO MEET THE REQUIREMENTS OF THE CONSTRUCTION DOCUMENTS AND FOR A COMPLETE PROJECT AS PART OF THE BASE BID.
 - CPT-2 MODULAR CARPET. INTERFACE: GRILLWORK. COLOR: TO BE SELECTED BY ARCHITECT. PATTERN: QUARTER TURN.
 - TT-1 TERRAZZO TILE: TECTURA: 18" X 18" TERRAZZO TILE. COLOR: TZ15 GRAY MATTER.
 - TT-2 TERRAZZO TILE: TECTURA: 18" X 18" TERRAZZO TILE. COLOR: T280 NORTHERN LIGHTS.
 - TT-3 TERRAZZO TILE: TECTURA: 18" X 18" TERRAZZO TILE. COLOR: T219 EARTHBOUND.
 - TT-4 PRECAST EPOXY TERRAZZO SELF-SUPPORTING STAIR TREAD. COLOR: T280 NORTHERN LIGHTS.
 - VCT-1 VINYL COMPOSITION TILE. COLOR: SELECTED BY ARCHITECT, 12"X12".
 - PT PORCELAIN TILE: SEE ENLARGED RESTROOM FLOOR PLANS FOR SPECIFIC LOCATIONS OF THE BELOW:
 - PT-1: PORCELAIN TILE: FACTORY MOUNTED GLAZED CERAMIC TILE. COLOR: MATCH EXISTING.
 - PT-3: PORCELAIN TILE: FACTORY MOUNTED GLAZED CERAMIC TILE. COLOR: MATCH EXISTING.
 - SC SEALED CONCRETE.
 - BC SEALED CONCRETE, BROOM FINISH.
 - C CONCRETE
 - R-1 RUBBER, NORA: RUBBER TREADS AND RISERS. COLOR: TO BE SELECTED BY ARCHITECT.
 - EX-T EXISTING TERRAZZO. STRIP AND CLEAN EXISTING TERRAZZO FLOORS - SEE SPECIFICATIONS
- BASE**
- V-1 VINYL: ARMSTRONG, JOHNSONITE, VPI. COLOR: TO BE SELECTED BY ARCHITECT. 4"
 - V-2 VINYL BASE TO MATCH EXISTING. FIELD VERIFY COLOR.
 - PT-1 PORCELAIN TILE: FACTORY MOUNTED GLAZED CERAMIC TILE. COLOR: MATCH EXISTING. COVED
 - WD WOOD BASE
 - TT-1 TERRAZZO TILE: TECTURA. COLOR: TZ15 GRAY MATTER. 4" HEIGHT, BEVELED TOP.
 - TT-3 TERRAZZO TILE: TECTURA. COLOR: TZ19 EARTHBOUND. 4" HEIGHT, BEVELED TOP.
- WALLS**
- P-1 PAINT: PITTSBURGH PAINTS: SPEEDHIDE INTERIOR FLAT LATEX. COLOR: WHITE ROCK 511-2
 - P-2 PAINT: PITTSBURGH PAINTS. COLOR: TO BE SELECTED BY ARCHITECT.
 - P-3 PAINT: PITTSBURGH PAINTS. COLOR: TO BE SELECTED BY ARCHITECT.
 - EP EPOXY PAINT: PITTSBURGH PAINTS. COLOR: TO BE SELECTED BY ARCHITECT
 - WD WOOD PANELING: MATCH WOOD DOOR FINISH
 - PT PORCELAIN TILE: SEE INTERIOR ELEVATIONS FOR SPECIFIC LOCATIONS OF THE BELOW:
 - PT-1 PORCELAIN TILE: FACTORY MOUNTED GLAZED CERAMIC TILE. COLOR: MATCH EXISTING.
 - PT-2 PORCELAIN TILE: FACTORY MOUNTED GLAZED CERAMIC TILE. COLOR: MATCH EXISTING.
 - PT-3 PORCELAIN TILE: FACTORY MOUNTED GLAZED CERAMIC TILE. COLOR: MATCH EXISTING.

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NO.	DATE	REVISION

ALTERATION / ADDITION
OUTAGAMIE COUNTY ADMINISTRATION CENTER
S. WALNUT & W. 8TH, APPLETON WI 54911
LEVEL 790.00 ENLARGED FINISH PLAN - JUSTICE CENTER

DESIGNED	DRAWN
ASF/MAG	BLG
PROJECT NO. 0002-61600160	
DATE MARCH 3, 2017	
SHEET NO. A255	

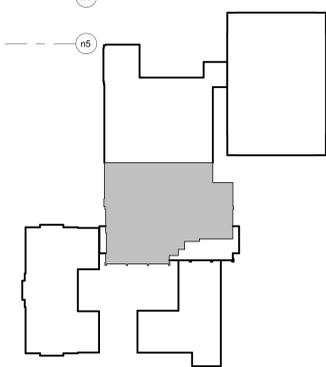

ENLARGED FLOOR PLAN
 1/8" = 1'-0"

PLAN KEY
 NOT TO SCALE

GENERAL FINISH NOTES

- EXISTING FINISHES TO REMAIN UNLESS NOTED OTHERWISE ON FINISH PLAN OR IN OTHER AREAS OF THE DOCUMENTS.
- SEE GENERAL DEMOLITION DRAWINGS FOR IMPORTANT ADDITIONAL FLOOR FINISH INFORMATION.
- SEE SPECIFICATIONS FOR SPECIFIC FINISH INFORMATION.
- ALL EXPOSED STEEL TO BE ARCHITECTURALLY FINISHED AND PAINTED. ALL EXPOSED STEEL COLUMNS AND RAILS TO RECEIVE PAINT TO BE ARCHITECTURALLY FINISHED PER SPECIFICATION SECTION 05.12.13.00.
- SEE REFLECTED CEILING PLAN FOR CEILING FINISHES.
- COORDINATE FLOORING WITH PLUMBING FLOOR DRAINS. SEE PLUMBING PLANS FOR LOCATIONS.
- BASE TO BE 6" IN TOILET ROOMS.
- EXPOSED CEILINGS TO BE PAINTED (INCLUDES DUCTWORK, CONDUIT, STRUCTURE, ETC.)
- VERIFY CONCRETE SLAB RECESSES FOR FLOORING WITH STRUCTURAL AND MANUFACTURER REQUIREMENTS AT TERRAZZO FLOORING LOCATIONS.

PLAN KEYED NOTES

- PAINT EXISTING DOOR FRAME. PREP AS NECESSARY.
- PATCH EXISTING CERAMIC TILE WALL WHERE TRIM IS REMOVED.

FLOOR PLAN LEGEND

XX# XX# TRANSITION BETWEEN FLOORING MATERIALS

FLOORING INSTALLATION DIRECTION

MATERIAL ABBREVIATIONS - SEE ABBREVIATIONS LIST AND SPECIFICATIONS FOR ADDITIONAL INFORMATION

HIGH IMPACT WALL PROTECTION. 4'-0" A.F.F. COLOR: TO BE SELECTED BY ARCHITECT.

ROOM FINISH ABBREVIATIONS

- FLOORS**
- CPT-1 MODULAR CARPET: INTERFACE: GRILLWORK. COLOR: CONSTRUCTION 5994. PATTERN: 13612. QUARTER TURN. COORDINATE REQUIRED QUANTITIES OF NEW MATERIAL WITH EXISTING AVAILABLE FOR RE-USE. SEE DEMOLITION DRAWINGS: ANY EXISTING CARPET IDENTIFIED AS BEING AVAILABLE FOR RE-USE, BUT DEEMED UNUSABLE BY THE OWNER, SHALL BE SITE CLEARED AT NO EXTRA CHARGE TO THE OWNER. THE CONTRACTOR SHALL SUPPLY AN APPROPRIATE QUANTITY OF NEW CARPET TO MEET THE REQUIREMENTS OF THE CONSTRUCTION DOCUMENTS AND FOR A COMPLETE PROJECT AS PART OF THE BASE BID.
- CPT-2 MODULAR CARPET: INTERFACE: GRILLWORK. COLOR: TO BE SELECTED BY ARCHITECT. PATTERN: QUARTER TURN.
- TT-1 TERRAZZO TILE: TECTURA: 18" X 18" TERRAZZO TILE. COLOR: TZ15 GRAY MATTER.
- TT-2 TERRAZZO TILE: TECTURA: 18" X 18" TERRAZZO TILE. COLOR: TZ80 NORTHERN LIGHTS.
- TT-3 TERRAZZO TILE: TECTURA: 18" X 18" TERRAZZO TILE. COLOR: TZ19 EARTHBOUND.
- TT-4 PRECAST EPOXY TERRAZZO SELF-SUPPORTING STAIR TREAD. COLOR: TZ80 NORTHERN LIGHTS.
- VCT-1 VINYL COMPOSITION TILE: COLOR: SELECTED BY ARCHITECT. 12"X12"
- PT PORCELAIN TILE: SEE ENLARGED RESTROOM FLOOR PLANS FOR SPECIFIC LOCATIONS OF THE BELOW.
- PT-1 PORCELAIN TILE: FACTORY MOUNTED GLAZED CERAMIC TILE. COLOR: MATCH EXISTING.
- PT-3 PORCELAIN TILE: FACTORY MOUNTED GLAZED CERAMIC TILE. COLOR: MATCH EXISTING.
- SC SEALED CONCRETE.
- BC SEALED CONCRETE, BROOM FINISH.
- C CONCRETE
- R-1 RUBBER: NORA: RUBBER TREADS AND RISERS. COLOR: TO BE SELECTED BY ARCHITECT.
- EX-T EXISTING TERRAZZO: STRIP AND CLEAN EXISTING TERRAZZO FLOORS - SEE SPECIFICATIONS
- BASE**
- V-1 VINYL: ARMSTRONG, JOHNSONITE, VPI. COLOR: TO BE SELECTED BY ARCHITECT. 4"
- V-2 VINYL BASE TO MATCH EXISTING. FIELD VERIFY COLOR.
- PT-1 PORCELAIN TILE: FACTORY MOUNTED GLAZED CERAMIC TILE. COLOR: MATCH EXISTING. COVED
- WD WOOD BASE
- TT-1 TERRAZZO TILE: TECTURA. COLOR: TZ15 GRAY MATTER. 4" HEIGHT, BEVELED TOP.
- TT-3 TERRAZZO TILE: TECTURA. COLOR: TZ19 EARTHBOUND. 4" HEIGHT, BEVELED TOP.
- WALLS**
- P-1 PAINT: PITTSBURGH PAINTS: SPEEDHIDE INTERIOR FLAT LATEX. COLOR: WHITE ROCK 911-2
- P-2 PAINT: PITTSBURGH PAINTS. COLOR: TO BE SELECTED BY ARCHITECT.
- P-3 PAINT: PITTSBURGH PAINTS. COLOR: TO BE SELECTED BY ARCHITECT.
- EP EPOXY PAINT: PITTSBURGH PAINTS. COLOR: TO BE SELECTED BY ARCHITECT
- WD WOOD PANELING: MATCH WOOD DOOR FINISH
- PT PORCELAIN TILE: SEE INTERIOR ELEVATIONS FOR SPECIFIC LOCATIONS OF THE BELOW:
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- PT-2 PORCELAIN TILE: FACTORY MOUNTED GLAZED CERAMIC TILE. COLOR: MATCH EXISTING.
- PT-3 PORCELAIN TILE: FACTORY MOUNTED GLAZED CERAMIC TILE. COLOR: MATCH EXISTING.




1 ENLARGED FLOOR PLAN
 A257 1/8" = 1'-0"

GENERAL FINISH NOTES

- EXISTING FINISHES TO REMAIN UNLESS NOTED OTHERWISE ON FINISH PLAN OR IN OTHER AREAS OF THE DOCUMENTS.
- SEE GENERAL DEMOLITION DRAWINGS FOR IMPORTANT ADDITIONAL FLOOR FINISH INFORMATION.
- SEE SPECIFICATIONS FOR SPECIFIC FINISH INFORMATION.
- ALL EXPOSED STEEL TO BE ARCHITECTURALLY FINISHED AND PAINTED. ALL EXPOSED STEEL COLUMNS AND RAILS TO RECEIVE PAINT. TO BE ARCHITECTURALLY FINISHED PER SPECIFICATION SECTION 05.12.13.00.
- SEE REFLECTED CEILING PLAN FOR CEILING FINISHES.
- COORDINATE FLOORING WITH PLUMBING FLOOR DRAINS. SEE PLUMBING PLANS FOR LOCATIONS.
- BASE TO BE 6" IN TOILET ROOMS.
- EXPOSED CEILINGS TO BE PAINTED (INCLUDES DUCTWORK, CONDUIT, STRUCTURE, ETC.)
- VERIFY CONCRETE SLAB RECESSES FOR FLOORING WITH STRUCTURAL AND MANUFACTURER REQUIREMENTS AT TERRAZZO FLOORING LOCATIONS.

PLAN KEYED NOTES

FINISH PLAN LEGEND

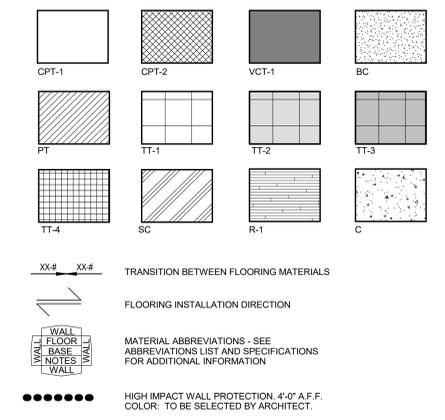

ROOM FINISH ABBREVIATIONS

- FLOORS**
- CPT-1 MODULAR CARPET: INTERFACE: GRILLWORK. COLOR: CONSTRUCTION 5994. PATTERN: 13812. QUARTER TURN. COORDINATE REQUIRED QUANTITIES OF NEW MATERIAL WITH EXISTING AVAILABLE FOR RE-USE. SEE DEMOLITION DRAWINGS. ANY EXISTING CARPET IDENTIFIED AS BEING AVAILABLE FOR RE-USE, BUT DEEMED UNUSABLE BY THE OWNER, SHALL BE SITE CLEARED AT NO EXTRA CHARGE TO THE OWNER. THE CONTRACTOR SHALL SUPPLY AN APPROPRIATE QUANTITY OF NEW CARPET TO MEET THE REQUIREMENTS OF THE CONSTRUCTION DOCUMENTS AND FOR A COMPLETE PROJECT AS PART OF THE BASE BID.
 - CPT-2 MODULAR CARPET: INTERFACE: GRILLWORK. COLOR: TO BE SELECTED BY ARCHITECT. PATTERN: QUARTER TURN.
 - TT-1 TERRAZZO TILE: TECTURA: 18" X 18" TERRAZZO TILE. COLOR: TZ15 GRAY MATTER.
 - TT-2 TERRAZZO TILE: TECTURA: 18" X 18" TERRAZZO TILE. COLOR: TZ80 NORTHERN LIGHTS.
 - TT-3 TERRAZZO TILE: TECTURA: 18" X 18" TERRAZZO TILE. COLOR: TZ19 EARTHBOUND.
 - TT-4 PRECAST EPOXY TERRAZZO SELF-SUPPORTING STAIR TREAD. COLOR: TZ80 NORTHERN LIGHTS.
 - VCT-1 VINYL COMPOSITION TILE. COLOR: SELECTED BY ARCHITECT. 12"X12".
 - PT PORCELAIN TILE: SEE ENLARGED RESTROOM FLOOR PLANS FOR SPECIFIC LOCATIONS OF THE BELOW:
 - PT-1 PORCELAIN TILE: FACTORY MOUNTED GLAZED CERAMIC TILE. COLOR: MATCH EXISTING.
 - PT-3 PORCELAIN TILE: FACTORY MOUNTED GLAZED CERAMIC TILE. COLOR: MATCH EXISTING.
 - SC SEALED CONCRETE.
 - BC SEALED CONCRETE, BROOM FINISH.
 - C CONCRETE
 - R-1 RUBBER: NORA: RUBBER TREADS AND RISERS. COLOR: TO BE SELECTED BY ARCHITECT.
 - EX-T EXISTING TERRAZZO: STRIP AND CLEAN EXISTING TERRAZZO FLOORS - SEE SPECIFICATIONS
- BASE**
- V-1 VINYL: ARMSTRONG, JOHNSONITE, VPI. COLOR: TO BE SELECTED BY ARCHITECT. 4"
 - V-2 VINYL BASE TO MATCH EXISTING. FIELD VERIFY COLOR.
 - PT-1 PORCELAIN TILE: FACTORY MOUNTED GLAZED CERAMIC TILE. COLOR: MATCH EXISTING. COVED
 - WD WOOD BASE
 - TT-1 TERRAZZO TILE: TECTURA. COLOR: TZ15 GRAY MATTER. 4" HEIGHT, BEVELED TOP.
 - TT-3 TERRAZZO TILE: TECTURA. COLOR: TZ19 EARTHBOUND. 4" HEIGHT, BEVELED TOP.
- WALLS**
- P-1 PAINT: PITTSBURGH PAINTS: SPEEDHIDE INTERIOR FLAT LATEX. COLOR: WHITE ROCK 511-2
 - P-2 PAINT: PITTSBURGH PAINTS. COLOR: TO BE SELECTED BY ARCHITECT.
 - P-3 PAINT: PITTSBURGH PAINTS. COLOR: TO BE SELECTED BY ARCHITECT.
 - EP EPOXY PAINT: PITTSBURGH PAINTS. COLOR: TO BE SELECTED BY ARCHITECT
 - WD WOOD PANELING: MATCH WOOD DOOR FINISH
 - PT PORCELAIN TILE: SEE INTERIOR ELEVATIONS FOR SPECIFIC LOCATIONS OF THE BELOW:
 - PT-1 PORCELAIN TILE: FACTORY MOUNTED GLAZED CERAMIC TILE. COLOR: MATCH EXISTING.
 - PT-2 PORCELAIN TILE: FACTORY MOUNTED GLAZED CERAMIC TILE. COLOR: MATCH EXISTING.
 - PT-3 PORCELAIN TILE: FACTORY MOUNTED GLAZED CERAMIC TILE. COLOR: MATCH EXISTING.


PLAN KEY
 NOT TO SCALE

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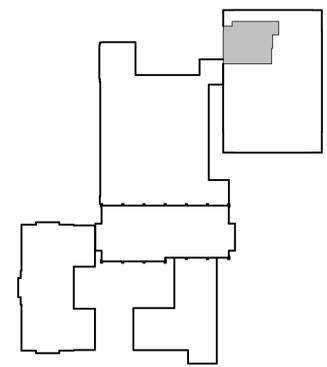
NO.	DATE	REVISION

ALTERATION / ADDITION
OUTAGAME COUNTY ADMINISTRATION CENTER
S. WALNUT & W. 8TH, APPLETON WI 54911
LEVEL 805.00 ENLARGED FINISH PLAN - OCAC NORTH

DESIGNED	BLG
ASF/MAG	
PROJECT NO.	0002-61600160
DATE	MARCH 3, 2017
SHEET NO.	A257

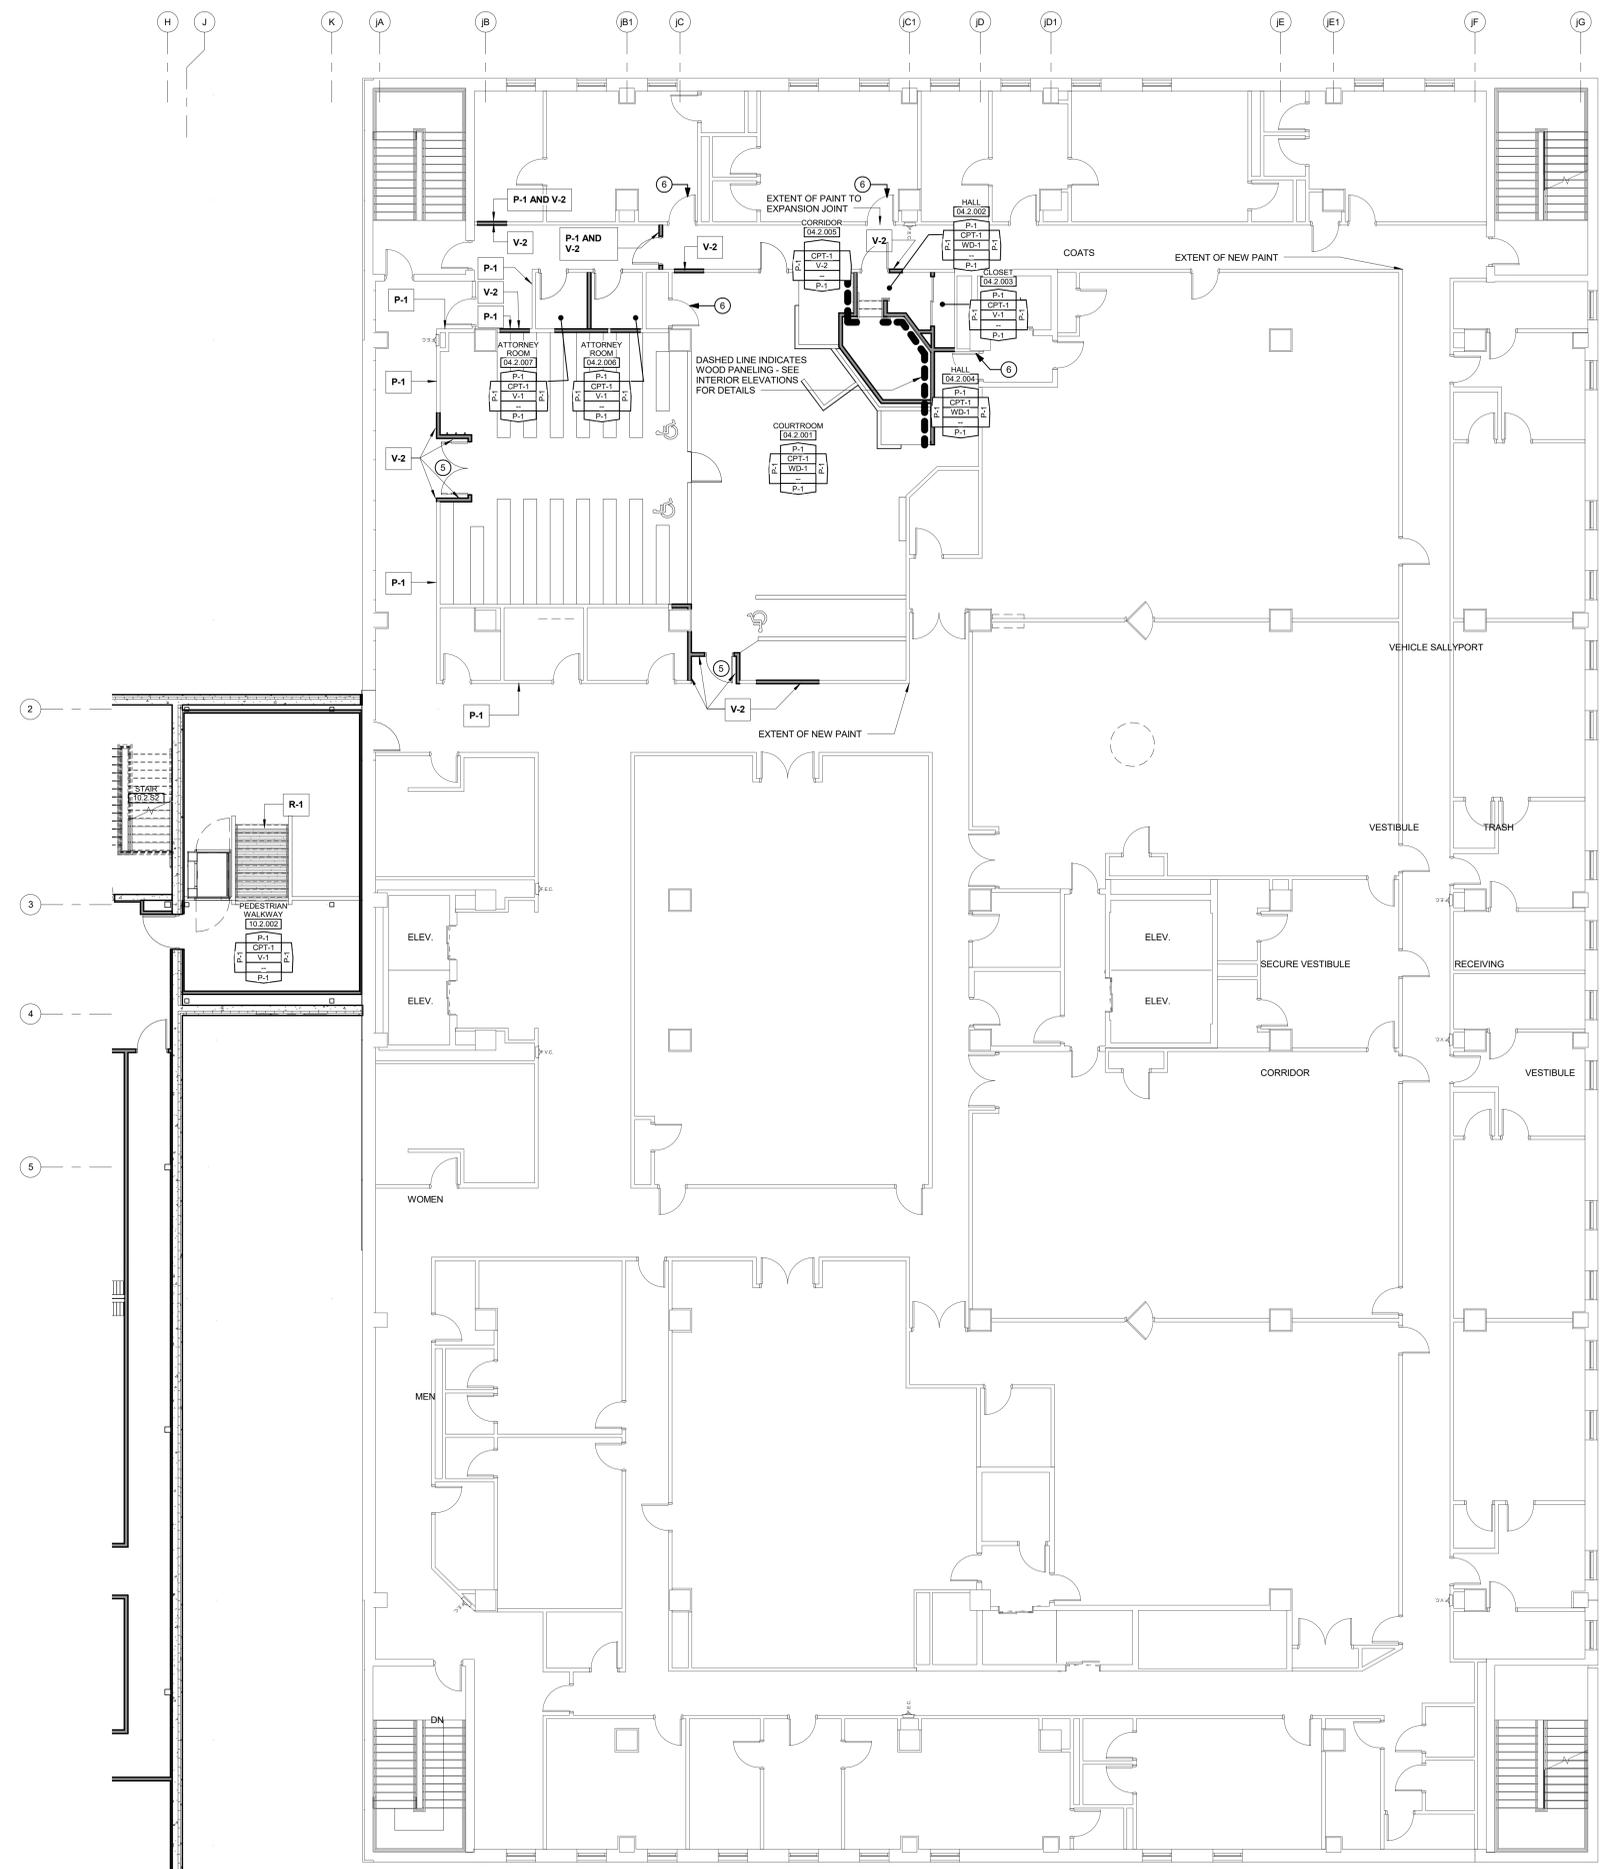

ENLARGED FLOOR PLAN
 NORTH
 1/8" = 1'-0"




PLAN KEY
 NOT TO SCALE
 NORTH

GENERAL FINISH NOTES

- EXISTING FINISHES TO REMAIN UNLESS NOTED OTHERWISE ON FINISH PLAN OR IN OTHER AREAS OF THE DOCUMENTS.
 - SEE GENERAL DEMOLITION DRAWINGS FOR IMPORTANT ADDITIONAL FLOOR FINISH INFORMATION.
 - SEE SPECIFICATIONS FOR SPECIFIC FINISH INFORMATION.
 - ALL EXPOSED STEEL TO BE ARCHITECTURALLY FINISHED AND PAINTED. ALL EXPOSED STEEL COLUMNS AND RAILS TO RECEIVE PAINT TO BE ARCHITECTURALLY FINISHED PER SPECIFICATION SECTION 05.12.13.00.
 - SEE REFLECTED CEILING PLAN FOR CEILING FINISHES.
 - COORDINATE FLOORING WITH PLUMBING FLOOR DRAINS. SEE PLUMBING PLANS FOR LOCATIONS.
 - BASE TO BE 6" IN TOILET ROOMS.
 - EXPOSED CEILING TO BE PAINTED (INCLUDES DUCTWORK, CONDUIT, STRUCTURE, ETC.)
 - VERIFY CONCRETE SLAB RECESSES FOR FLOORING WITH STRUCTURAL AND MANUFACTURER REQUIREMENTS AT TERRAZZO FLOORING LOCATIONS.
- PLAN KEYED NOTES**
- PATCH CARPET TILES AS REQUIRED AND INSTALL BASE AS REQUIRED FOR NEW CONSTRUCTION.
 - PAINT EXISTING DOOR FRAME. PREP AS NECESSARY.

FINISH PLAN LEGEND

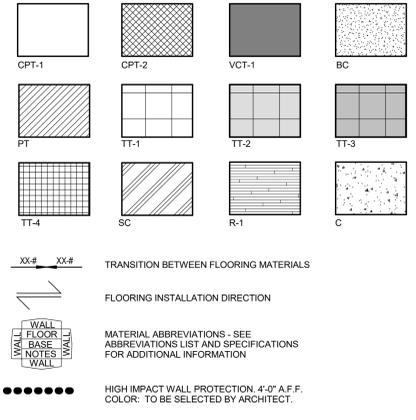

ROOM FINISH ABBREVIATIONS

FLOORS	DESCRIPTION
CPT-1	MODULAR CARPET: INTERFACE: GRILLWORK. COLOR: CONSTRUCTION 5994. PATTERN: 13812, QUARTER TURN. COORDINATE REQUIRED QUANTITIES OF NEW MATERIAL WITH EXISTING AVAILABLE FOR RE-USE. SEE DEMOLITION DRAWINGS. ANY EXISTING CARPET IDENTIFIED AS BEING AVAILABLE FOR RE-USE, BUT DEEMED UNUSABLE BY THE OWNER, SHALL BE SITE CLEARED AT NO EXTRA CHARGE TO THE OWNER. THE CONTRACTOR SHALL SUPPLY AN APPROPRIATE QUANTITY OF NEW CARPET TO MEET THE REQUIREMENTS OF THE CONSTRUCTION DOCUMENTS AND FOR A COMPLETE PROJECT AS PART OF THE BASE BID.
CPT-2	MODULAR CARPET: INTERFACE: GRILLWORK. COLOR: TO BE SELECTED BY ARCHITECT. PATTERN: QUARTER TURN.
TT-1	TERRAZZO TILE: TECTURA: 18" X 18" TERRAZZO TILE. COLOR: TZ15 GRAY MATTER.
TT-2	TERRAZZO TILE: TECTURA: 18" X 18" TERRAZZO TILE. COLOR: TZ80 NORTHERN LIGHTS.
TT-3	TERRAZZO TILE: TECTURA: 18" X 18" TERRAZZO TILE. COLOR: TZ19 EARTHBOUND.
TT-4	PRECAST EPOXY TERRAZZO SELF-SUPPORTING STAIR TREAD. COLOR: TZ80 NORTHERN LIGHTS.
VCT-1	VINYL COMPOSITION TILE: COLOR: SELECTED BY ARCHITECT, 12"X12".
PT	PORCELAIN TILE: SEE ENLARGED RESTROOM FLOOR PLANS FOR SPECIFIC LOCATIONS OF THE BELOW: PT-1: PORCELAIN TILE: FACTORY MOUNTED GLAZED CERAMIC TILE. COLOR: MATCH EXISTING. PT-2: PORCELAIN TILE: FACTORY MOUNTED GLAZED CERAMIC TILE. COLOR: MATCH EXISTING. PT-3: PORCELAIN TILE: FACTORY MOUNTED GLAZED CERAMIC TILE. COLOR: MATCH EXISTING.
SC	SEALED CONCRETE.
BC	SEALED CONCRETE, BROOM FINISH.
C	CONCRETE.
R-1	RUBBER, NORA: RUBBER TREADS AND RISERS. COLOR: TO BE SELECTED BY ARCHITECT.
EX-T	EXISTING TERRAZZO: STRIP AND CLEAN EXISTING TERRAZZO FLOORS - SEE SPECIFICATIONS
BASE	DESCRIPTION
V-1	VINYL: ARMSTRONG, JOHNSONITE, VPI. COLOR: TO BE SELECTED BY ARCHITECT, 4"
V-2	VINYL BASE TO MATCH EXISTING. FIELD VERIFY COLOR.
PT-1	PORCELAIN TILE: FACTORY MOUNTED GLAZED CERAMIC TILE. COLOR: MATCH EXISTING. COVED
WD	WOOD BASE
TT-1	TERRAZZO TILE: TECTURA. COLOR: TZ15 GRAY MATTER. 4" HEIGHT, BEVELED TOP.
TT-3	TERRAZZO TILE: TECTURA. COLOR: TZ19 EARTHBOUND. 4" HEIGHT, BEVELED TOP.
WALLS	DESCRIPTION
P-1	PAINT: PITTSBURGH PAINTS: SPEEDHIDE INTERIOR FLAT LATEX. COLOR: WHITE ROCK 511-2
P-2	PAINT: PITTSBURGH PAINTS. COLOR: TO BE SELECTED BY ARCHITECT.
P-3	PAINT: PITTSBURGH PAINTS. COLOR: TO BE SELECTED BY ARCHITECT.
EP	EPOXY PAINT: PITTSBURGH PAINTS. COLOR: TO BE SELECTED BY ARCHITECT
WD	WOOD PANELING: MATCH WOOD DOOR FINISH
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McMAHON ENGINEERS ARCHITECTS
 ENGINEERS ARCHITECTS
 1000 N. WISCONSIN ST., SUITE 200, NEENAH, WI 54956-1005
 Tel: (920) 751-4200 Fax: (920) 751-4284
 www.mcmgrps.com

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NO.	DATE	REVISION

DESIGNED: **ASF/MAG** DRAWN: **BLG**
 PROJECT NO.: 0002-61600160
 DATE: MARCH 3, 2017
 SHEET NO.: **A258**

ALTERATION / ADDITION
OUTAGAMIE COUNTY ADMINISTRATION CENTER
S. WALNUT & W. 8TH, APPLETON WI 54911
LEVEL 805.00 ENLARGED FINISH PLAN - JUSTICE CENTER


GENERAL FINISH NOTES

- EXISTING FINISHES TO REMAIN UNLESS NOTED OTHERWISE ON FINISH PLAN OR IN OTHER AREAS OF THE DOCUMENTS.
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- BASE TO BE 6" IN TOILET ROOMS.
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- VERIFY CONCRETE SLAB RECESSES FOR FLOORING WITH STRUCTURAL AND MANUFACTURER REQUIREMENTS AT TERRAZZO FLOORING LOCATIONS.

PLAN KEYED NOTES

- PAINT EXISTING DOOR FRAME. PREP AS NECESSARY.
- PATCH EXISTING CERAMIC TILE WALL WHERE TRIM IS REMOVED.

FINISH PLAN LEGEND

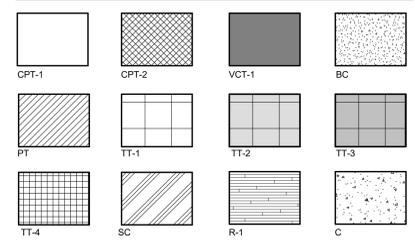

XX# XX# TRANSITION BETWEEN FLOORING MATERIALS


FLOORING INSTALLATION DIRECTION

MATERIAL ABBREVIATIONS - SEE ABBREVIATIONS LIST AND SPECIFICATIONS FOR ADDITIONAL INFORMATION

HIGH IMPACT WALL PROTECTION. 4'-0" A.F.F. COLOR: TO BE SELECTED BY ARCHITECT.

ROOM FINISH ABBREVIATIONS

- FLOORS**
- CPT-1 MODULAR CARPET. INTERFACE: GRILLWORK. COLOR: CONSTRUCTION 5994. PATTERN: 13812. QUARTER TURN. COORDINATE REQUIRED QUANTITIES OF NEW MATERIAL WITH EXISTING AVAILABLE FOR RE-USE. SEE DEMOLITION DRAWINGS. ANY EXISTING CARPET IDENTIFIED AS BEING AVAILABLE FOR RE-USE, BUT DEEMED UNUSABLE BY THE OWNER, SHALL BE SITE CLEARED AT NO EXTRA CHARGE TO THE OWNER. THE CONTRACTOR SHALL SUPPLY AN APPROPRIATE QUANTITY OF NEW CARPET TO MEET THE REQUIREMENTS OF THE CONSTRUCTION DOCUMENTS AND FOR A COMPLETE PROJECT AS PART OF THE BASE BID.
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 - TT-3 TERRAZZO TILE: TECTURA. 18" X 18" TERRAZZO TILE. COLOR: TZ19 EARTHBOUND.
 - TT-4 PRECAST EPOXY TERRAZZO SELF-SUPPORTING STAIR TREAD. COLOR: TZ80 NORTHERN LIGHTS.
 - VCT-1 VINYL COMPOSITION TILE. COLOR: SELECTED BY ARCHITECT. 12"x12"
 - PT PORCELAIN TILE. SEE ENLARGED RESTROOM FLOOR PLANS FOR SPECIFIC LOCATIONS OF THE BELOW.
 - PT-1 PORCELAIN TILE: FACTORY MOUNTED GLAZED CERAMIC TILE. COLOR: MATCH EXISTING.
 - PT-3 PORCELAIN TILE: FACTORY MOUNTED GLAZED CERAMIC TILE. COLOR: MATCH EXISTING.
- BASE**
- V-1 VINYL: ARMSTRONG, JOHNSONITE, VPI. COLOR: TO BE SELECTED BY ARCHITECT. 4"
 - V-2 VINYL: BASE TO MATCH EXISTING. FIELD VERIFY COLOR.
 - PT-1 PORCELAIN TILE: FACTORY MOUNTED GLAZED CERAMIC TILE. COLOR: MATCH EXISTING. COVERED.
 - WD WOOD BASE
 - TT-1 TERRAZZO TILE: TECTURA. COLOR: TZ15 GRAY MATTER. 4" HEIGHT, BEVELED TOP.
 - TT-3 TERRAZZO TILE: TECTURA. COLOR: TZ19 EARTHBOUND. 4" HEIGHT, BEVELED TOP.
- WALLS**
- P-1 PAINT: PITTSBURGH PAINTS. SPEEDHIDE INTERIOR FLAT LATEX. COLOR: WHITE ROCK 5112.
 - P-2 PAINT: PITTSBURGH PAINTS. COLOR: TO BE SELECTED BY ARCHITECT.
 - P-3 PAINT: PITTSBURGH PAINTS. COLOR: TO BE SELECTED BY ARCHITECT.
 - EP EPOXY PAINT: PITTSBURGH PAINTS. COLOR: TO BE SELECTED BY ARCHITECT
 - WD WOOD PANELING: MATCH WOOD DOOR FINISH
 - PT PORCELAIN TILE: SEE INTERIOR ELEVATIONS FOR SPECIFIC LOCATIONS OF THE BELOW.
 - PT-1 PORCELAIN TILE: FACTORY MOUNTED GLAZED CERAMIC TILE. COLOR: MATCH EXISTING.
 - PT-2 PORCELAIN TILE: FACTORY MOUNTED GLAZED CERAMIC TILE. COLOR: MATCH EXISTING.
 - PT-3 PORCELAIN TILE: FACTORY MOUNTED GLAZED CERAMIC TILE. COLOR: MATCH EXISTING.

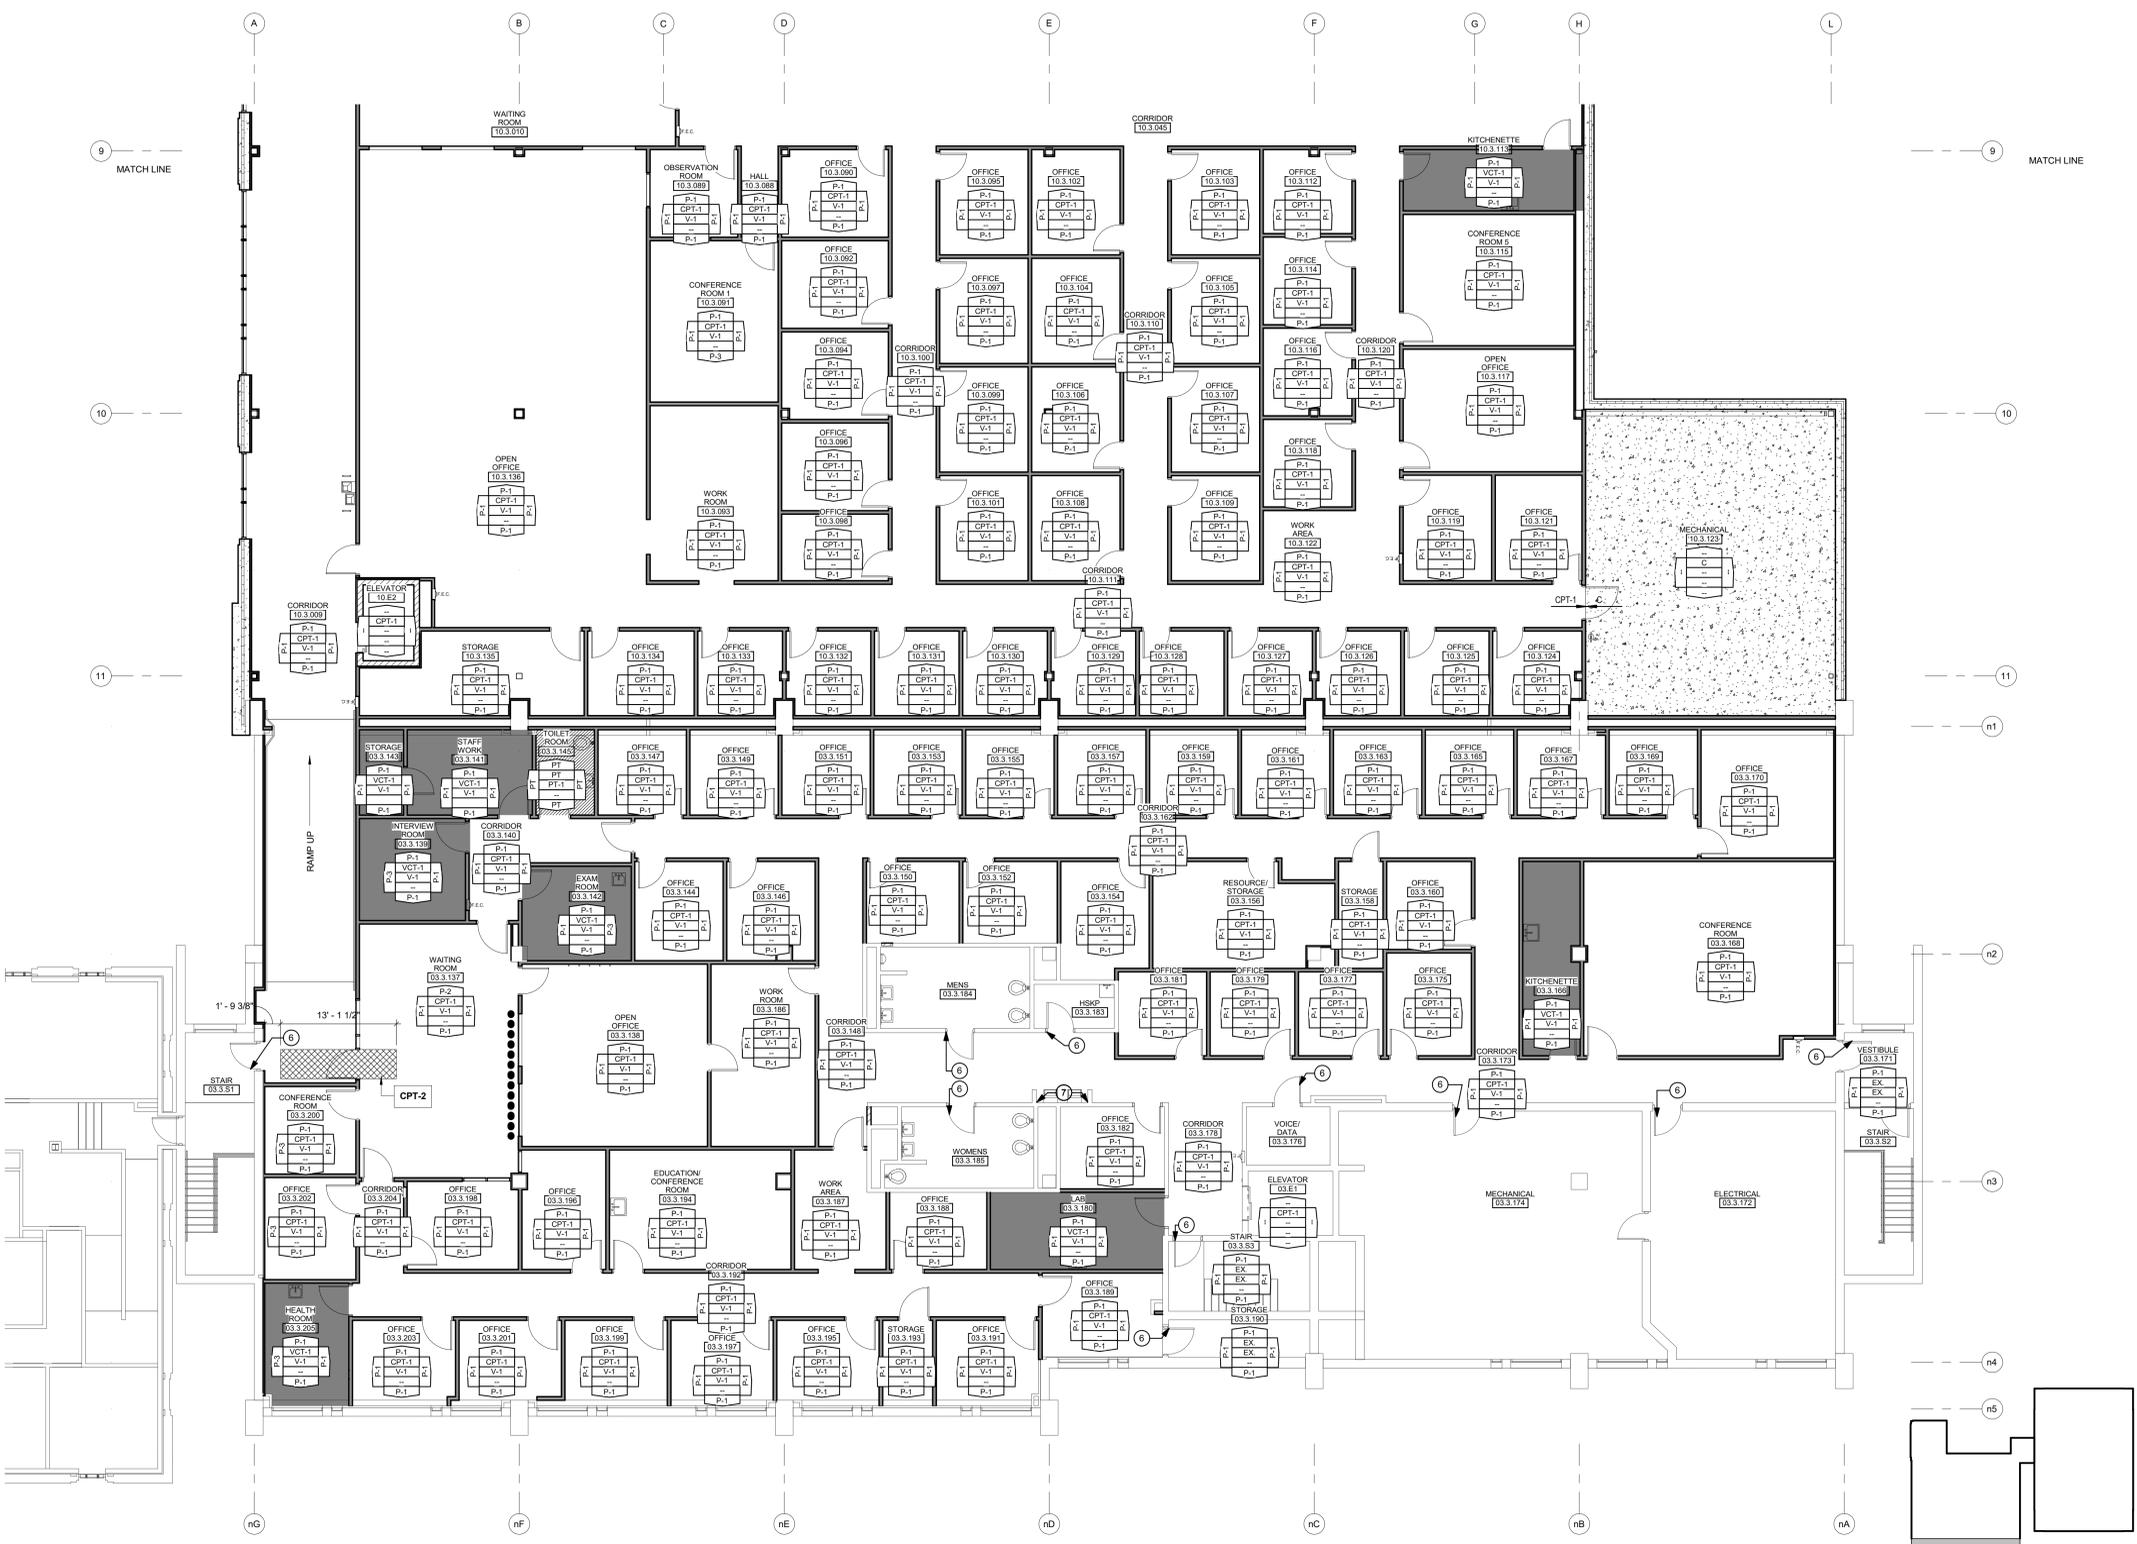

1 ENLARGED FLOOR PLAN
A259 1/8" = 1'-0"

PLAN KEY
NOT TO SCALE

ALTERATION / ADDITION
OUTAGAME COUNTY ADMINISTRATION CENTER
S. WALNUT & W. 8TH, APPLETON WI 54911
LEVEL 820.00 ENLARGED FINISH PLAN - HHS NORTH/CAC SOUTH

DESIGNED	DRAWN
ASF/MAG	BLG
PROJECT NO. 0002-61600160	
DATE MARCH 3, 2017	
SHEET NO. A259	




GENERAL FINISH NOTES

- EXISTING FINISHES TO REMAIN UNLESS NOTED OTHERWISE ON FINISH PLAN OR IN OTHER AREAS OF THE DOCUMENTS.
- SEE GENERAL DEMOLITION DRAWINGS FOR IMPORTANT ADDITIONAL FLOOR FINISH INFORMATION.
- SEE SPECIFICATIONS FOR SPECIFIC FINISH INFORMATION.
- ALL EXPOSED STEEL TO BE ARCHITECTURALLY FINISHED AND PAINTED. ALL EXPOSED STEEL COLUMNS AND RAILS TO RECEIVE PAINT. TO BE ARCHITECTURALLY FINISHED PER SPECIFICATION SECTION 05.12.13.00.
- SEE REFLECTED CEILING PLAN FOR CEILING FINISHES.
- COORDINATE FLOORING WITH PLUMBING FLOOR DRAINS. SEE PLUMBING PLANS FOR LOCATIONS.
- BASE TO BE 6" IN TOILET ROOMS.
- EXPOSED CEILINGS TO BE PAINTED (INCLUDES DUCTWORK, CONDUIT, STRUCTURE, ETC.)
- VERIFY CONCRETE SLAB RECESSES FOR FLOORING WITH STRUCTURAL AND MANUFACTURER REQUIREMENTS AT TERRAZZO FLOORING LOCATIONS.

PLAN KEYED NOTES

FINISH PLAN LEGEND

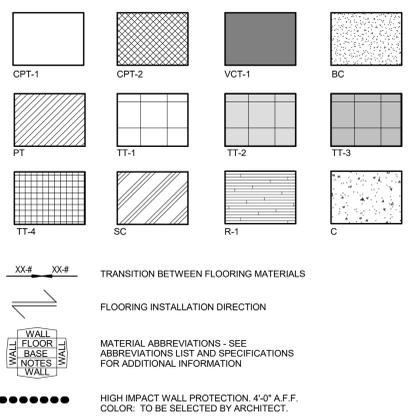

ROOM FINISH ABBREVIATIONS


- FLOORS**
- CPT-1** MODULAR CARPET: INTERFACE: GRILLWORK. COLOR: CONSTRUCTION 5894. PATTERN: 13812. QUARTER TURN. COORDINATE REQUIRED QUANTITIES OF NEW MATERIAL WITH EXISTING AVAILABLE FOR RE-USE. SEE DEMOLITION DRAWINGS. ANY EXISTING CARPET IDENTIFIED AS BEING AVAILABLE FOR RE-USE, BUT DEEMED UNUSABLE BY THE OWNER, SHALL BE SITE CLEARED AT NO EXTRA CHARGE TO THE OWNER. THE CONTRACTOR SHALL SUPPLY AN APPROPRIATE QUANTITY OF NEW CARPET TO MEET THE REQUIREMENTS OF THE CONSTRUCTION DOCUMENTS AND FOR A COMPLETE PROJECT AS PART OF THE BASE BID.
 - CPT-2** MODULAR CARPET: INTERFACE: GRILLWORK. COLOR: TO BE SELECTED BY ARCHITECT. PATTERN: QUARTER TURN.
 - TT-1** TERRAZZO TILE: TECTURA: 18" X 18" TERRAZZO TILE. COLOR: TZ15 GRAY MATTER.
 - TT-2** TERRAZZO TILE: TECTURA: 18" X 18" TERRAZZO TILE. COLOR: TZ80 NORTHERN LIGHTS.
 - TT-3** TERRAZZO TILE: TECTURA: 18" X 18" TERRAZZO TILE. COLOR: TZ19 EARTHBOUND.
 - TT-4** PRECAST EPOXY TERRAZZO TILE-SUPPORTING STAIR TREAD. COLOR: TZ80 NORTHERN LIGHTS.
 - VCT-1** VINYL COMPOSITION TILE: COLOR: SELECTED BY ARCHITECT, 12"X12".
 - PT** PORCELAIN TILE: SEE ENLARGED RESTROOM FLOOR PLANS FOR SPECIFIC LOCATIONS OF THE BELOW:
 - PT-1** PORCELAIN TILE: FACTORY MOUNTED GLAZED CERAMIC TILE. COLOR: MATCH EXISTING.
 - PT-2** PORCELAIN TILE: FACTORY MOUNTED GLAZED CERAMIC TILE. COLOR: MATCH EXISTING.
 - PT-3** PORCELAIN TILE: FACTORY MOUNTED GLAZED CERAMIC TILE. COLOR: MATCH EXISTING.
 - SC** SEALED CONCRETE.
 - BC** SEALED CONCRETE, BROOM FINISH.
 - C** CONCRETE
 - R-1** RUBBER: NORA: RUBBER TREADS AND RISERS. COLOR: TO BE SELECTED BY ARCHITECT.
 - EX-T** EXISTING TERRAZZO: STRIP AND CLEAN EXISTING TERRAZZO FLOORS - SEE SPECIFICATIONS
- BASE**
- V-1** VINYL: ARMSTRONG, JOHNSONITE, VPI. COLOR: TO BE SELECTED BY ARCHITECT. 4"
 - V-2** VINYL BASE TO MATCH EXISTING. FIELD VERIFY COLOR.
 - PT-1** PORCELAIN TILE: FACTORY MOUNTED GLAZED CERAMIC TILE. COLOR: MATCH EXISTING, COVED
 - WD** WOOD BASE
 - TT-1** TERRAZZO TILE: TECTURA. COLOR: TZ15 GRAY MATTER. 4" HEIGHT, BEVELED TOP.
 - TT-3** TERRAZZO TILE: TECTURA. COLOR: TZ19 EARTHBOUND. 4" HEIGHT, BEVELED TOP.
- WALLS**
- P-1** PAINT: PITTSBURGH PAINTS: SPEEDHIDE INTERIOR FLAT LATEX. COLOR: WHITE ROCK 511-2
 - P-2** PAINT: PITTSBURGH PAINTS. COLOR: TO BE SELECTED BY ARCHITECT.
 - P-3** PAINT: PITTSBURGH PAINTS. COLOR: TO BE SELECTED BY ARCHITECT.
 - EP** EPOXY PAINT: PITTSBURGH PAINTS. COLOR: TO BE SELECTED BY ARCHITECT
 - WD** WOOD PANELING: MATCH WOOD DOOR FINISH
 - PT** PORCELAIN TILE: SEE INTERIOR ELEVATIONS FOR SPECIFIC LOCATIONS OF THE BELOW:
 - PT-1** PORCELAIN TILE: FACTORY MOUNTED GLAZED CERAMIC TILE. COLOR: MATCH EXISTING.
 - PT-2** PORCELAIN TILE: FACTORY MOUNTED GLAZED CERAMIC TILE. COLOR: MATCH EXISTING.
 - PT-3** PORCELAIN TILE: FACTORY MOUNTED GLAZED CERAMIC TILE. COLOR: MATCH EXISTING.

1 ENLARGED FLOOR PLAN NORTH
A260 1/8" = 1'-0"

PLAN KEY NORTH
NOT TO SCALE

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NO.	DATE	REVISION

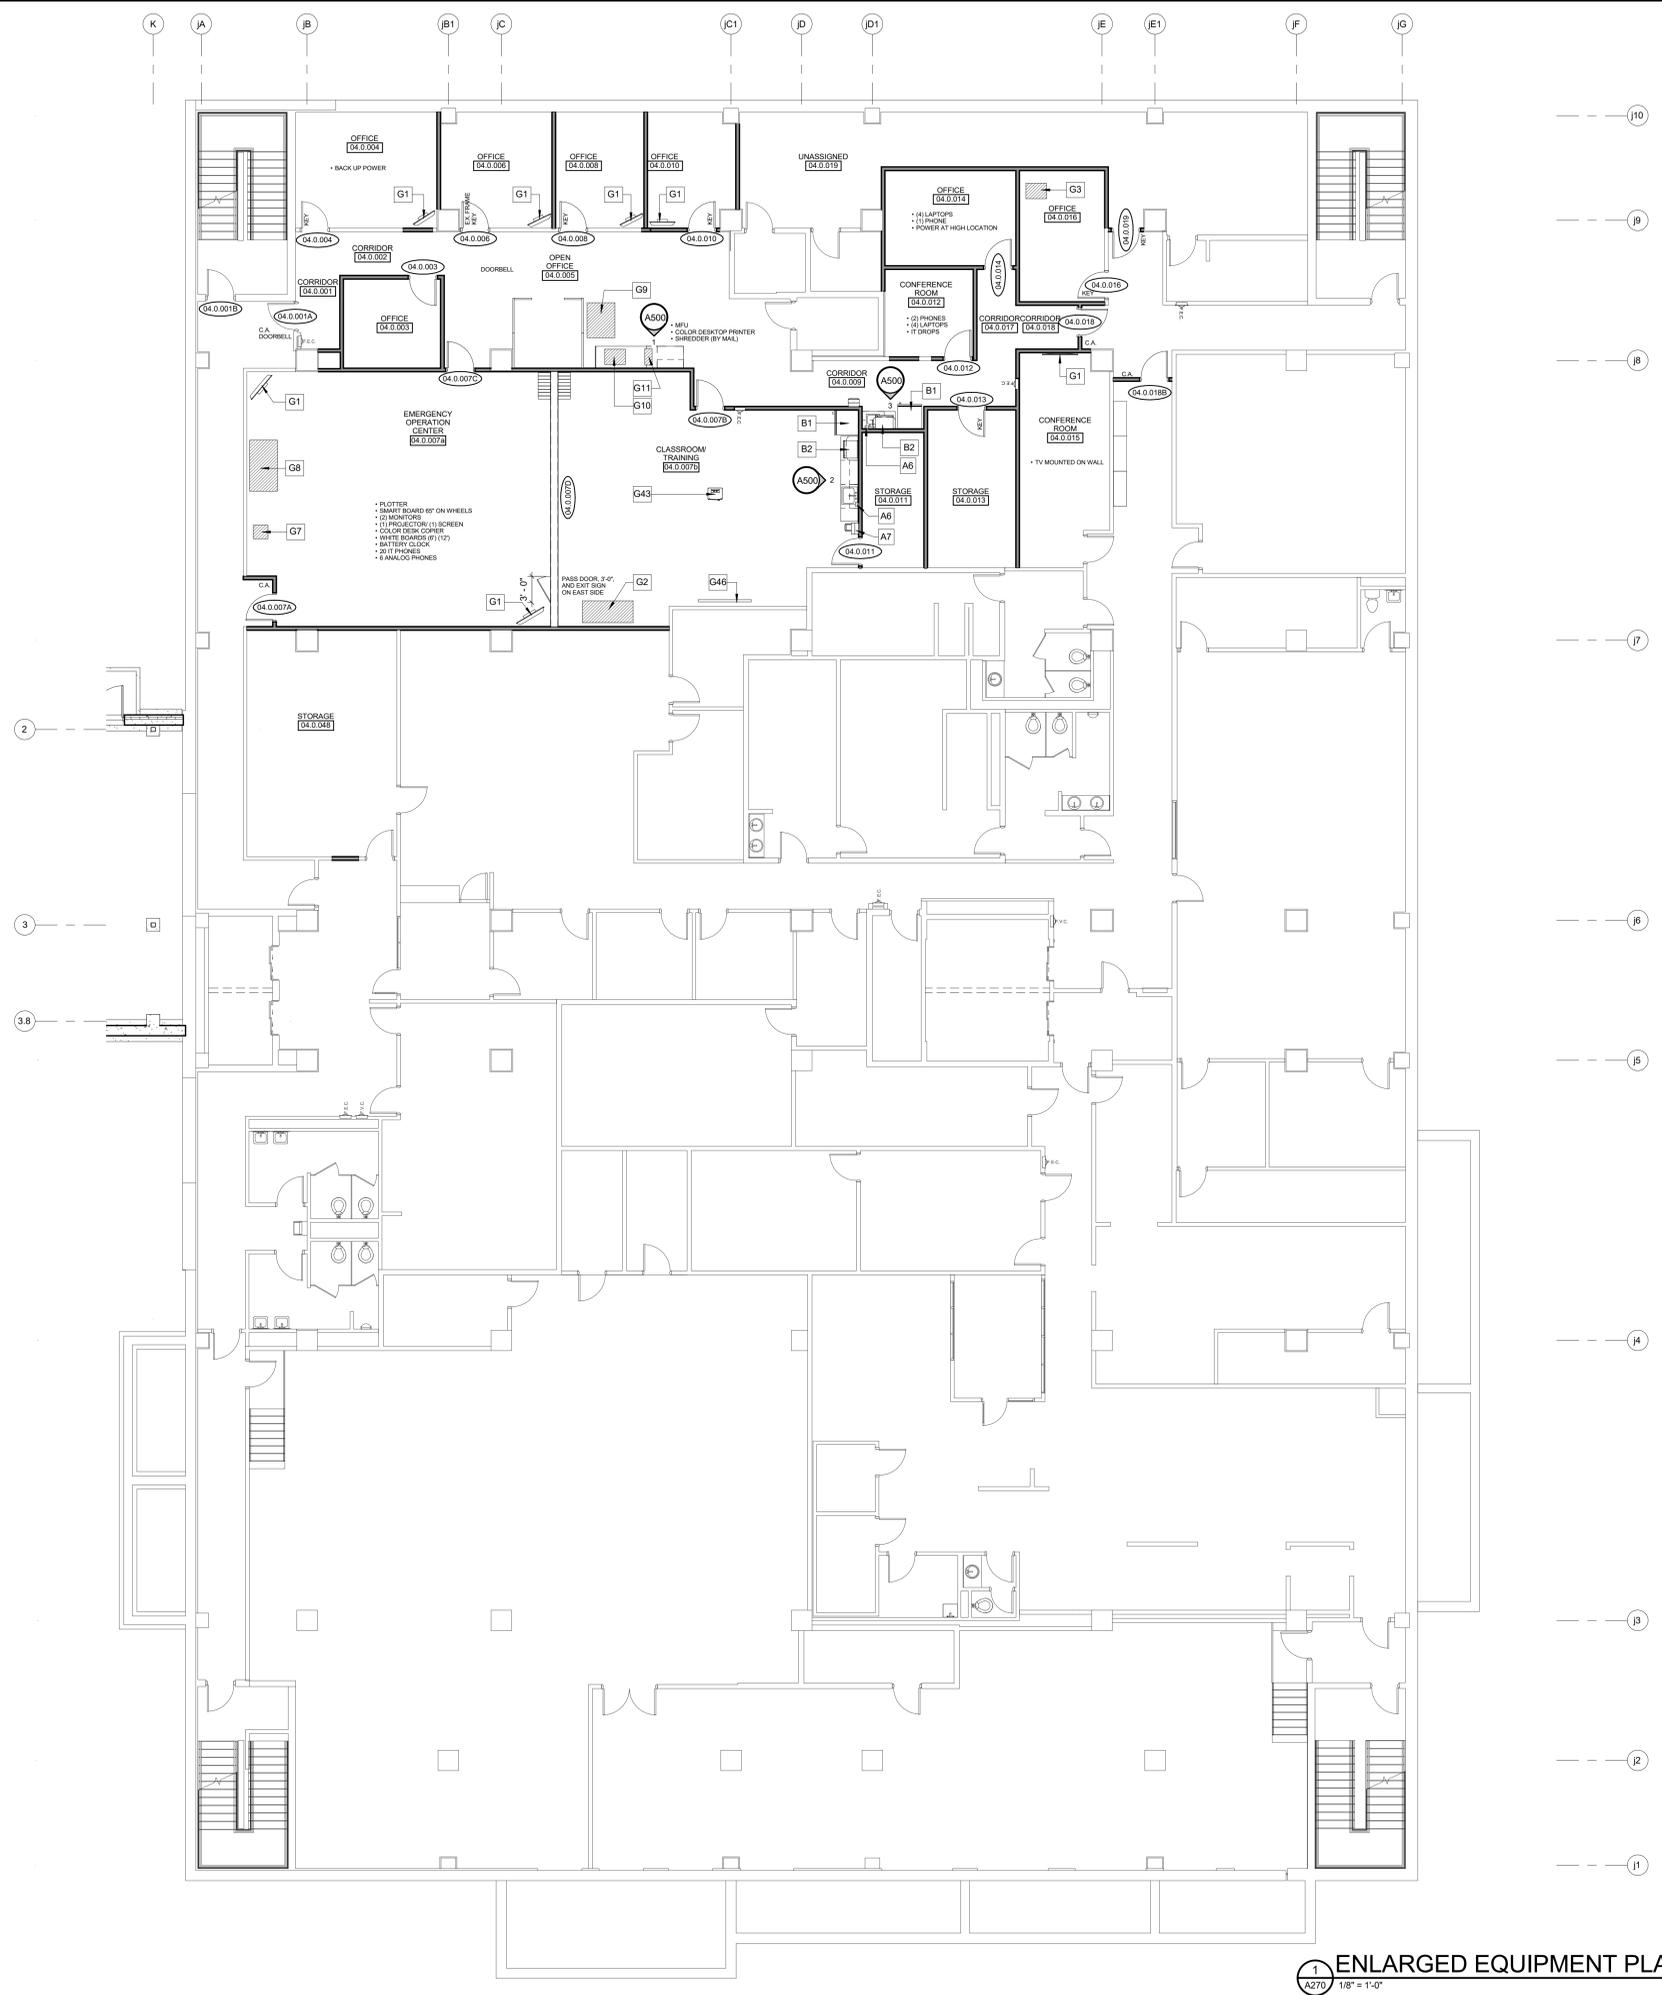

EQUIPMENT SCHEDULE - SHEET A270

MARK	DESCRIPTION	MODEL	FURNISHED BY	INSTALLED BY
A6	SOAP DISPENSER	GOJO, MODEL ADX-7	OWNER	G.C.
A7	PAPER TOWEL DISPENSER	GP ENMOTION, MODEL 99462	OWNER	G.C.
B1	REFRIGERATOR		OWNER	OWNER
B2	MICROWAVE		OWNER	OWNER
G1	MONITOR	SHARP AQUOS	OWNER	OWNER
G3	SMARTBOARD		OWNER	OWNER
G7	PRINTER (LOCAL)		OWNER	OWNER
G8	PLOTTER	HP 6J500 M551	OWNER	OWNER
G9	PRINTER	HP DESIGN JET T790	OWNER	OWNER
G10	MULTI-FUNCTION COPIER		OWNER	OWNER
G11	PRINTER	ENTERPRISE M651	OWNER	OWNER
G43	BADGE PRINTER	DATACARD CP80	OWNER	OWNER
G44	OVERHEAD PROJECTOR		OWNER	OWNER
G46	PROJECTOR SCREEN		OWNER	OWNER

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 WWW.MCMAG.COM


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NO.	DATE	REVISION

ALTERATION / ADDITION
OUTAGAME COUNTY ADMINISTRATION CENTER
S. WALNUT & W. 8TH, APPLETON WI 54911
 LEVEL 700.00 ENLARGED EQUIPMENT PLAN - JUSTICE CENTER

DESIGNED	DRAWN
MAG	BLG
PROJECT NO. 0002-61600160	
DATE MARCH 3, 2017	
SHEET NO. A270	

1
A270
 ENLARGED EQUIPMENT PLAN
 1/8" = 1'-0"

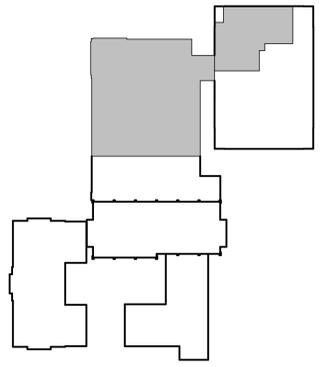


PLAN KEY
 NOT TO SCALE



EQUIPMENT SCHEDULE - SHEET A271				
MARK	DESCRIPTION	MODEL	FURNISHED BY	INSTALLED BY
G43	OVERHEAD PROJECTOR		OWNER	OWNER
G44	WHITEBOARD		OWNER	OWNER

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1025 N. KENNAH, WISCONSIN
MILWAUKEE, WI 53227-1025
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www.mcgrm.com

- PLAN KEYED NOTES**
- 9 VERIFY EXISTING OPENING FOR NEW DOOR REPLACEMENT.
 - 13 RELOCATE EXISTING WHITEBOARD TO THIS LOCATION.
 - 14 RELOCATE EXISTING OVERHEAD PROJECTOR TO THIS LOCATION.

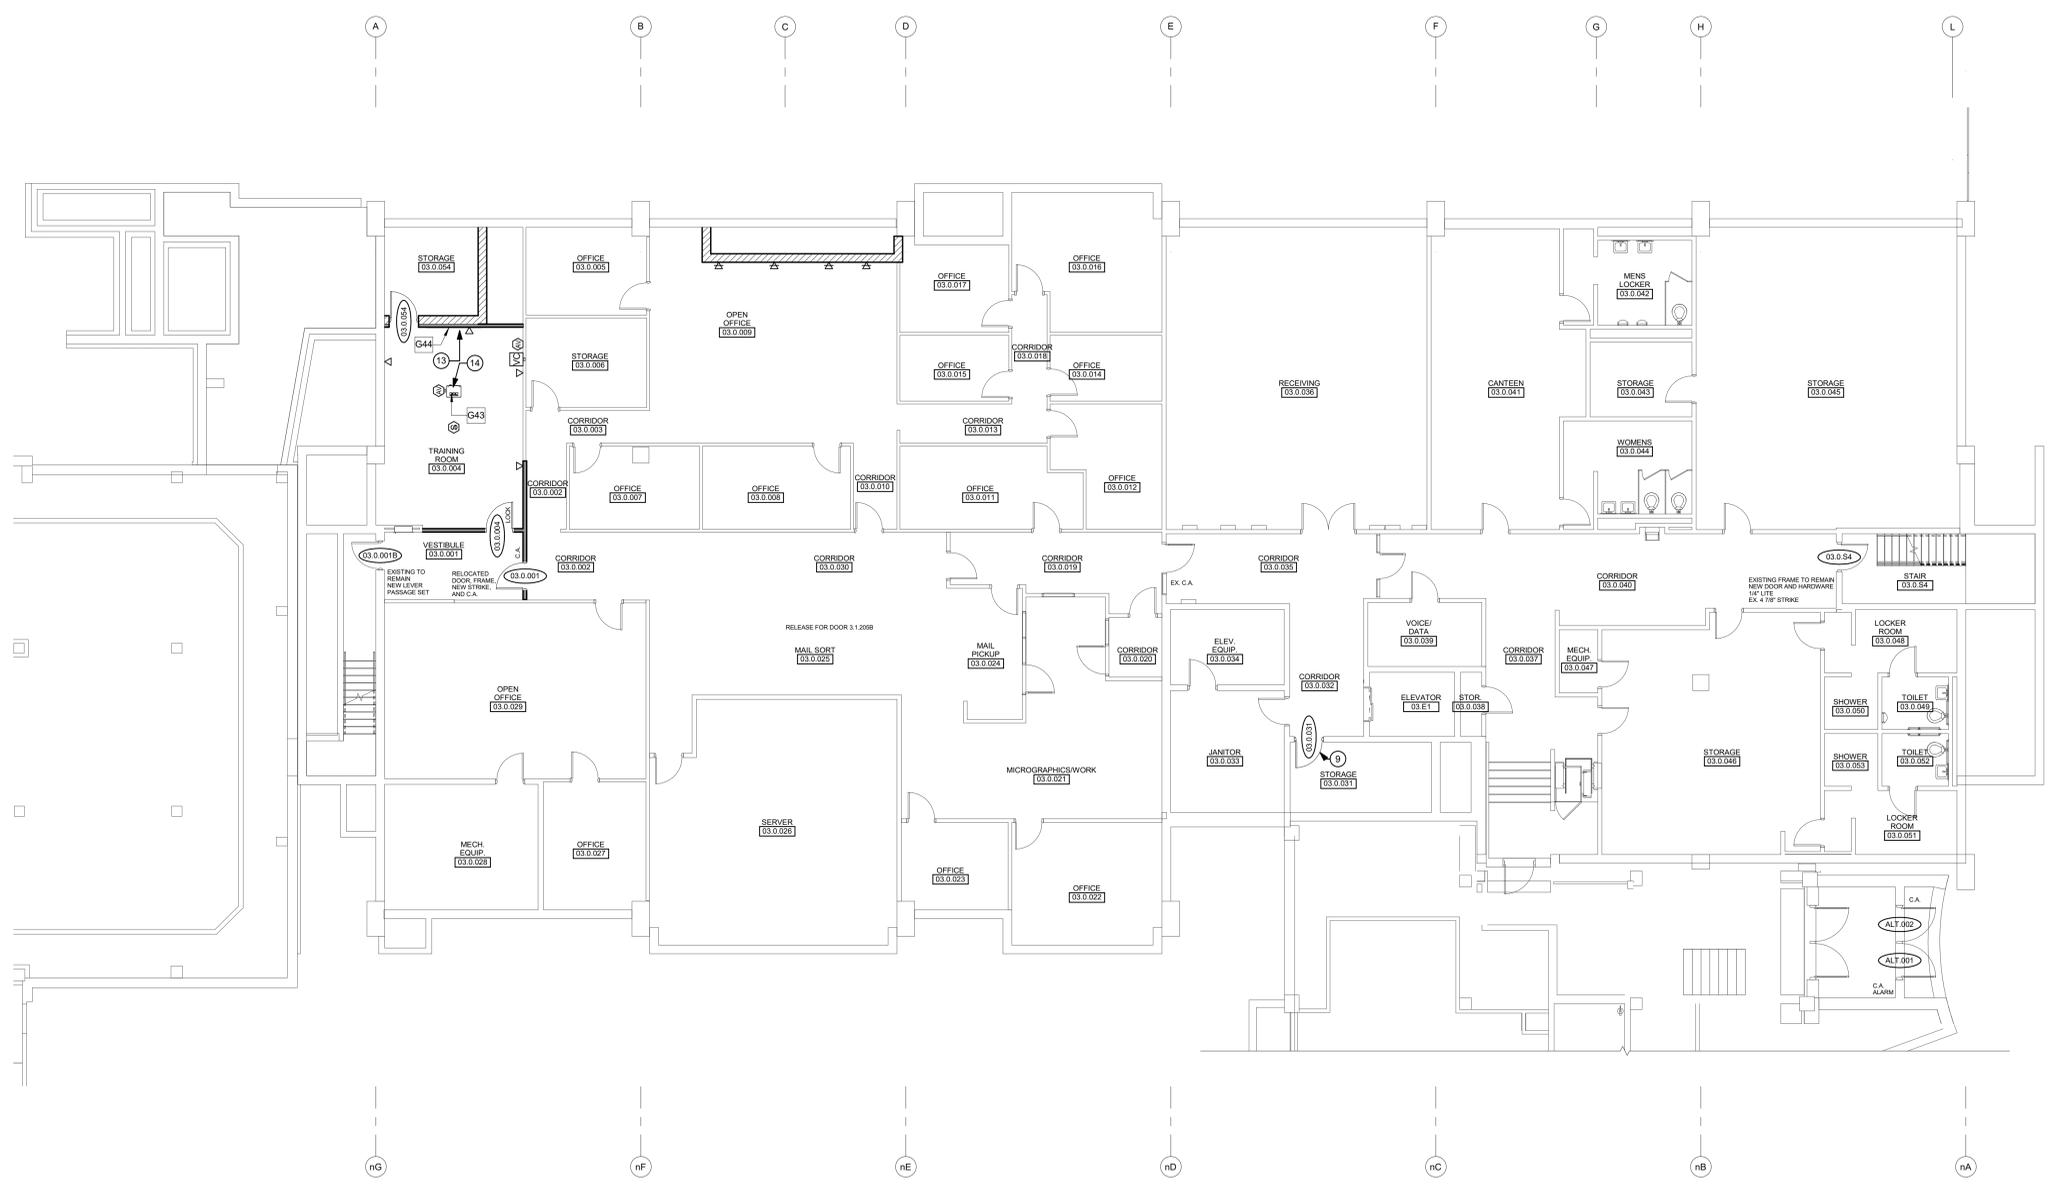


ENLARGED FLOOR PLAN
1 A271 1/8" = 1'-0" NORTH

PLAN KEY
NOT TO SCALE NORTH


ALTERATION / ADDITION
OUTAGAMIE COUNTY ADMINISTRATION CENTER
S. WALNUT & W. 8TH, APPLETON WI 54911
LEVEL 780.00 ENLARGED EQUIPMENT PLAN - HHS NORTH

DESIGNED	DRAWN
MAG	BLG
PROJECT NO. 0002-61600160	
DATE MARCH 3, 2017	
SHEET NO.	


A271

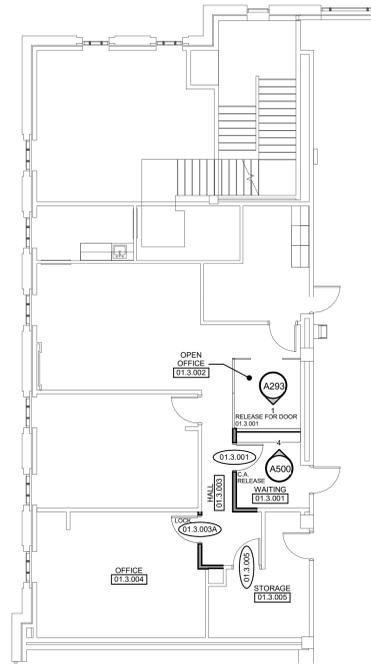


2 ENLARGED EQUIPMENT PLAN
1/8" = 1'-0"

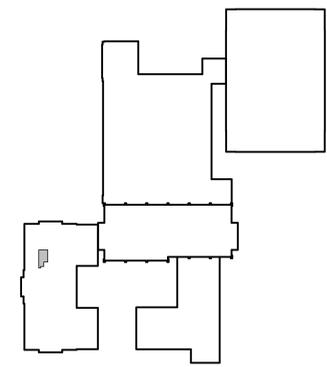

PLAN KEY
NOT TO SCALE

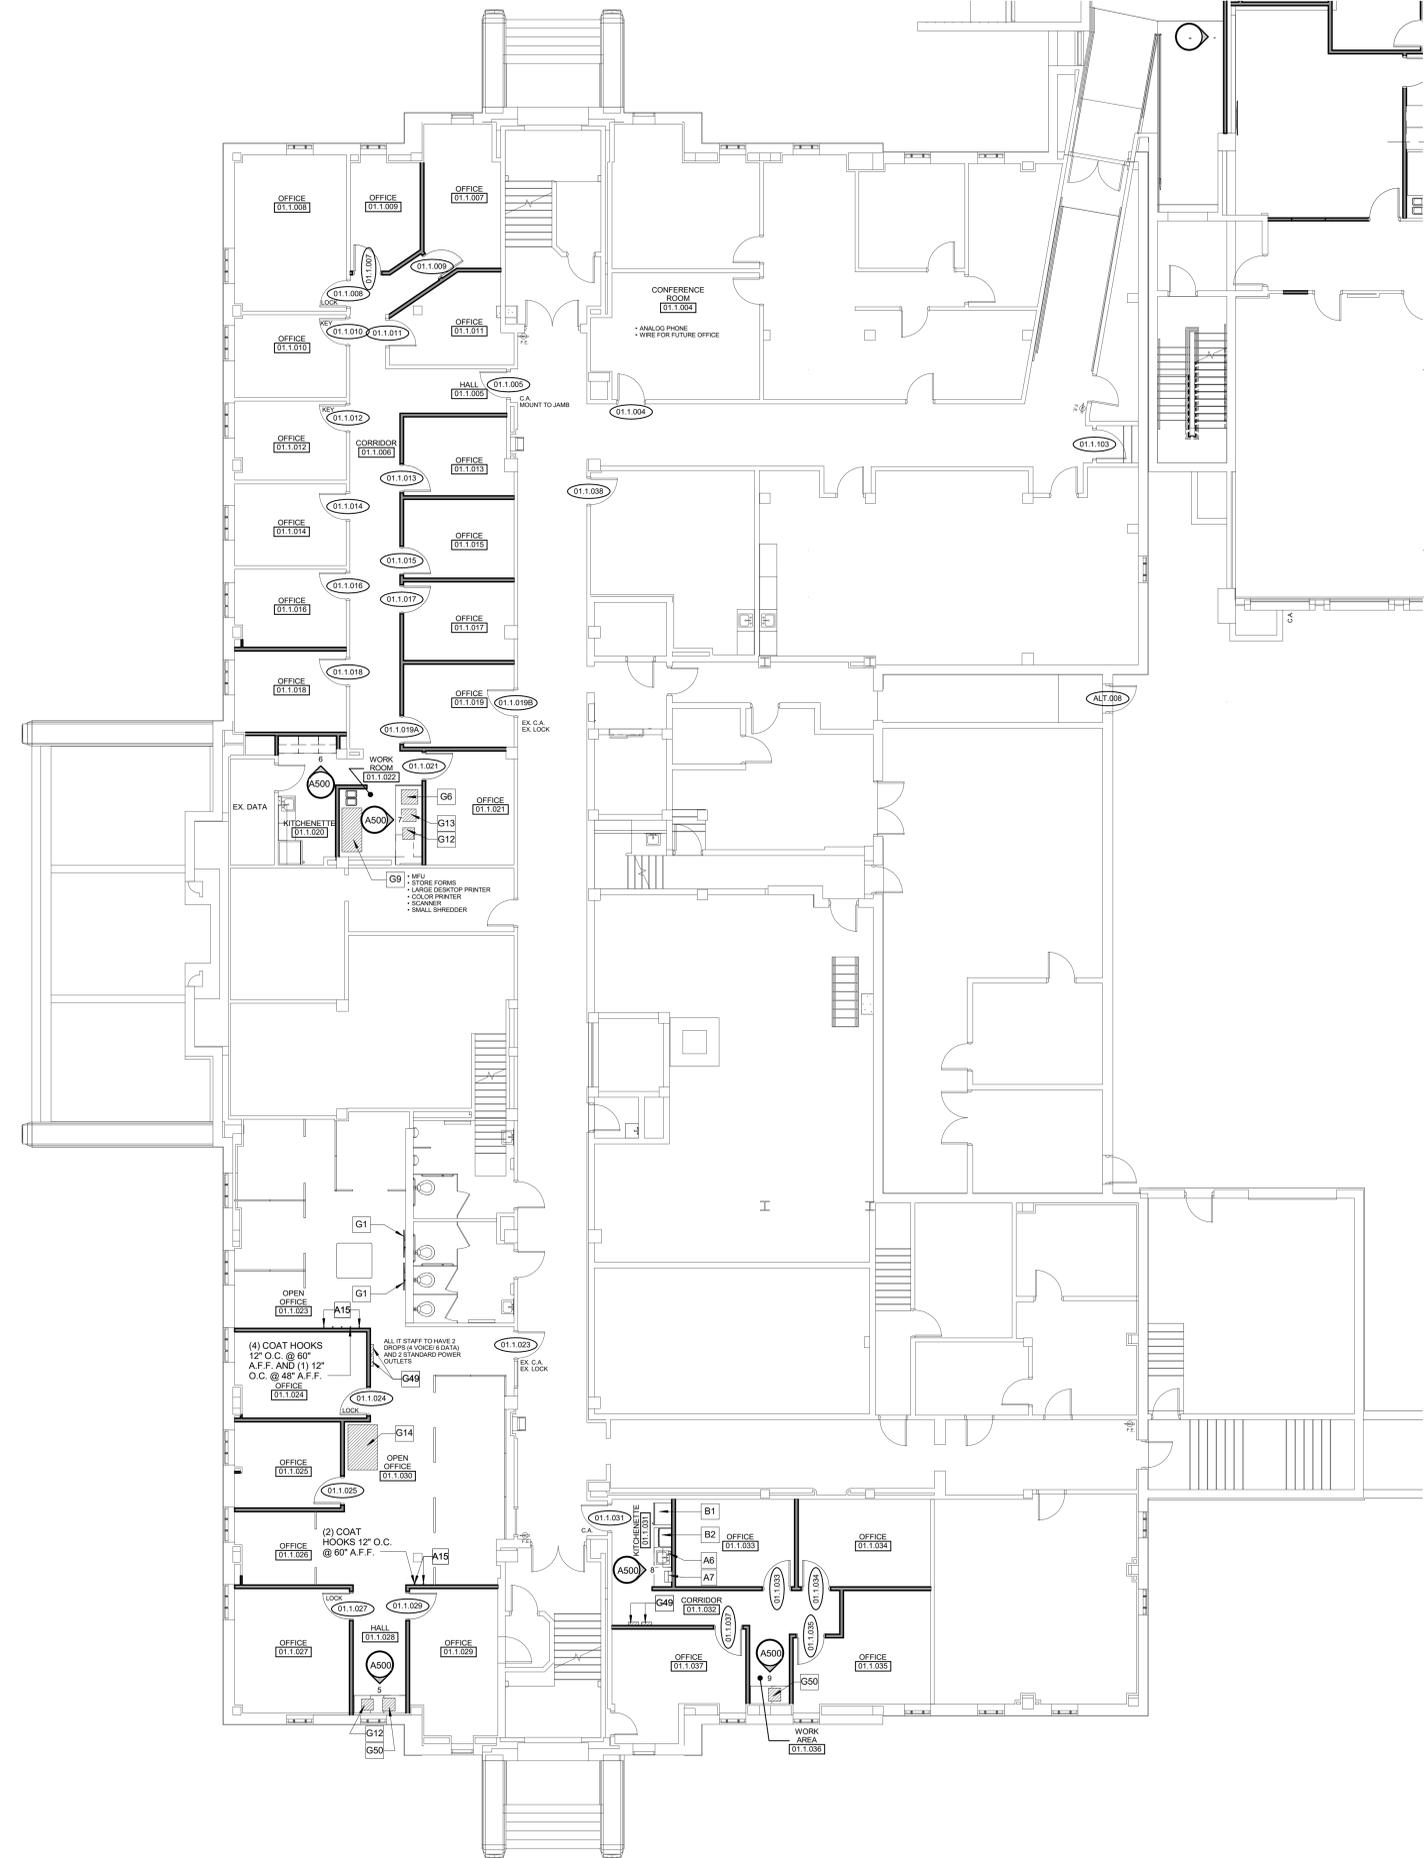

1 ENLARGED EQUIPMENT PLAN
1/8" = 1'-0"

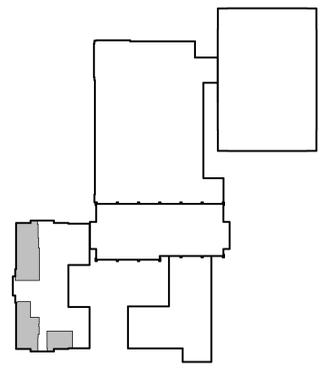

PLAN KEY
NOT TO SCALE

EQUIPMENT SCHEDULE - SHEET A272			
MARK	DESCRIPTION	MODEL	FURNISHED BY / INSTALLED BY
A6	SOAP DISPENSER	GOJO; MODEL ADX-7	OWNER / G.C.
A7	PAPER TOWEL DISPENSER	GP ENMOTION; MODEL 59462	OWNER / G.C.
A15	COAT HOOK	BRADLEY; MODEL 9114 BRADEX	G.C. / G.C.
B1	REFRIGERATOR		OWNER / OWNER
B2	MICROWAVE		OWNER / OWNER
G1	MONITOR (37")		OWNER / OWNER
G6	FAX		OWNER / OWNER
G8	MULTI-FUNCTION COPIER		OWNER / OWNER
G9	PRINTER	HP OFFICEJET 8100	OWNER / OWNER
G13	PRINTER	HP LJ 600 M603	OWNER / OWNER
G14	MULTI-FUNCTION COPIER	XEROX 5225	OWNER / OWNER
G49	WALL HUNG MAIL BINS		OWNER / G.C.
G50	PRINTER	HP LASERJET 600 M802	OWNER / OWNER

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NO.	DATE	REVISION


ALTERATION / ADDITION
OUTAGAME COUNTY ADMINISTRATION CENTER
S. WALNUT & W. 8TH, APPLETON WI 54911
LEVEL 790.00 ENLARGED EQUIPMENT PLAN - CAB


DESIGNED	DRAWN
MAG	BLG
PROJECT NO. 0002-61600160	
DATE MARCH 3, 2017	
SHEET NO. A272	

EQUIPMENT SCHEDULE - SHEET A273

MARK	DESCRIPTION	MODEL	FURNISHED BY	INSTALLED BY
A6	SOAP DISPENSER	GOJO MODEL ADOX-7	OWNER	G.C.
A7	PAPER TOWEL DISPENSER	GP ENMOTION MODEL 59462	OWNER	G.C.
A15	COAT HOOK	BRADLEY MODEL 9114 BRADEX	G.C.	G.C.
B1	REFRIGERATOR		OWNER	OWNER
B2	MICROWAVE		OWNER	OWNER
G1	MONITOR (WALL MOUNTED)		OWNER	OWNER
G3	PRINTER (LOCAL)		OWNER	OWNER
G16	MULTI-FUNCTION COPIER	XEROX WORKCENTRE 5335	OWNER	OWNER
G17	MULTI-FUNCTION COPIER	XEROX WORKCENTRE 5775	OWNER	OWNER
G18	FAX (MAIN)		OWNER	OWNER
G19	FAX (LOBBY)		OWNER	OWNER
G20	MULTI-FUNCTION COPIER	XEROX WORKCENTRE 5135	OWNER	OWNER
G21	PRINTER	HP L3 P4014N	OWNER	OWNER

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 WWW.MCMAG.COM

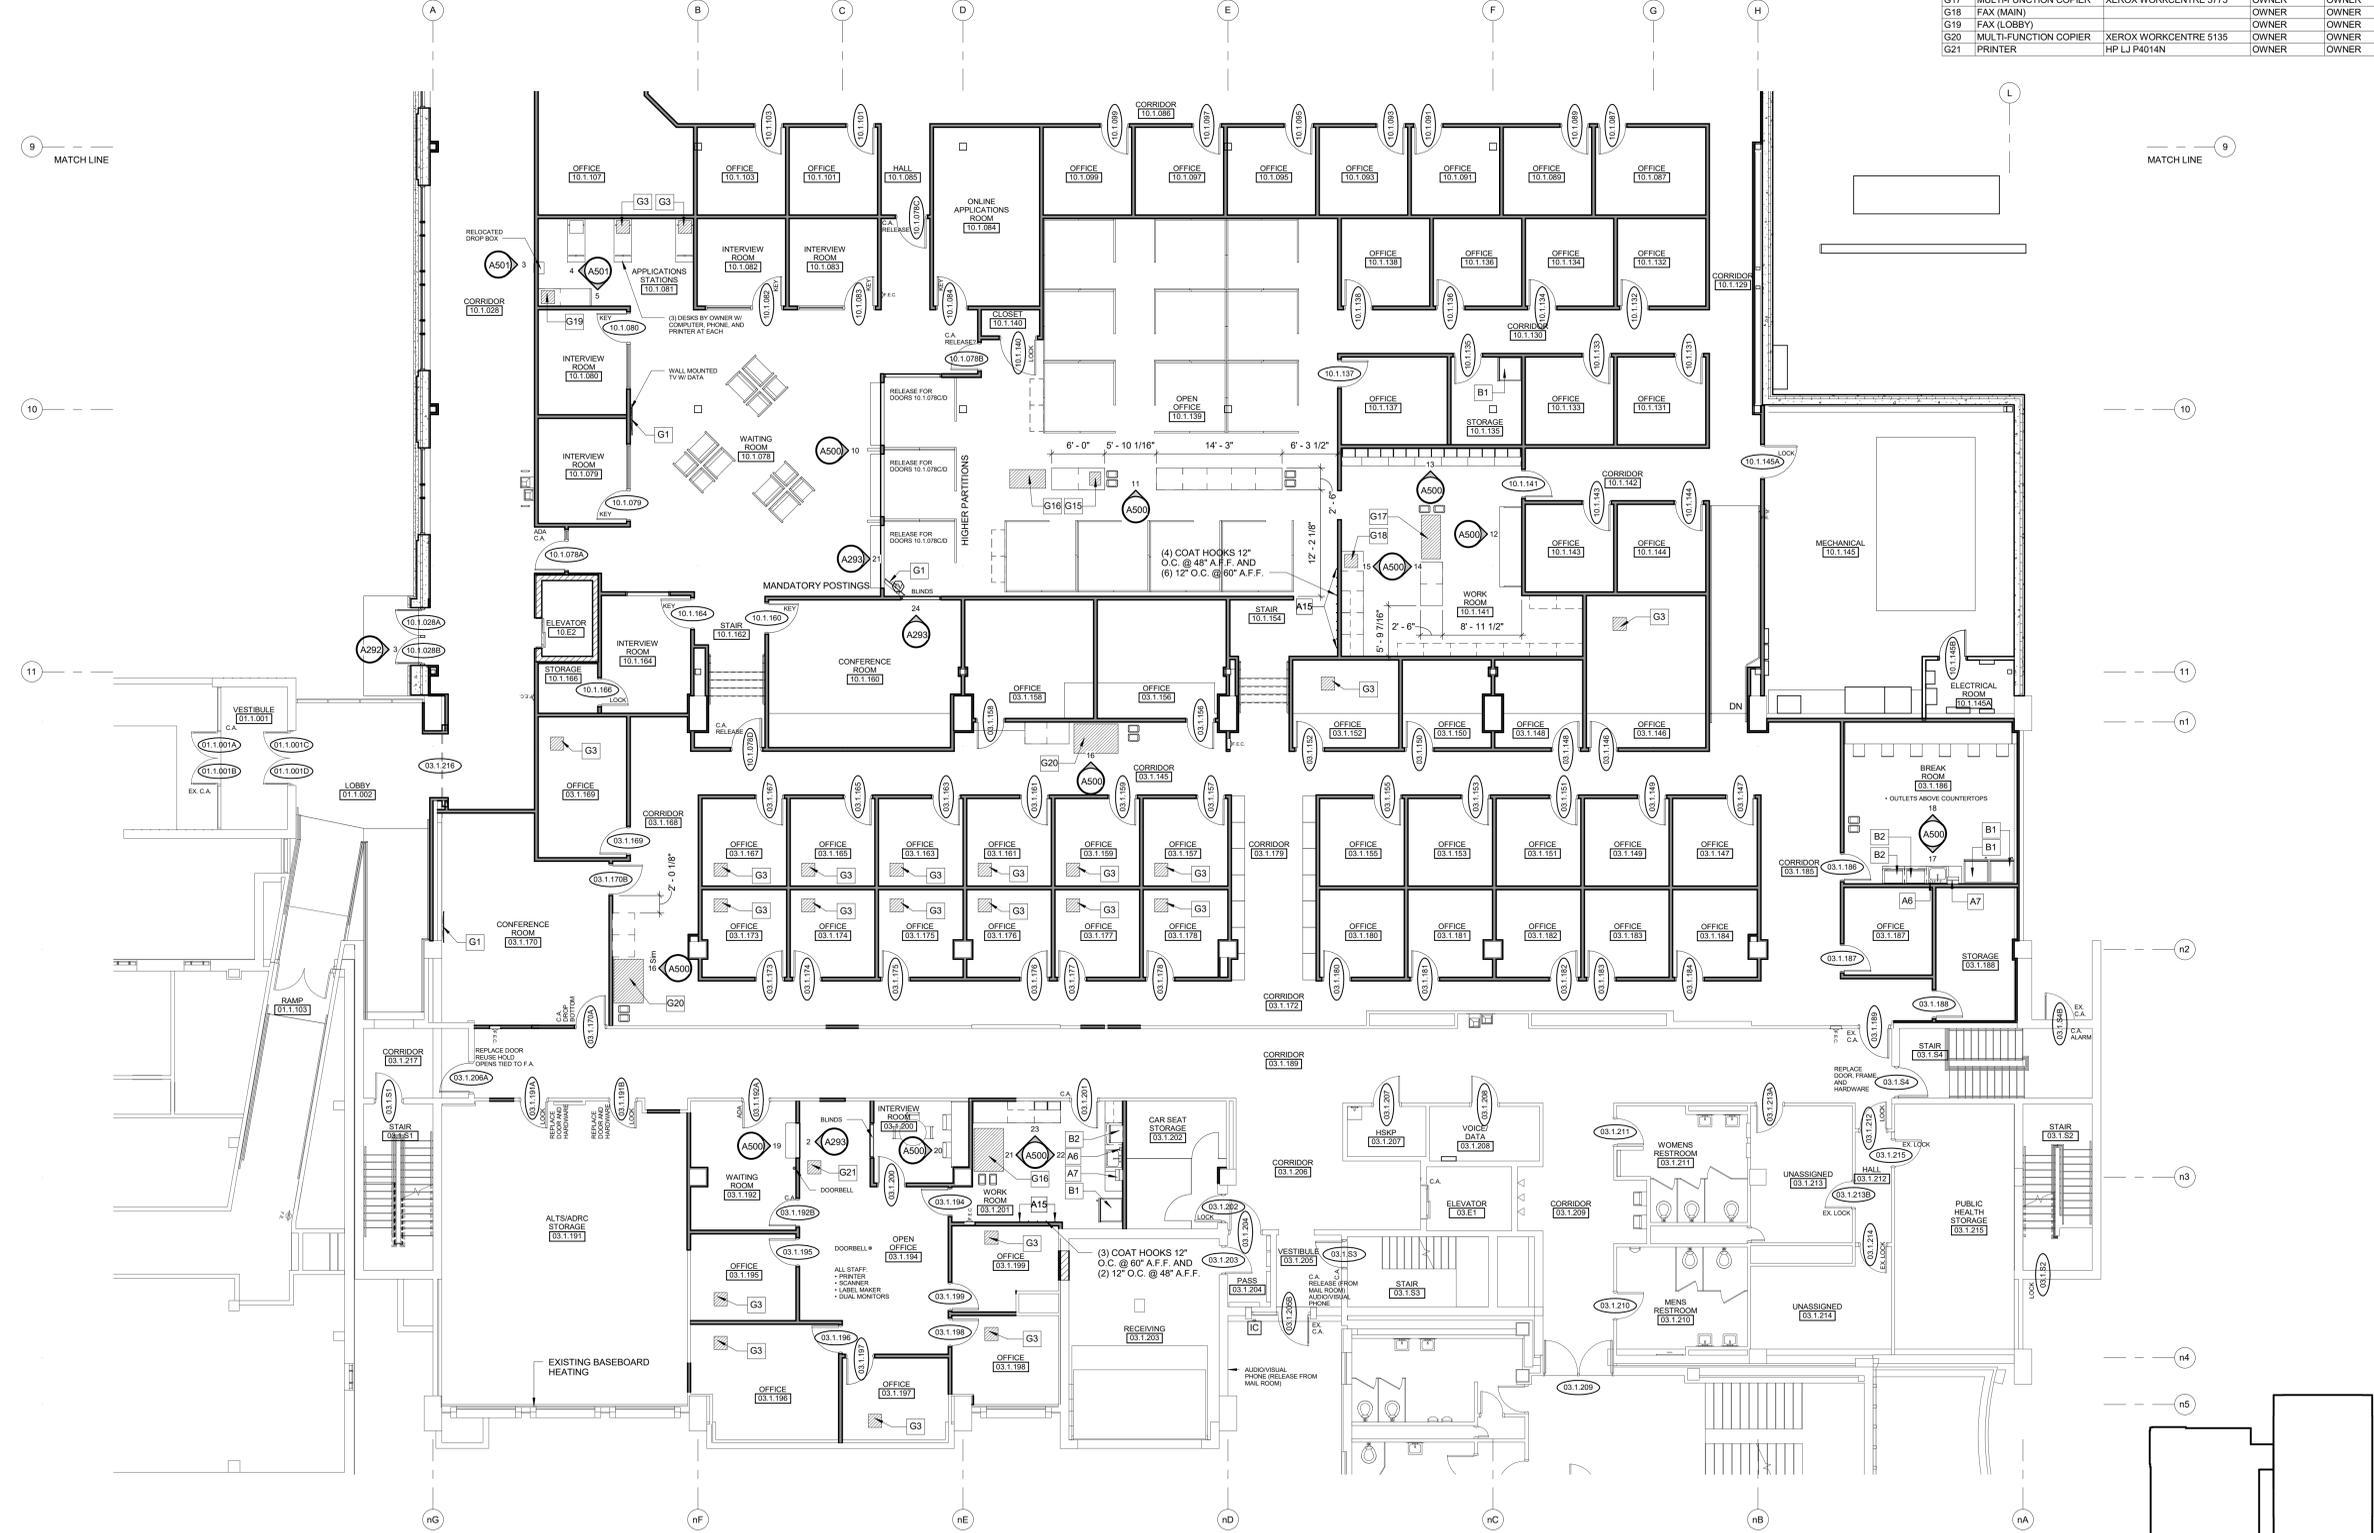

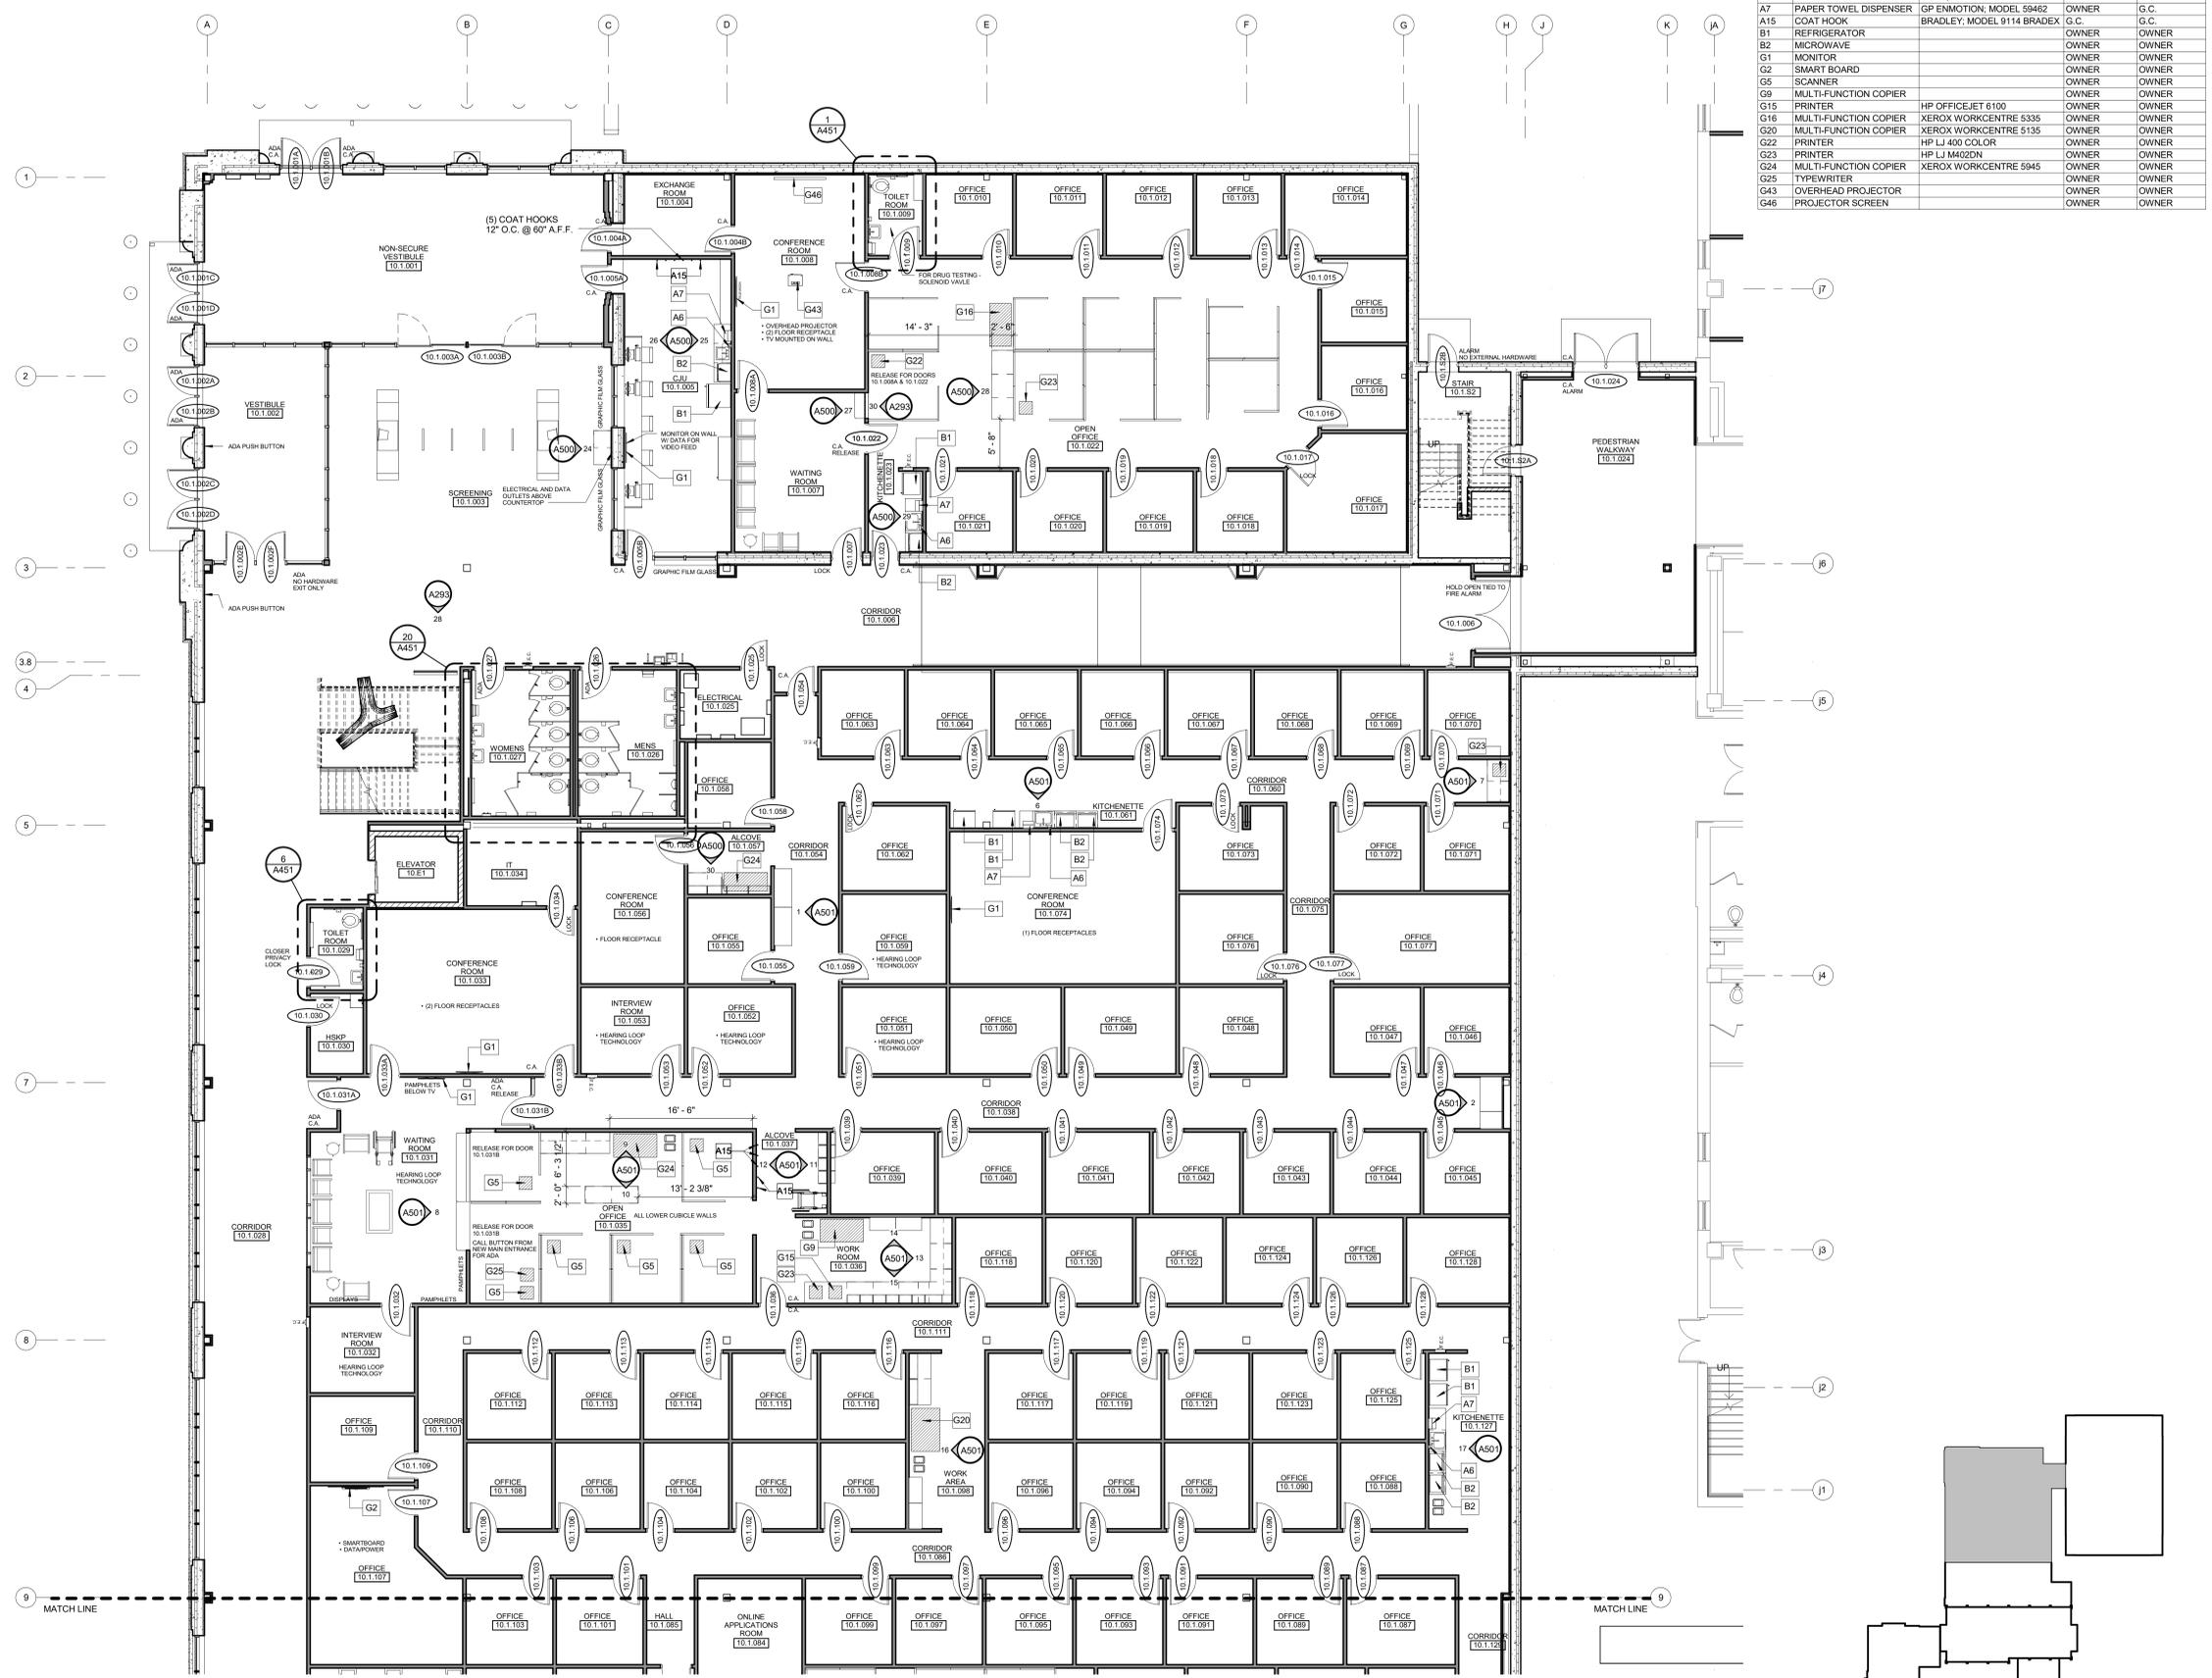

EQUIPMENT SCHEDULE - SHEET A274				
MARK	DESCRIPTION	MODEL	FURNISHED BY	INSTALLED BY
A6	SOAP DISPENSER	GOJO: MODEL ADX-7	OWNER	G.C.
A7	PAPER TOWEL DISPENSER	GP ENMOTION: MODEL 59462	OWNER	G.C.
B1	REFRIGERATOR	BRADLEY: MODEL 9114 BRADEX	G.C.	G.C.
B2	MICROWAVE		OWNER	OWNER
G1	MONITOR		OWNER	OWNER
G2	SMART BOARD		OWNER	OWNER
G5	SCANNER		OWNER	OWNER
G9	MULTI-FUNCTION COPIER		OWNER	OWNER
G15	PRINTER	HP OFFICEJET 6100	OWNER	OWNER
G16	MULTI-FUNCTION COPIER	XEROX WORKCENTRE 5335	OWNER	OWNER
G20	MULTI-FUNCTION COPIER	XEROX WORKCENTRE 5135	OWNER	OWNER
G22	PRINTER	HP LJ 400 COLOR	OWNER	OWNER
G23	PRINTER	HP LJ M402DN	OWNER	OWNER
G24	MULTI-FUNCTION COPIER	XEROX WORKCENTRE 5845	OWNER	OWNER
G25	TYPEWRITER		OWNER	OWNER
G43	OVERHEAD PROJECTOR		OWNER	OWNER
G46	PROJECTOR SCREEN		OWNER	OWNER

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NO.	DATE	REVISION

ALTERATION / ADDITION
 OUTAGAMIE COUNTY ADMINISTRATION CENTER
 S. WALNUT & W. 8TH, APPLETON WI 54911
 LEVEL 790.00 ENLARGED EQUIPMENT PLAN - OCAC NORTH


DESIGNED	DRAWN
MAG	BLG
PROJECT NO. 0002-61600160	
DATE MARCH 3, 2017	
SHEET NO. A274	

1 ENLARGED EQUIPMENT PLAN
 A274 1/8" = 1'-0"



PLAN KEY
 NOT TO SCALE



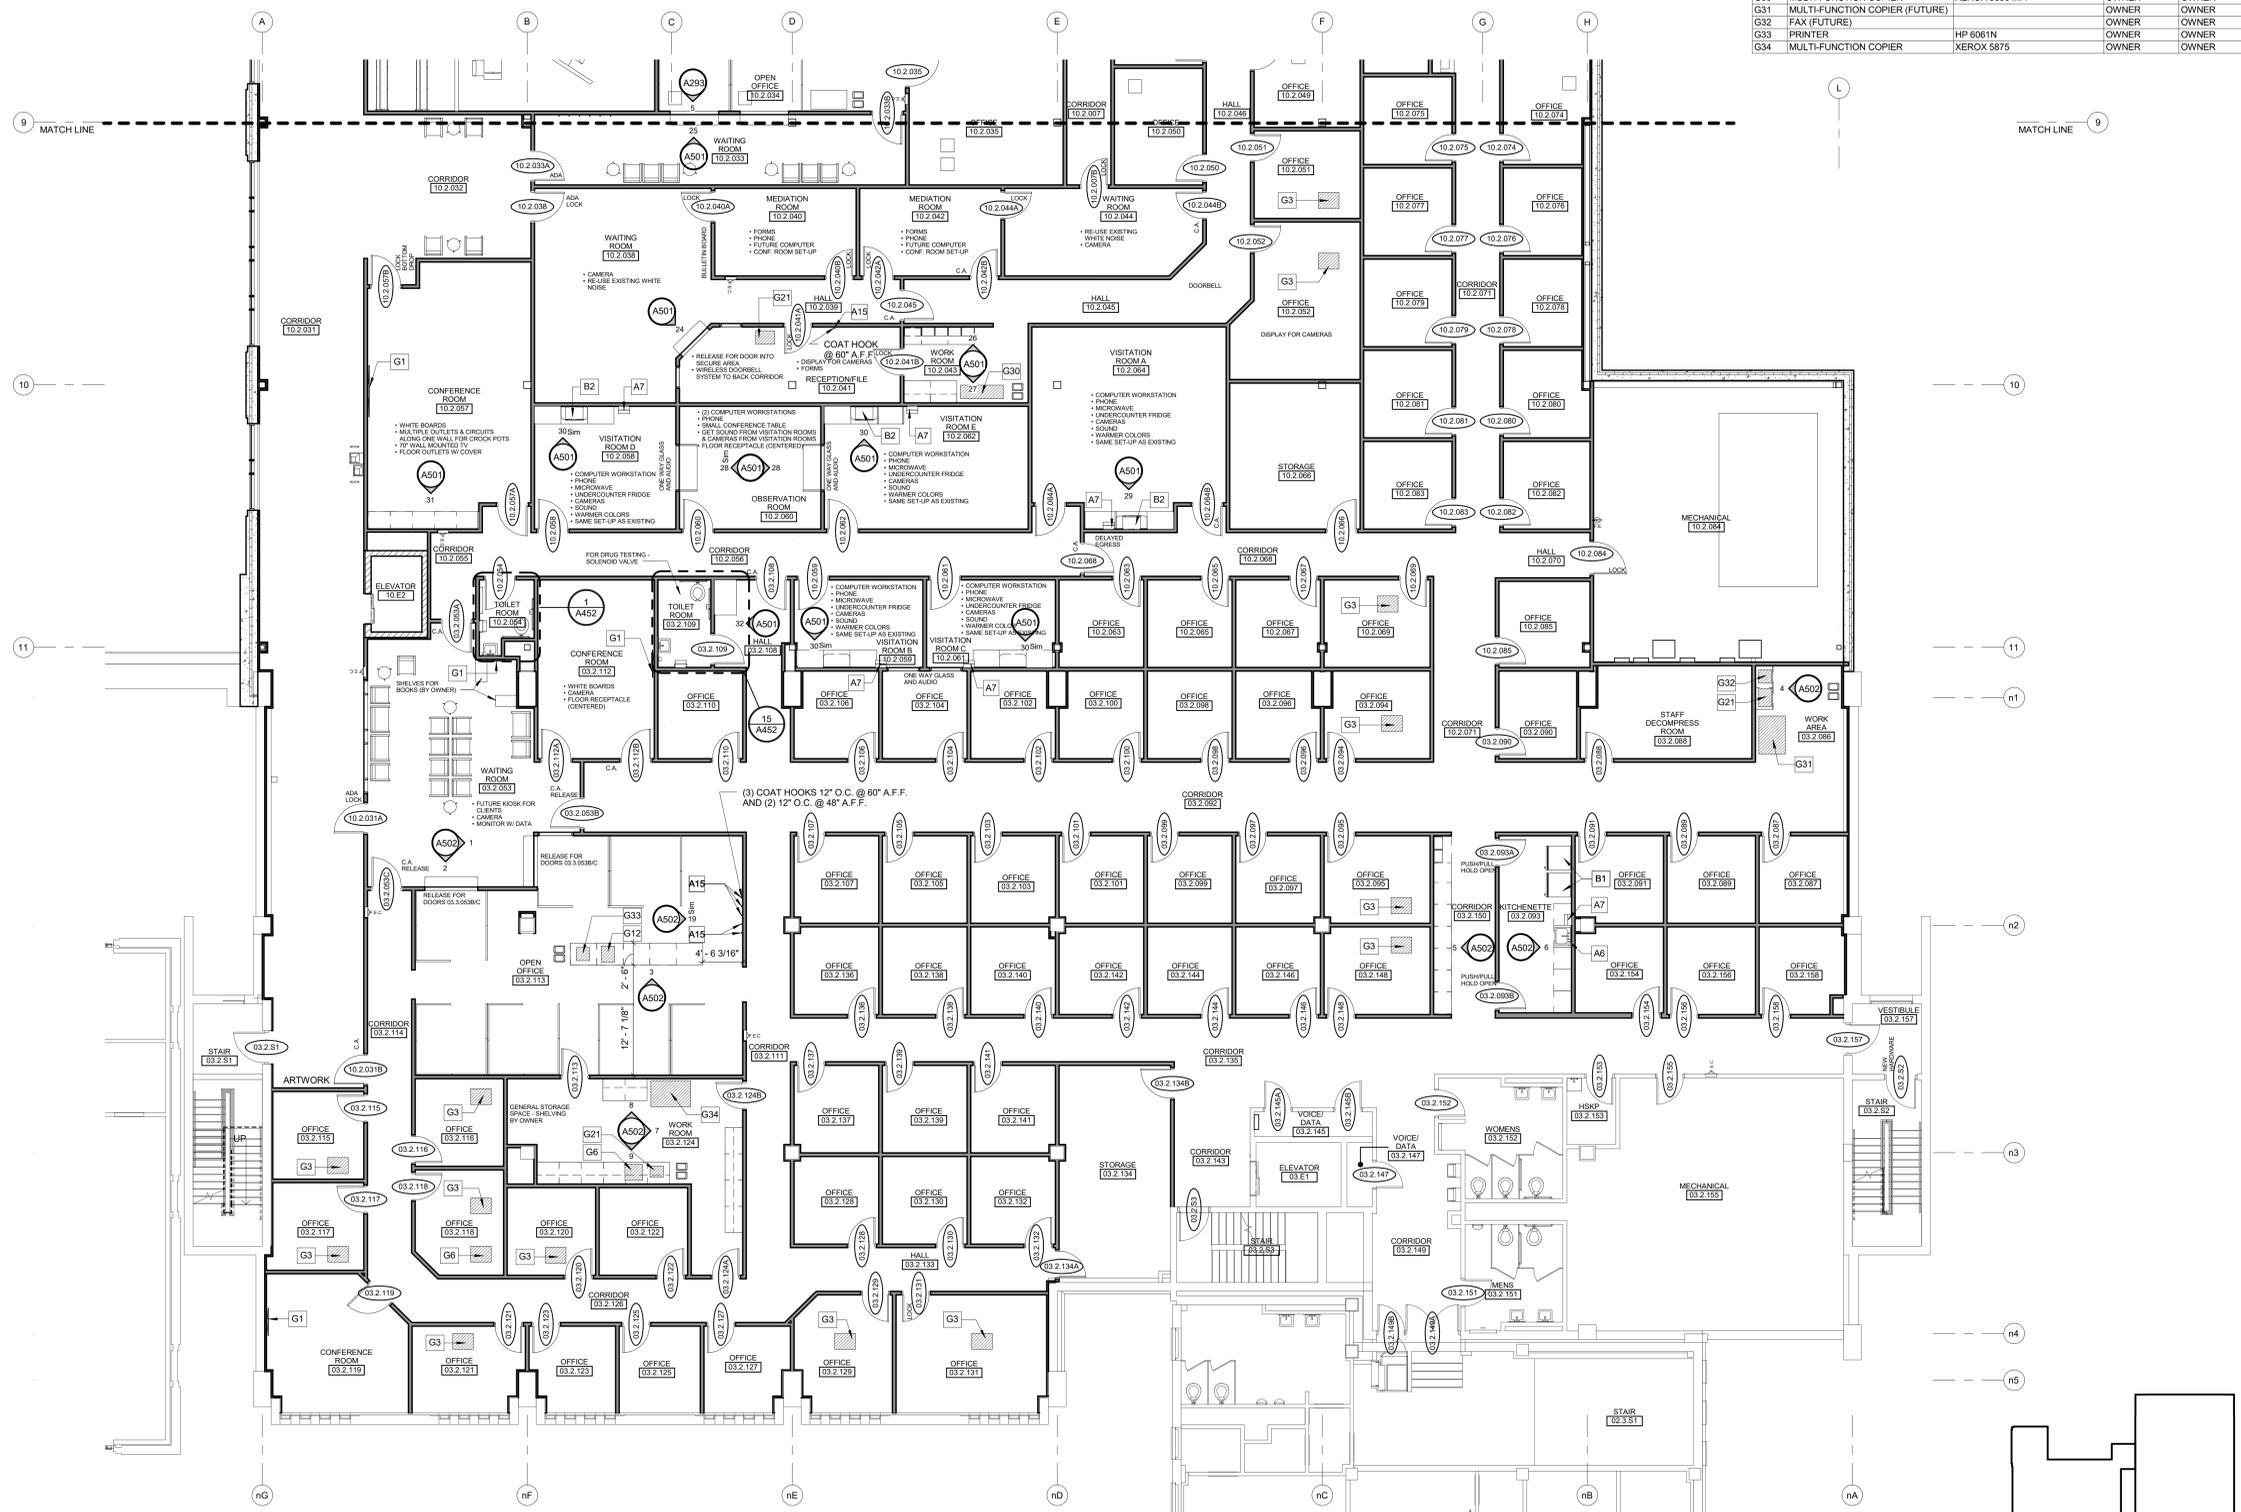

EQUIPMENT SCHEDULE - SHEET A276

MARK	DESCRIPTION	MODEL	FURNISHED BY	INSTALLED BY
A6	SOAP DISPENSER	GOJO; MODEL ADX-7	OWNER	G.C.
A7	PAPER TOWEL DISPENSER	GP ENMOTION; MODEL 59462	OWNER	G.C.
A15	COAT HOOK	BRADLEY; MODEL 9114 BRADEX	G.C.	G.C.
B1	REFRIGERATOR		OWNER	OWNER
B2	MICROWAVE		OWNER	OWNER
G1	MONITOR (WALL MOUNTED)		OWNER	OWNER
G3	PRINTER (LOCAL)		OWNER	OWNER
G6	FAX		OWNER	OWNER
G12	PRINTER	HP OFFICEJET 8100	OWNER	OWNER
G21	PRINTER	HP LJ P4014N	OWNER	OWNER
G30	MULTI-FUNCTION COPIER	XEROX 3635 MFP	OWNER	OWNER
G31	MULTI-FUNCTION COPIER (FUTURE)		OWNER	OWNER
G32	FAX (FUTURE)		OWNER	OWNER
G33	PRINTER	HP 6061N	OWNER	OWNER
G34	MULTI-FUNCTION COPIER	XEROX 5875	OWNER	OWNER

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NO.	DATE	REVISION

ALTERATION / ADDITION
OUTAGAME COUNTY ADMINISTRATION CENTER
S. WALNUT & W. 8TH, APPLETON WI 54911
LEVEL 805.00 ENLARGED EQUIPMENT PLAN - HHS NORTH/OCAC SOUTH


DESIGNED	DRAWN
MAG	BLG
PROJECT NO. 0002-61600160	
DATE MARCH 3, 2017	
SHEET NO. A276	

1
A276
ENLARGED EQUIPMENT PLAN
 1/8" = 1'-0"



PLAN KEY
 NOT TO SCALE



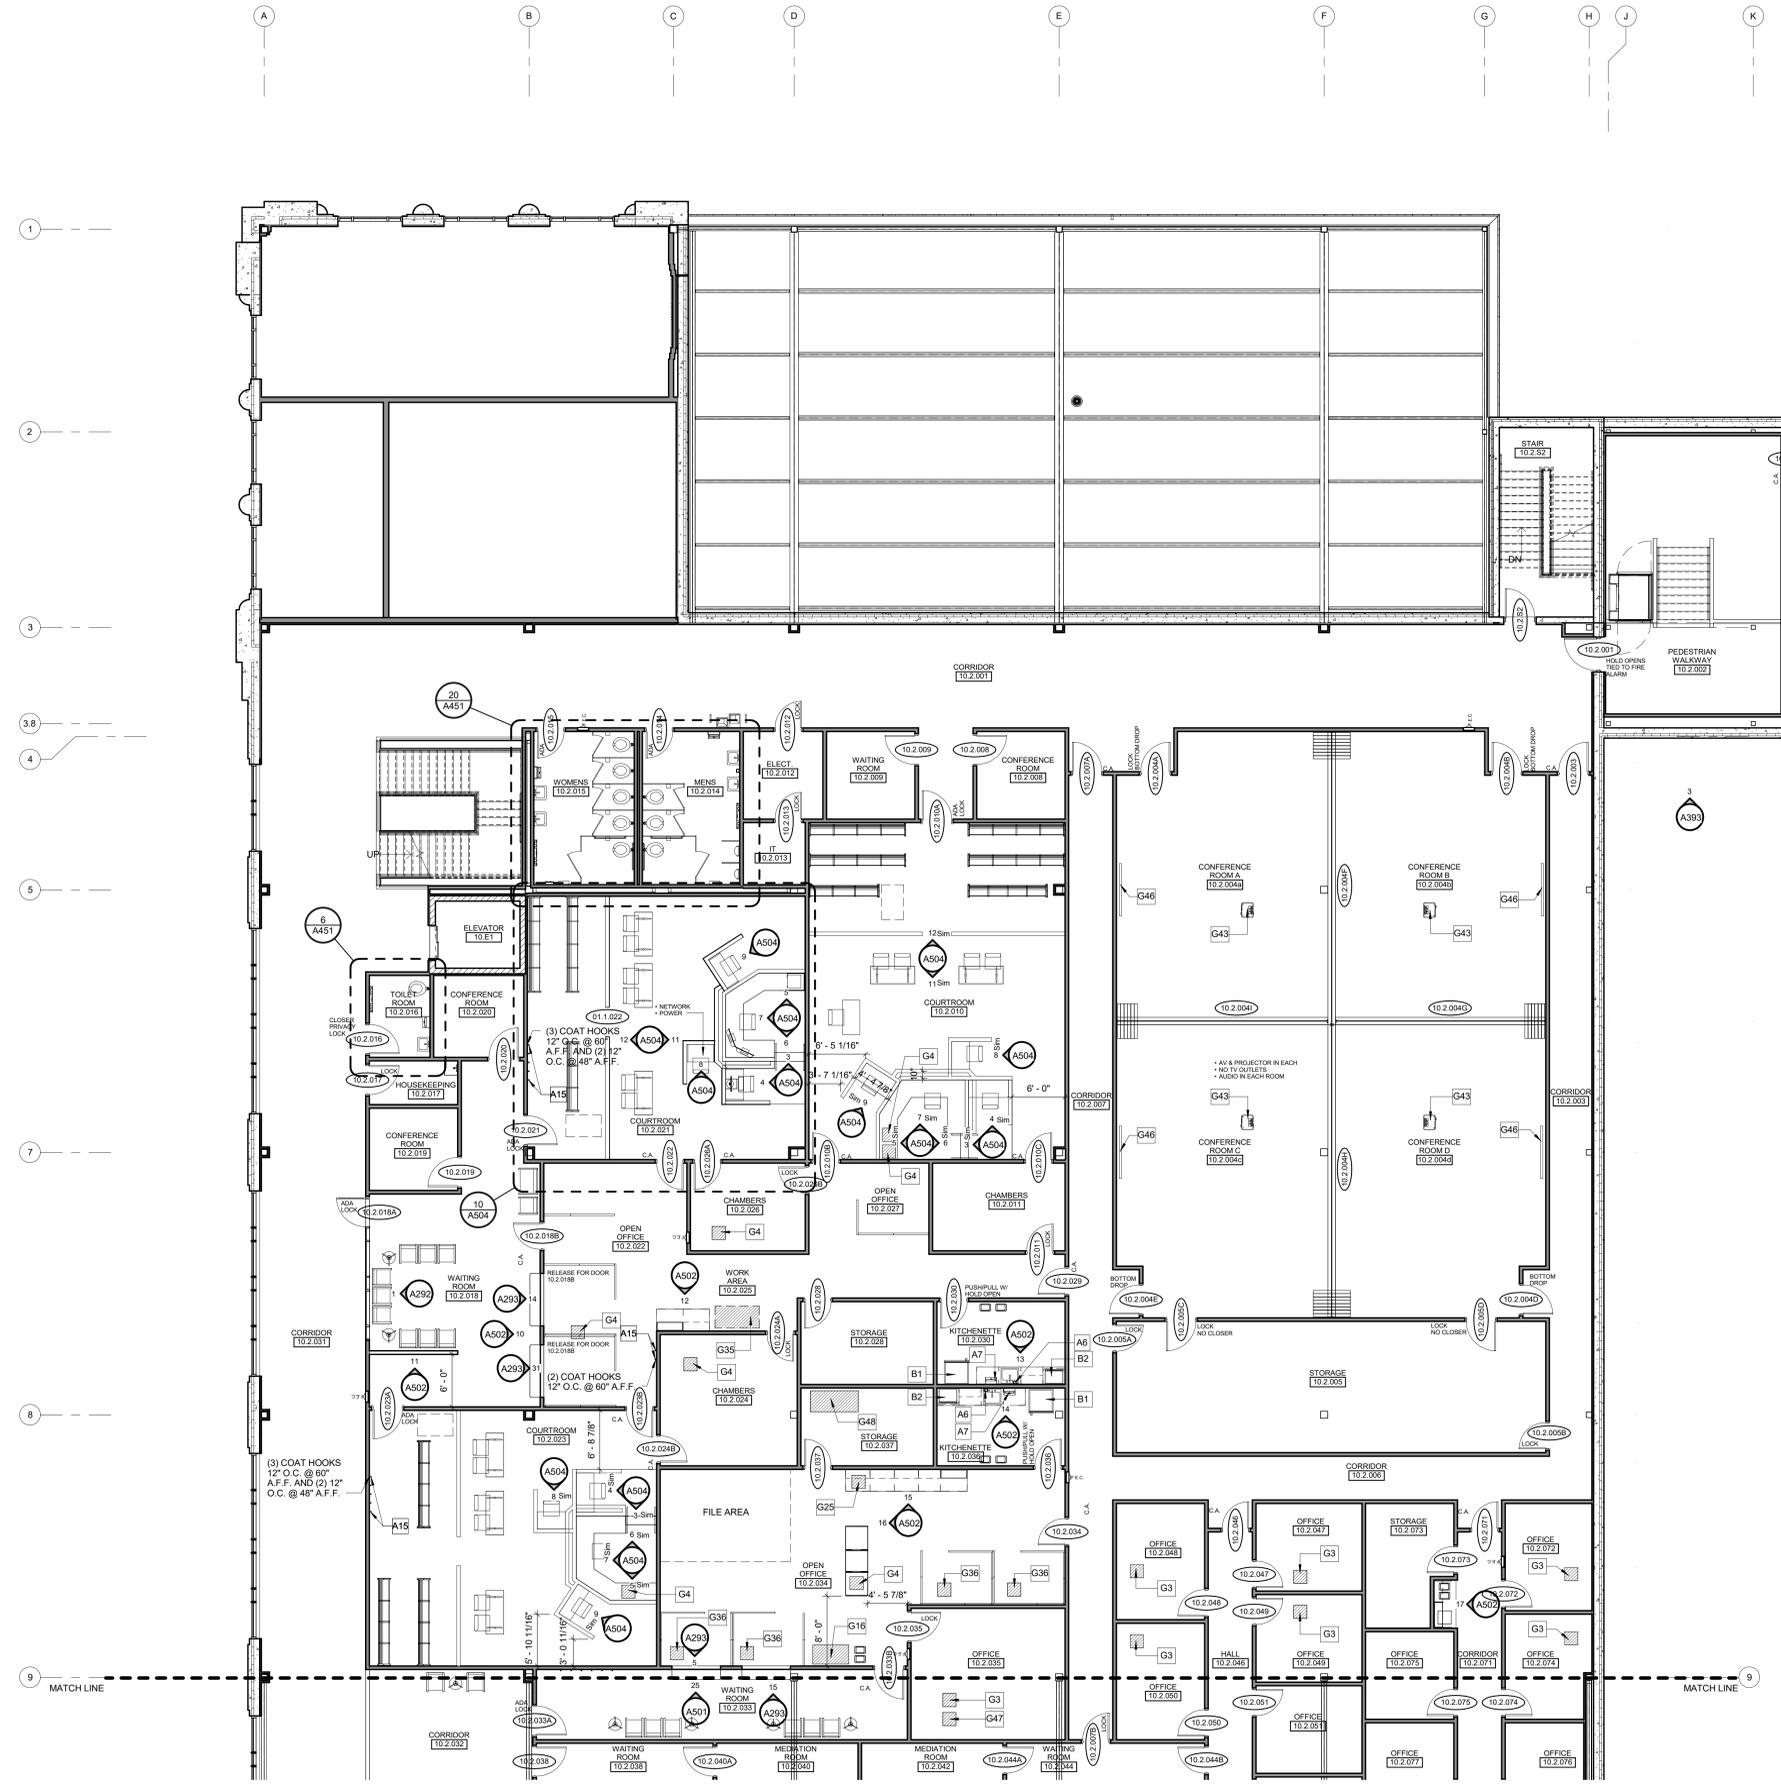

MARK	DESCRIPTION	MODEL	FURNISHED BY	INSTALLED BY
A6	SOAP DISPENSER	GOJO MODEL ADX-7	OWNER	G.C.
A7	PAPER TOWEL DISPENSER	GP ENMOTION, MODEL 99462	OWNER	G.C.
A15	COAT HOOK	BRADLEY, MODEL 9114 BRADEX	G.C.	G.C.
B1	REFRIGERATOR		OWNER	OWNER
B2	MICROWAVE		OWNER	OWNER
G1	MONITOR		OWNER	OWNER
G3	PRINTER (LOCAL)		OWNER	OWNER
G4	PRINTER (STATE)		OWNER	OWNER
G16	MULTI-FUNCTION COPIER	XEROX WORKCENTRE 5335	OWNER	OWNER
G25	TYPEWRITER		OWNER	OWNER
G35	MULTI-FUNCTION COPIER (FUTURE)		OWNER	OWNER
G36	SCANNER (STATE) (FUTURE)		OWNER	OWNER
G43	OVERHEAD PROJECTOR		OWNER	OWNER
G46	PROJECTOR SCREEN		OWNER	OWNER
G47	RECEIPT PRINTER		OWNER	OWNER
G48	EXISTING SAFE		OWNER	OWNER

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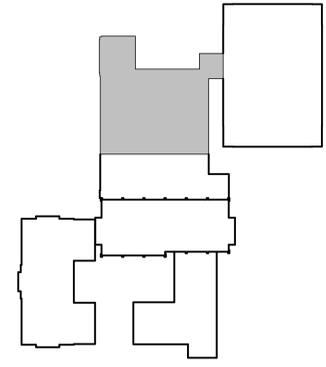
NO.	DATE	REVISION


DESIGNED: MAG
 DRAWN: BLG
 PROJECT NO: 0002-61600160
 DATE: MARCH 3, 2017
 SHEET NO: A277

ALTERATION / ADDITION
 OUTAGAME COUNTY ADMINISTRATION CENTER
 S. WALNUT & W. 8TH, APPLETON WI 54911
 LEVEL 805.00 ENLARGED EQUIPMENT PLAN - OCAC NORTH

1 ENLARGED EQUIPMENT PLAN
 A277 1/8" = 1'-0"

PLAN KEY
 NOT TO SCALE



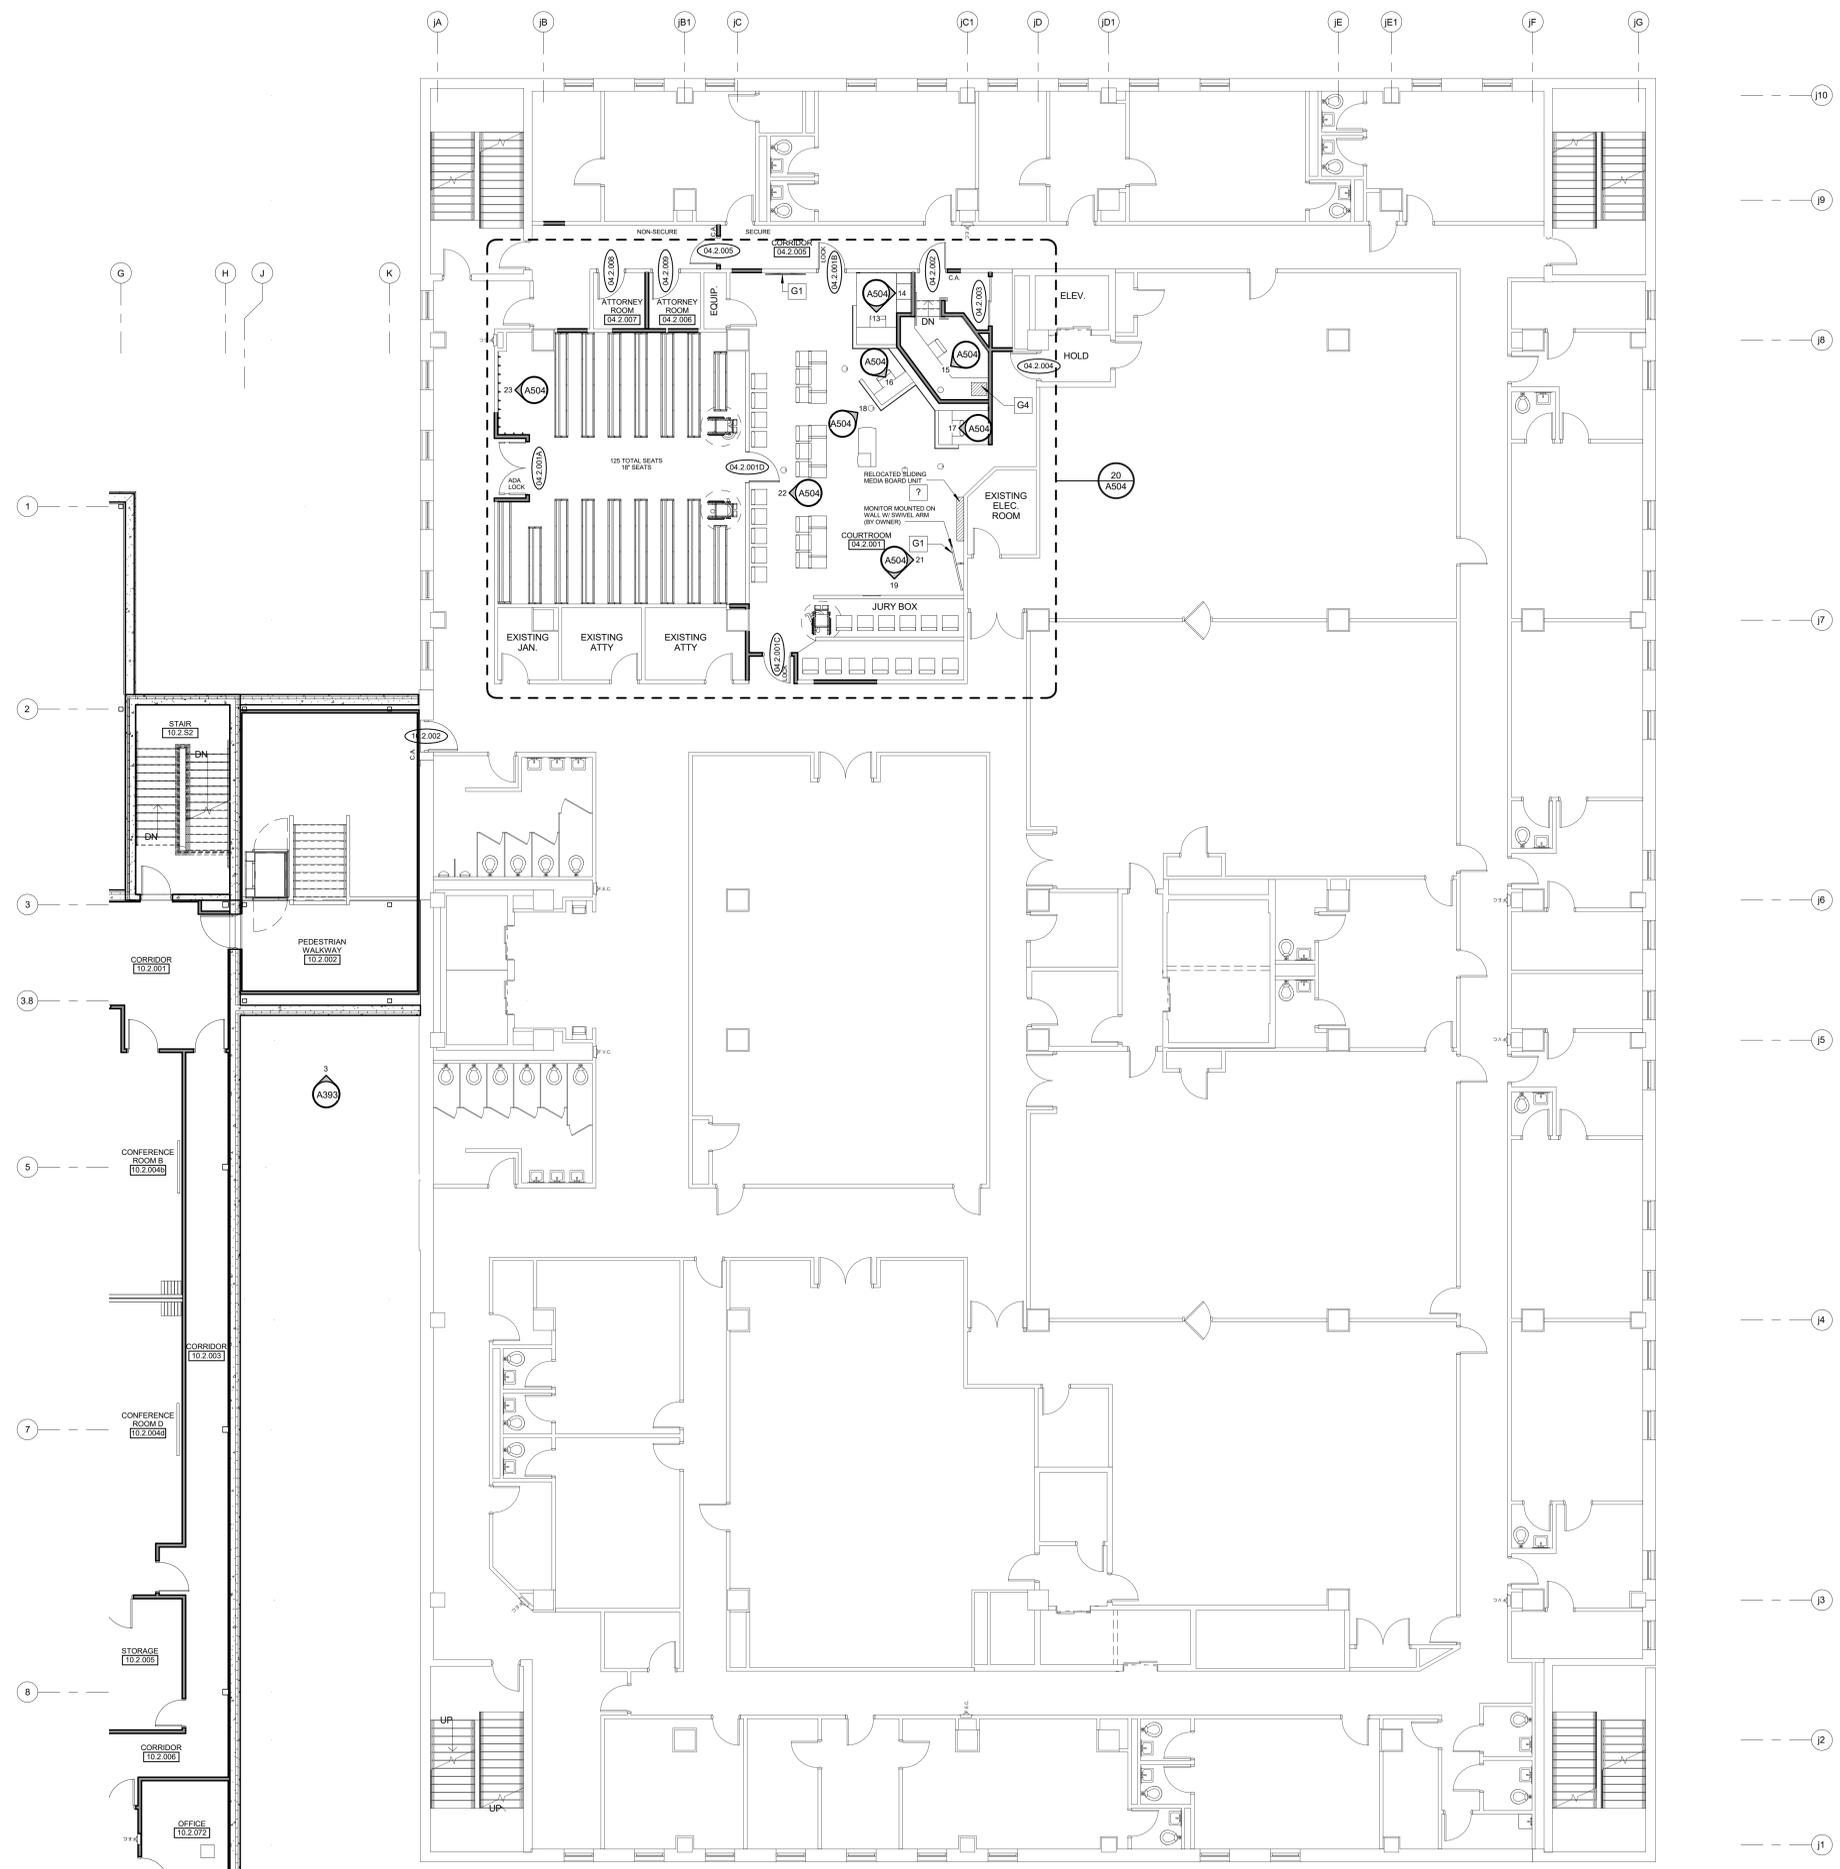

EQUIPMENT SCHEDULE - SHEET A278

MARK	DESCRIPTION	MODEL	FURNISHED BY	INSTALLED BY
A15	COAT HOOK	BRADLEY, MODEL 9114 BRADEX	G.C.	G.C.
G1	MONITOR		OWNER	OWNER
G4	PRINTER (STATE)		OWNER	OWNER
G51	SLIDING MEDIA BOARD UNIT		OWNER	G.C.

McMAHON
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 TEL: (414) 754-4200 FAX: (414) 754-4284
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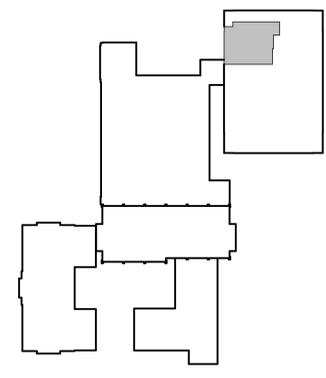
McMahon provides this drawing as a service to the client. It is not to be used for any other purpose without the written consent of McMahon. The client is responsible for verifying the accuracy of the information provided by the client and for obtaining all necessary permits and approvals from the appropriate authorities. The client acknowledges that McMahon is not responsible for any errors or omissions in this drawing and that the client is responsible for the final design and construction of the project.

NO.	DATE	REVISION


ALTERATION / ADDITION
OUTAGAMIE COUNTY ADMINISTRATION CENTER
 S. WALNUT & W. 8TH, APPLETON WI 54911
 LEVEL 805.00 ENLARGED EQUIPMENT PLAN - JUSTICE CENTER

DESIGNED	DRAWN
MAG	BLG
PROJECT NO. 0002-61600160	
DATE MARCH 3, 2017	
SHEET NO. A278	

1 ENLARGED EQUIPMENT PLAN
 A278 1/8" = 1'-0"



PLAN KEY
 NOT TO SCALE

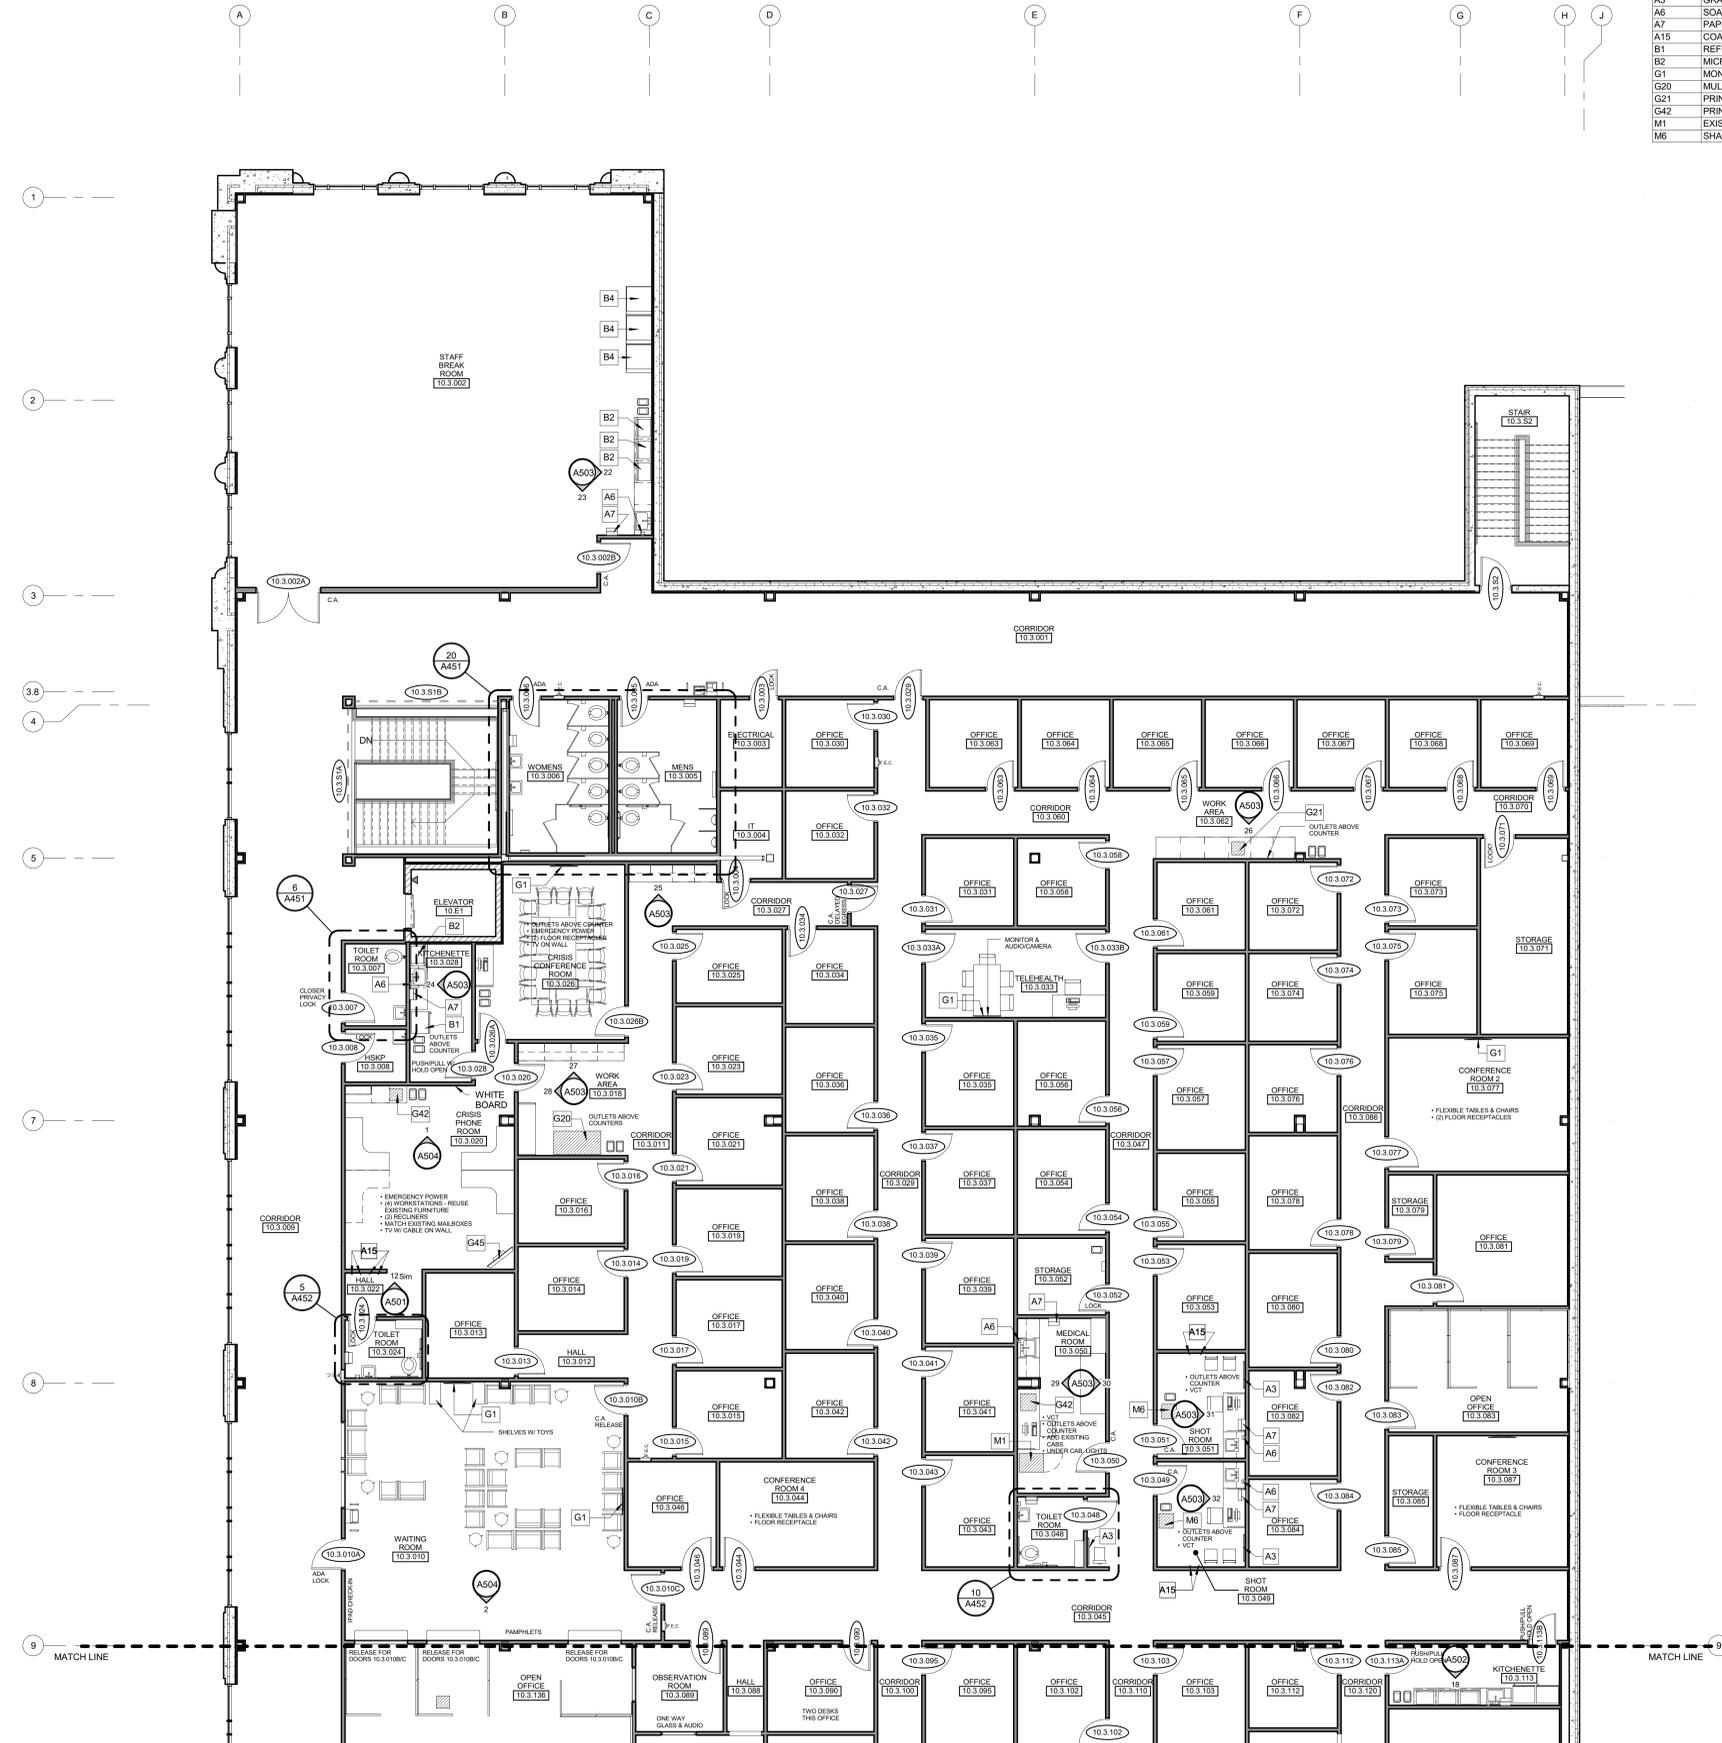

EQUIPMENT SCHEDULE - SHEET A280				
MARK	DESCRIPTION	MODEL	FURNISHED BY	INSTALLED BY
A3	GRAB BAR (36")	BRADLEY, MODEL 832	G.C.	G.C.
A6	SOAP DISPENSER	GOJO, MODEL ADX-7	OWNER	G.C.
A7	PAPER TOWEL DISPENSER	GP ENMOTION, MODEL 59462	OWNER	G.C.
A15	COAT HOOK	BRADLEY, MODEL 9114 BRADEX	G.C.	G.C.
B1	REFRIGERATOR		OWNER	OWNER
B2	MICROWAVE		OWNER	OWNER
G1	MONITOR		OWNER	OWNER
G20	MULTI-FUNCTION COPIER	XEROX WORKCENTER 5135	OWNER	OWNER
G21	PRINTER	HP LJ P4014N	OWNER	OWNER
G42	PRINTER	HP LJ P3015	OWNER	OWNER
M1	EXISTING MEDICAL REFRIGERATOR	ABS TEMP - TECH 200	OWNER	OWNER
M6	SHARPS CONTAINER (EXISTING)		OWNER	OWNER

McMAHON
ENGINEERS ARCHITECTS
 1000 N. WISCONSIN ST., SUITE 1000, NEENAH, WI 54956-7025
 Tel: (920) 751-4200 Fax: (920) 751-4284
 www.mcma.com

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NO.	DATE	REVISION

ALTERATION / ADDITION
 OUTAGAME COUNTY ADMINISTRATION CENTER
 S. WALNUT & W. 8TH, APPLETON WI 54911
 LEVEL 820.00 ENLARGED EQUIPMENT PLAN - OCAC NORTH

DESIGNED MAG	DRAWN BLG
PROJECT NO. 0002-61600160	
DATE MARCH 3, 2017	
SHEET NO. A280	

1 ENLARGED EQUIPMENT PLAN
 A280 1/8" = 1'-0"

PLAN KEY
 NOT TO SCALE



DOOR SCHEDULE table with columns: DOOR NUMBER, OPENING SIZE (WIDTH, DOOR HEIGHT, THICKNESS), DOOR TYPE, FRAME TYPE, FIRE RATING, DETAILS (A291), COMMENTS, and FIRE RATING.

DOOR SCHEDULE table with columns: DOOR NUMBER, OPENING SIZE (WIDTH, DOOR HEIGHT, THICKNESS), DOOR TYPE, FRAME TYPE, FIRE RATING, DETAILS (A291), COMMENTS, and FIRE RATING.

DOOR SCHEDULE table with columns: DOOR NUMBER, OPENING SIZE (WIDTH, DOOR HEIGHT, THICKNESS), DOOR TYPE, FRAME TYPE, FIRE RATING, DETAILS (A291), COMMENTS, and FIRE RATING.

GENERAL DOOR NOTE & WINDOW NOTES

- SEE SPECIFICATIONS FOR DOOR HARDWARE DESCRIPTIONS.
SEE STRUCTURAL FOR LINTEL SCHEDULE
ALL BORROWED LITE AND DOOR LITE GLAZING TO BE 1/4" TEMPERED SAFETY GLASS UNLESS OTHERWISE NOTED


McMAHON ENGINEERS ARCHITECTS logo and contact information.

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REVISION table with columns: NO., DATE, and DESCRIPTION.


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DOOR ELEVATIONS




ALTERATION / ADDITION OUTGAMME COUNTY ADMINISTRATION CENTER S. WALNUT & W. 8TH, APPLETON WI 54911 DOOR SCHEDULE table with columns: DESIGNED, DRAWN, PROJECT NO., DATE, and SHEET NO.

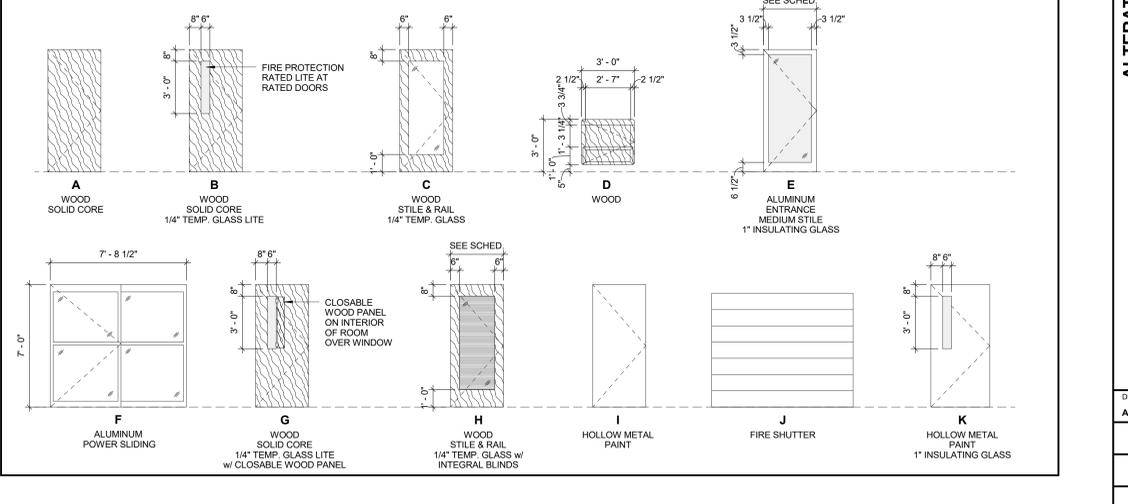
DOOR FRAME AND EXTERIOR WINDOW FRAME ELEVATIONS

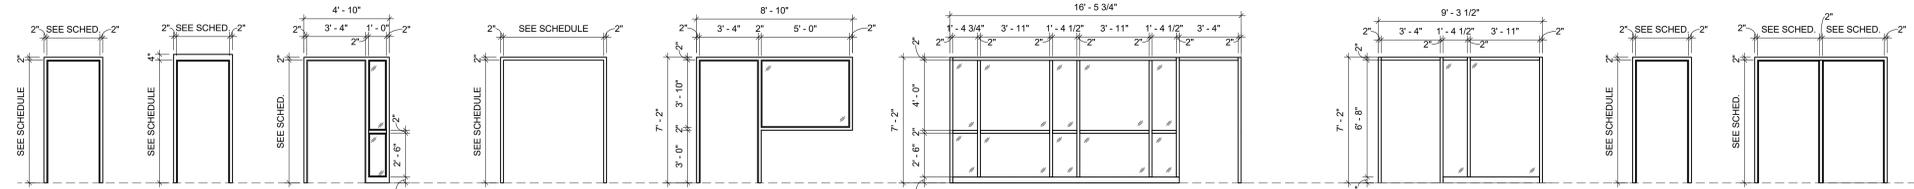


HM1 HOLLOW METAL PAINT
 HM2 HOLLOW METAL PAINT
 HM3 HOLLOW METAL w/ 1/4" TEMP. GLASS SIDELITE PAINT
 HM4 HOLLOW METAL SLIDING DOOR PAINT
 HM5 HOLLOW METAL w/ 1/4" TEMP. GLASS SIDELITE PAINT
 HM6 HOLLOW METAL w/ 1/4" TEMP. GLASS SIDELITE PAINT
 HM7 HOLLOW METAL w/ 1/4" TEMP. GLASS SIDELITE PAINT
 HM8 HOLLOW METAL DOUBLE SWING PAINT
 HM9 HOLLOW METAL PAINT

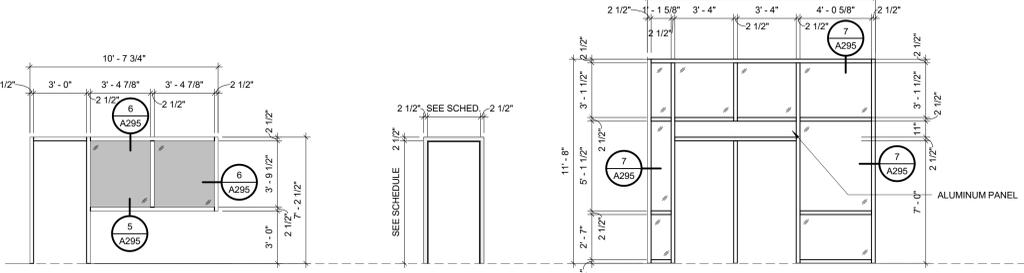


AL1 ALUMINUM DARK BRONZE w/ 1/4" TEMP. GLASS GRAPHIC FILM APPLIED
 AL2 ALUMINUM DARK BRONZE w/ 1/4" TEMP. GLASS
 AL3 ALUMINUM DARK BRONZE w/ 1/4" TEMP. GLASS

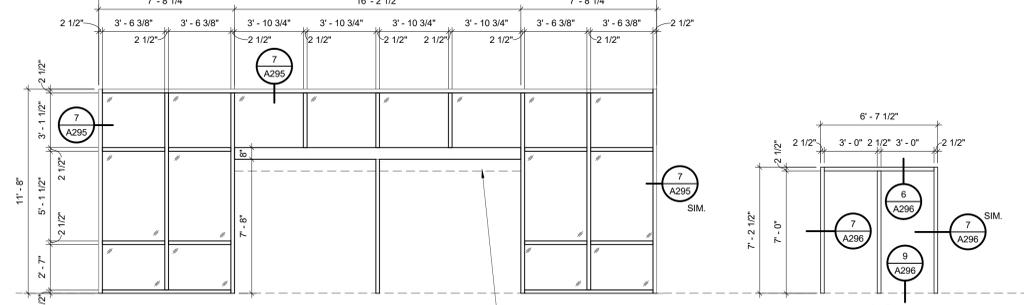


AL4 ALUMINUM DARK BRONZE w/ 1/4" TEMP. GLASS
 AL6 ALUMINUM DARK BRONZE w/ 1/4" TEMP. GLASS

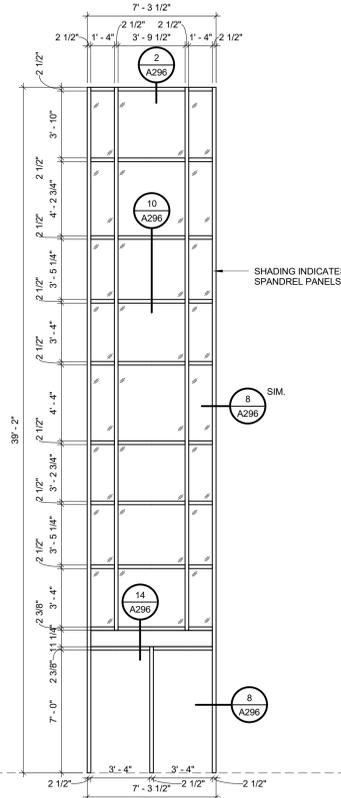


W1 ALUMINUM DARK BRONZE w/ 1" INSUL. GLASS

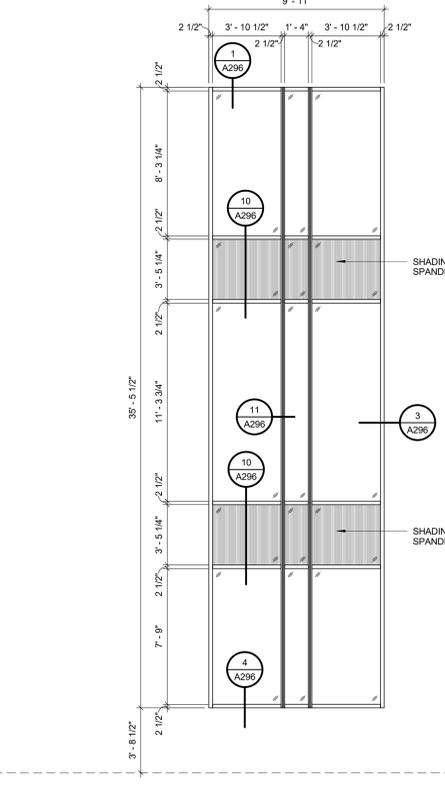

W2 ALUMINUM DARK BRONZE w/ 1" INSUL. GLASS

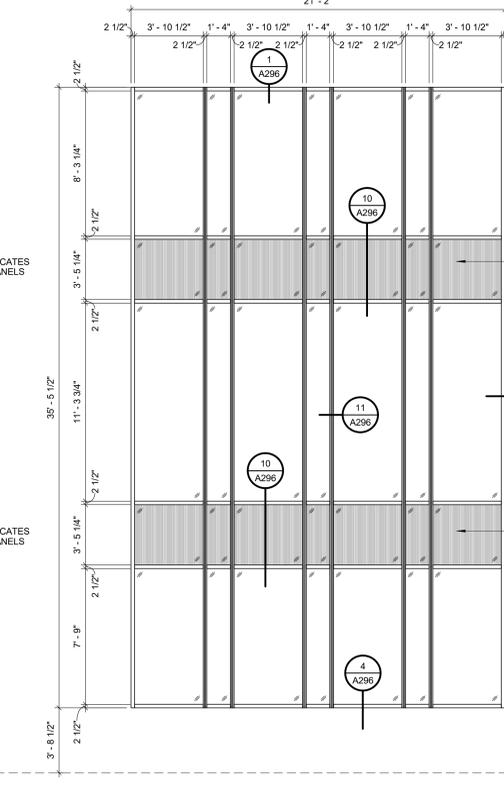

W3 ALUMINUM DARK BRONZE w/ 1" INSUL. GLASS

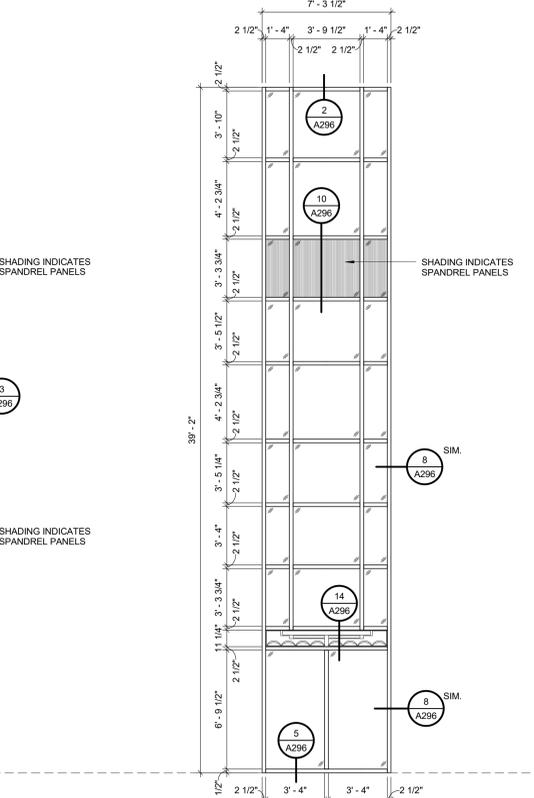

W4 ALUMINUM DARK BRONZE w/ 1" INSUL. GLASS


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NO.	DATE	REVISION

ALTERATION / ADDITION
 OUTAGAME COUNTY ADMINISTRATION CENTER
 S. WALNUT & W. 8TH, APPLETON WI 54911
 DOOR FRAME AND EXTERIOR WINDOW ELEVATIONS

DESIGNED	DRAWN
ASF/MAG	BLG
PROJECT NO. 0002-61600160	
DATE MARCH 3, 2017	
SHEET NO.	

BORROWED LITE FRAME ELEVATIONS

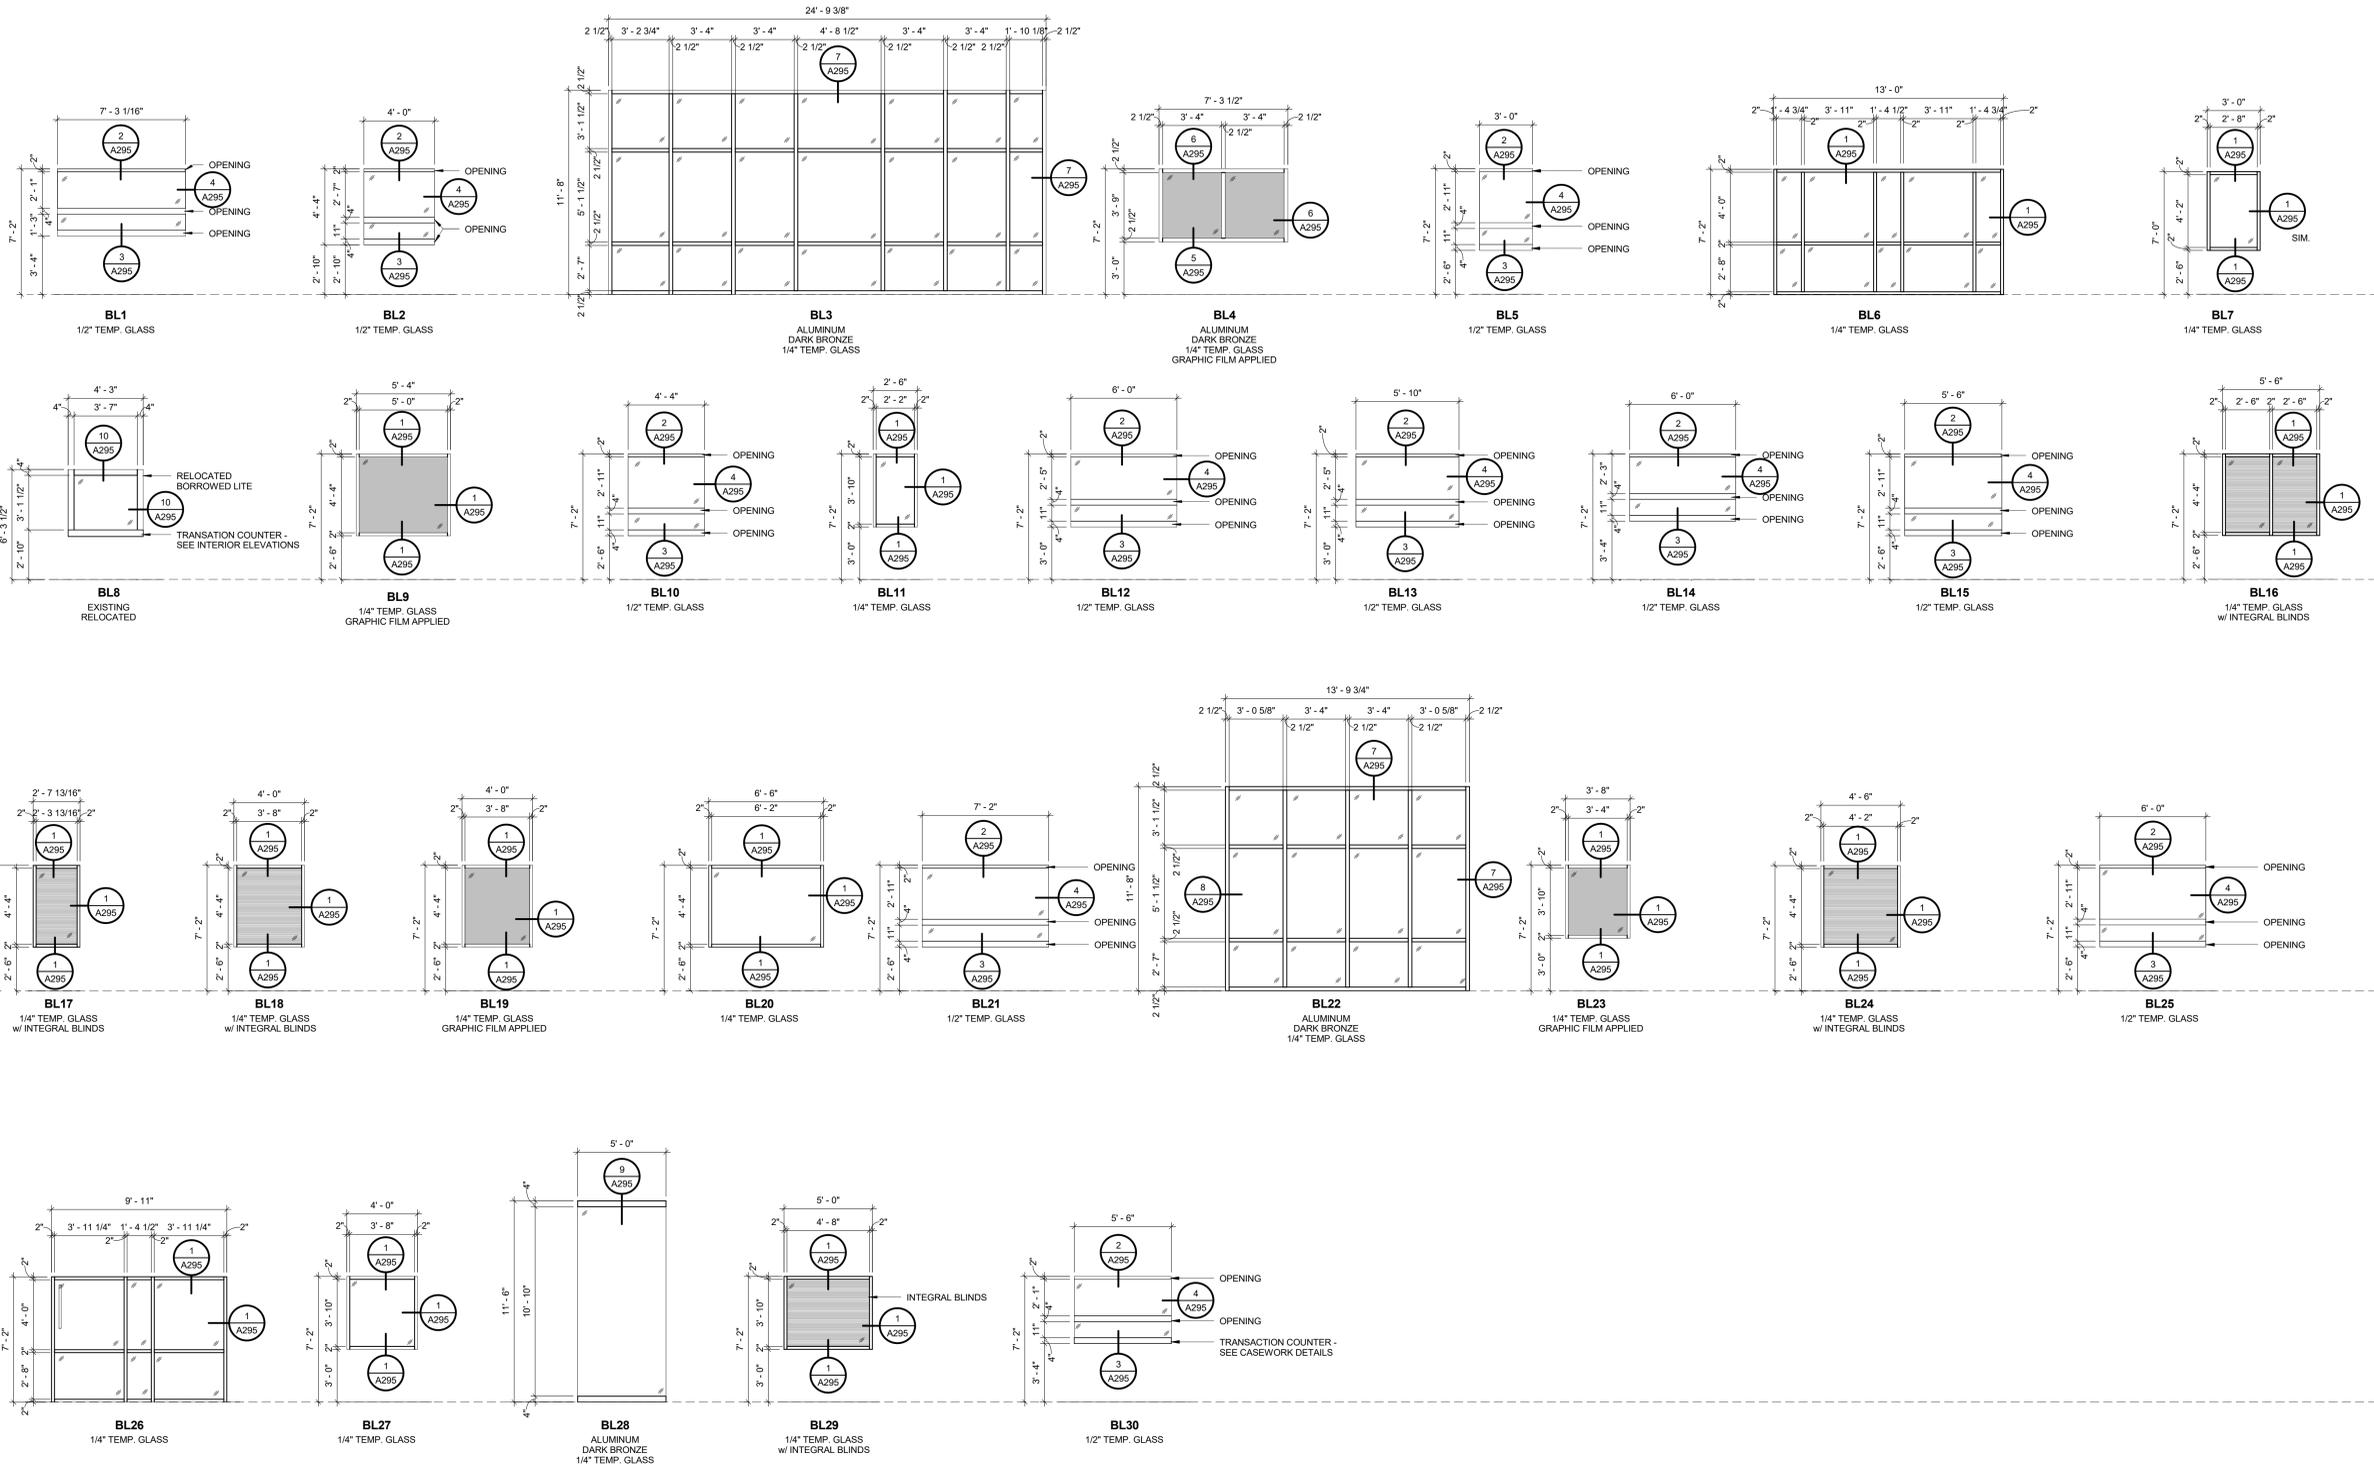

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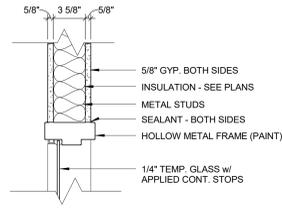
NO.	DATE	REVISION

NO.	DATE	REVISION


NO.	DATE	REVISION

ALTERATION / ADDITION
OUTAGAME COUNTY ADMINISTRATION CENTER
S. WALNUT & W. 8TH, APPLETON WI 54911
BORROWED LITE ELEVATIONS


DESIGNED	DRAWN
ASF/MAG	BLG
PROJECT NO.	
0002-61600160	
DATE	
MARCH 3, 2017	
SHEET NO.	




1 BORROWED LITE HEAD/JAMB
A295 1 1/2" = 1'-0"

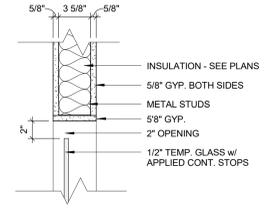


2 BORROWED LITE HEAD
A295 1 1/2" = 1'-0"

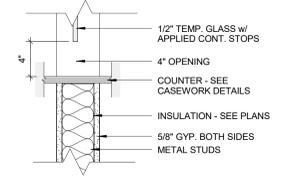


3 BORROWED LITE SILL
A295 1 1/2" = 1'-0"

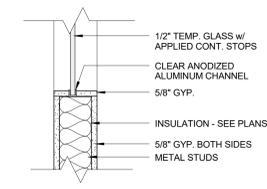


4 BORROWED LITE JAMB
A295 1 1/2" = 1'-0"

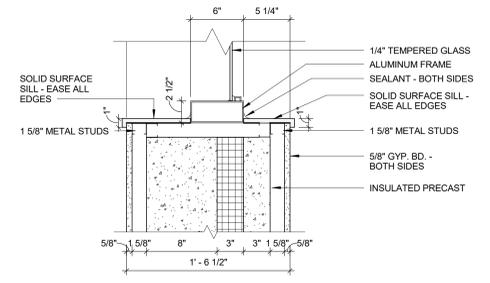


5 BORROWED LITE SILL
A295 1 1/2" = 1'-0"

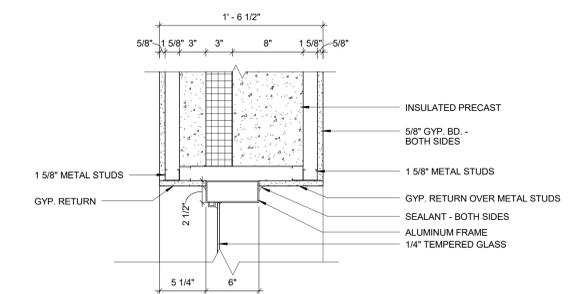


6 BORROWED LITE HEAD/JAMB
A295 1 1/2" = 1'-0"

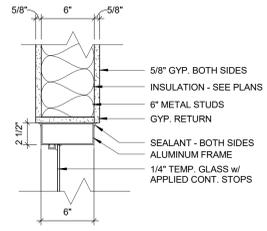


7 BORROWED LITE HEAD/JAMB
A295 1 1/2" = 1'-0"

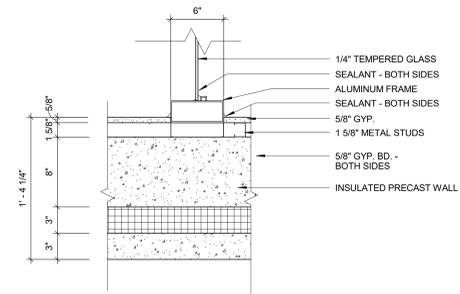

8 BORROWED LITE JAMB
A295 1 1/2" = 1'-0"

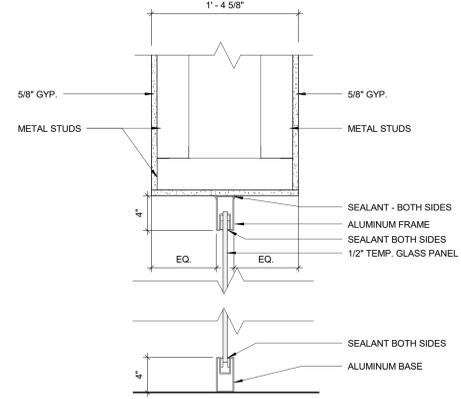

9 BORROWED LITE HEAD
A295 1 1/2" = 1'-0"

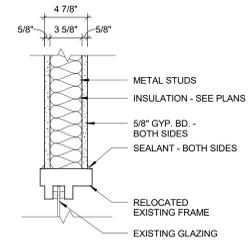


10 BORROWED LITE HEAD/JAMB
A295 1 1/2" = 1'-0"

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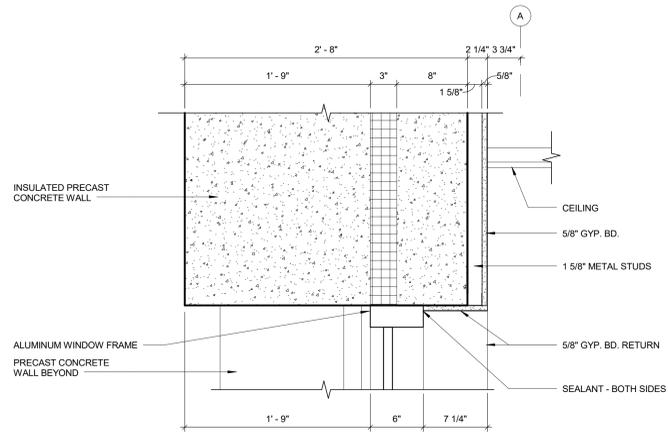
NO.	DATE	REVISION

ALTERATION / ADDITION
OUTAGAME COUNTY ADMINISTRATION CENTER
S. WALNUT & W. 8TH, APPLETON WI 54911
BORROWED LITE DETAILS


DESIGNED	DRAWN
ASF/MAG	BLG
PROJECT NO.	
0002-61600160	
DATE	
MARCH 3, 2017	
SHEET NO.	

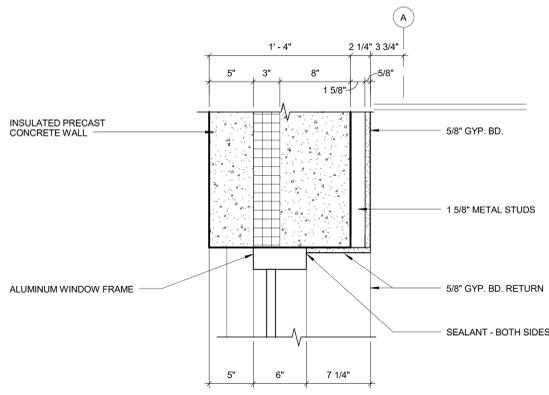


1 WINDOW HEAD DETAIL
A296 1 1/2" = 1'-0"




2 WINDOW HEAD DETAIL
A296 1 1/2" = 1'-0"

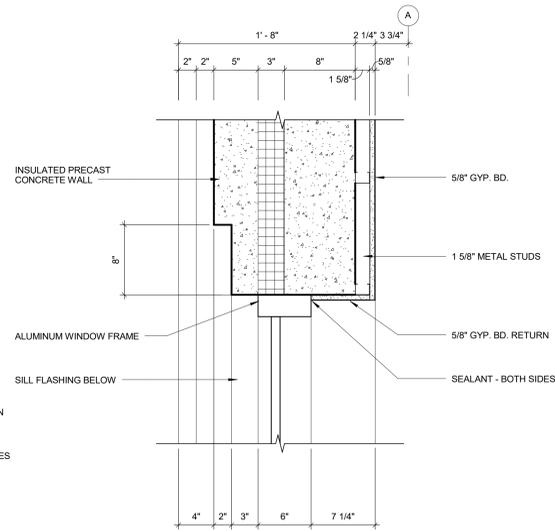


3 WINDOW JAMB DETAIL
A296 1 1/2" = 1'-0"

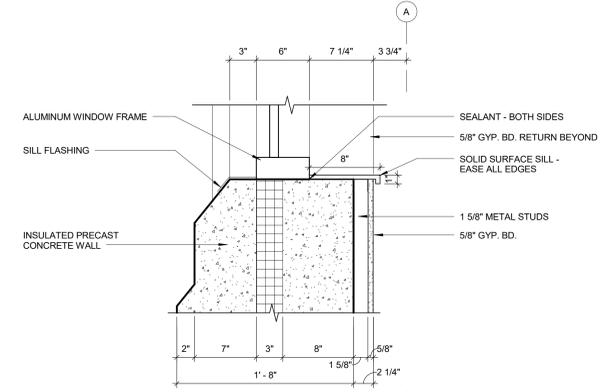


4 WINDOW SILL DETAIL
A296 1 1/2" = 1'-0"

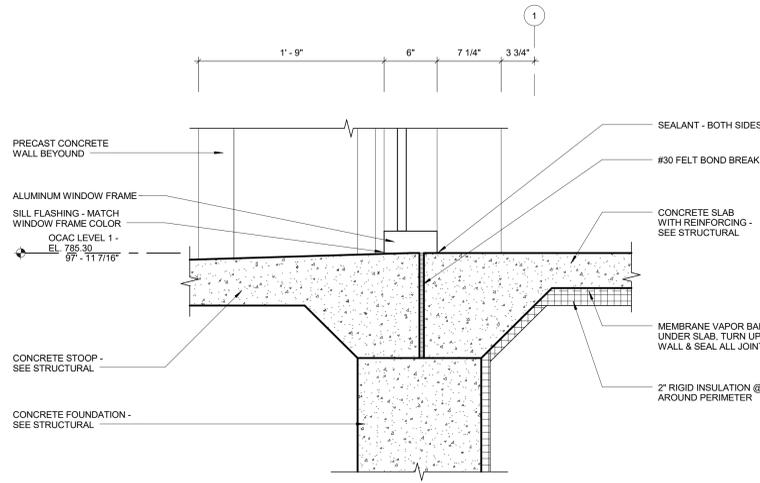


5 WINDOW SILL DETAIL
A296 1 1/2" = 1'-0"

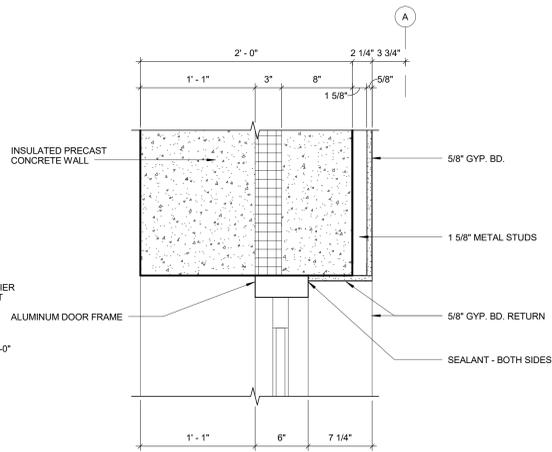


6 DOOR HEAD DETAIL
A296 1 1/2" = 1'-0"

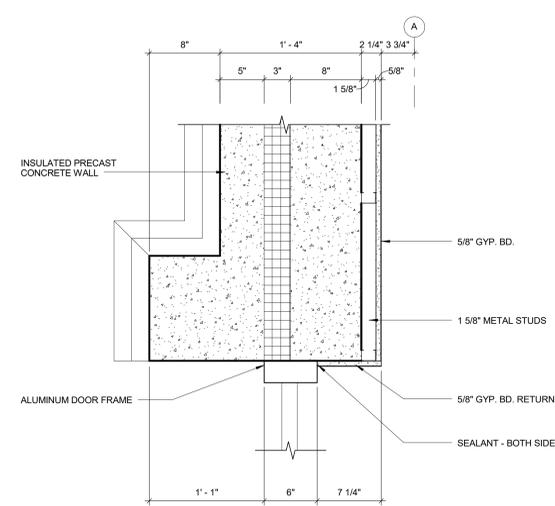


7 DOOR JAMB DETAIL
A296 1 1/2" = 1'-0"

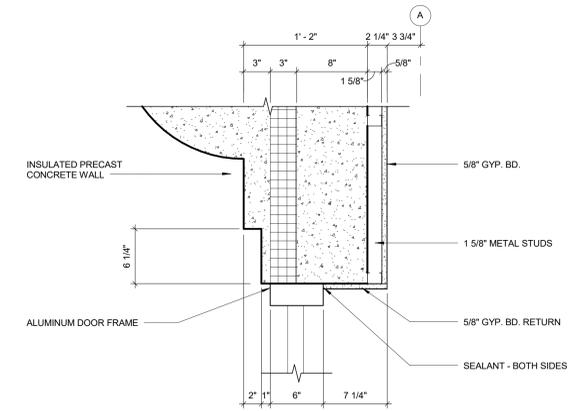


8 DOOR JAMB DETAIL
A296 1 1/2" = 1'-0"

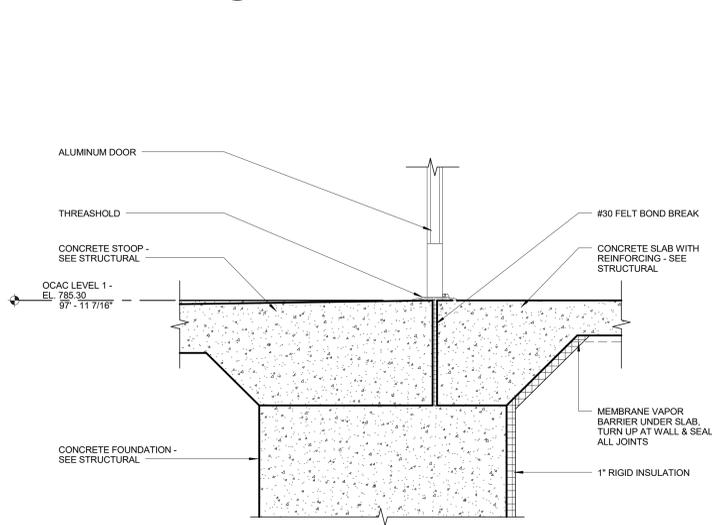


9 DOOR SILL DETAIL
A296 1 1/2" = 1'-0"

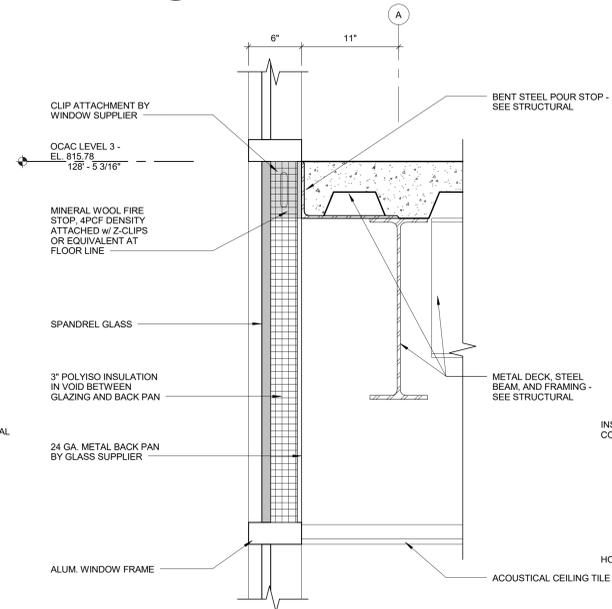


10 WINDOW TO FLOOR CONNECTION
A296 1 1/2" = 1'-0"

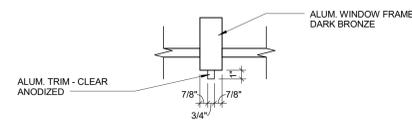


11 WINDOW MULLION DETAIL
A296 1 1/2" = 1'-0"

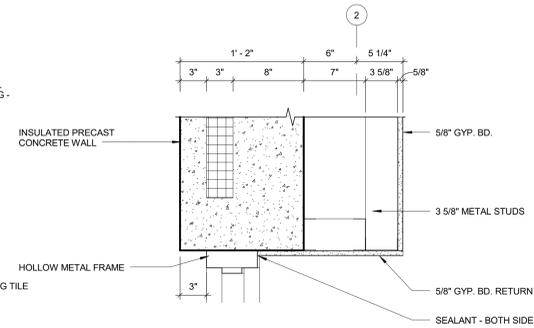

12 DOOR HEAD/JAMB DETAIL
A296 1 1/2" = 1'-0"

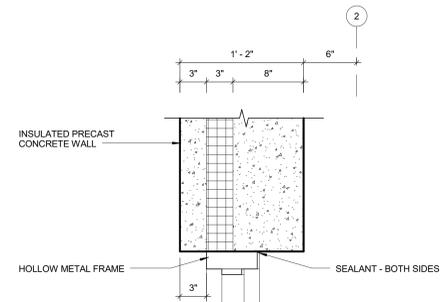

13 DOOR HEAD/JAMB DETAIL
A296 1 1/2" = 1'-0"

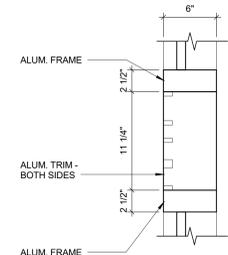

14 DOOR HEAD DETAIL
A296 1 1/2" = 1'-0"

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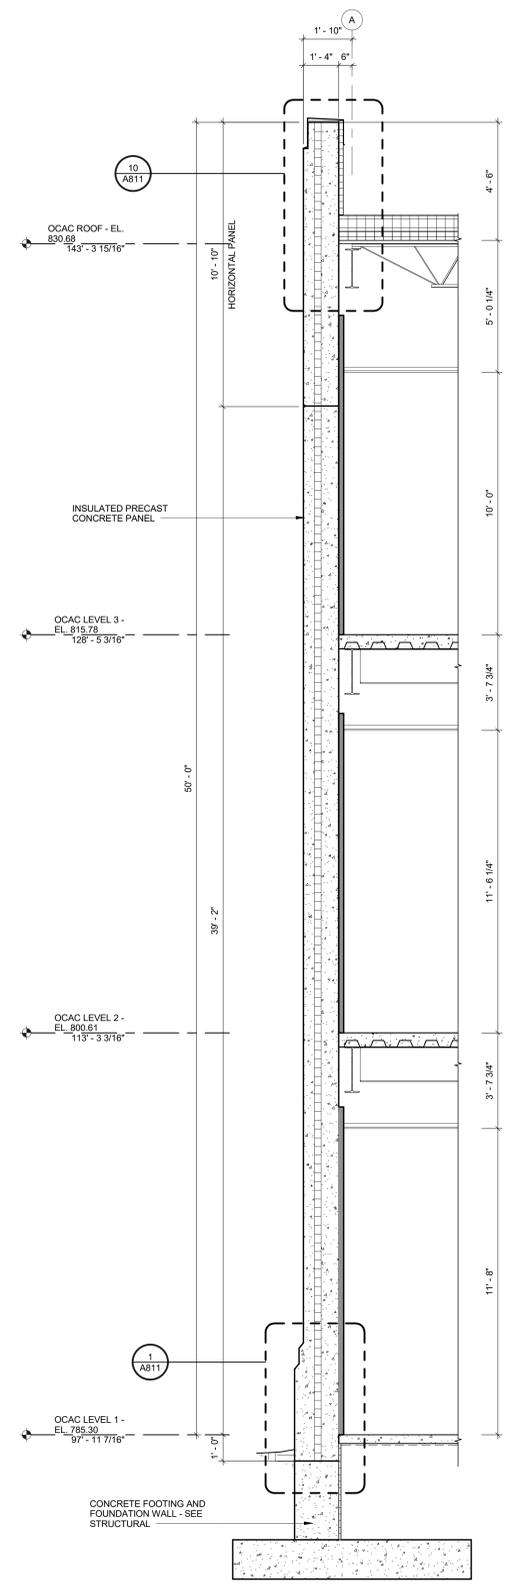
REVISION

DATE


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ALTERATION / ADDITION
OUTAGAME COUNTY ADMINISTRATION CENTER
S. WALNUT & W. 8TH, APPLETON WI 54911
EXTERIOR DOOR AND WINDOW DETAILS


DESIGNED	DRAWN
ASF/MAG	BLG
PROJECT NO. 0002-61600160	
DATE MARCH 3, 2017	
SHEET NO. A296	




1 WALL SECTION
A320 3/8" = 1'-0"

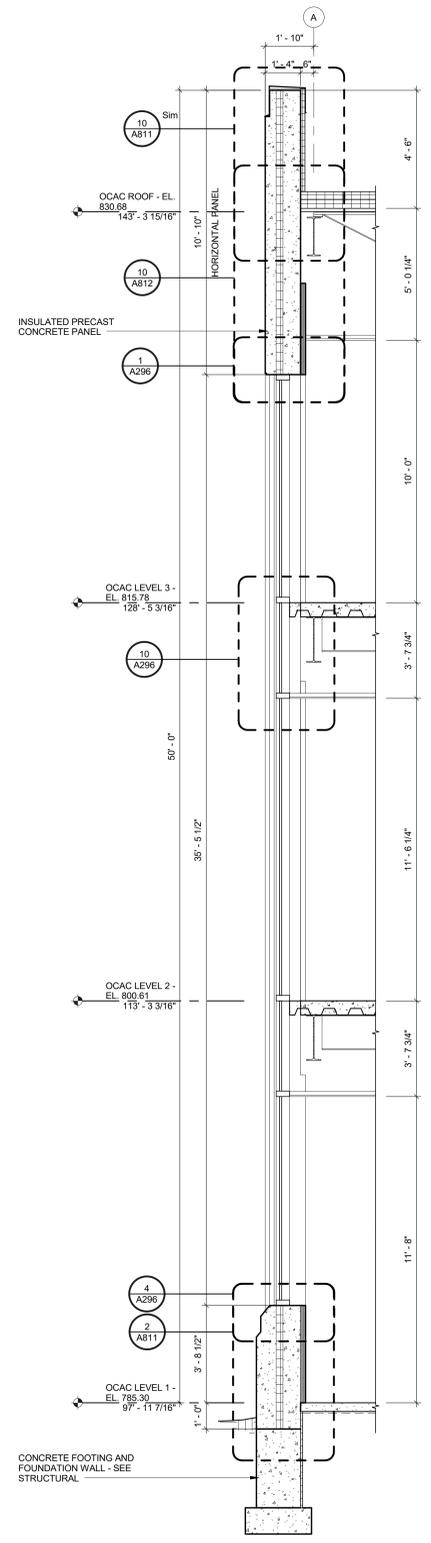

2 WALL SECTION
A320 3/8" = 1'-0"

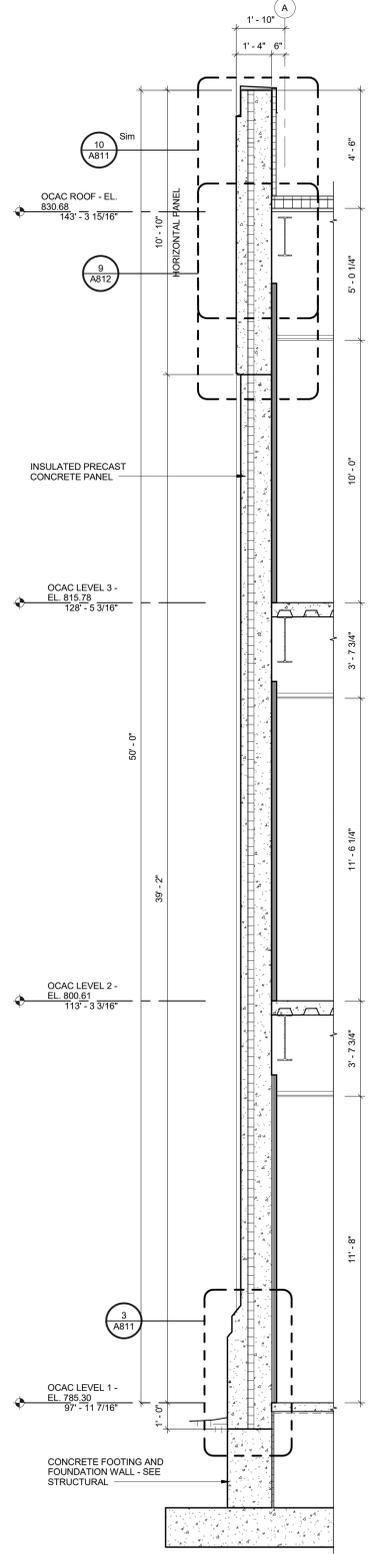

3 WALL SECTION
A320 3/8" = 1'-0"

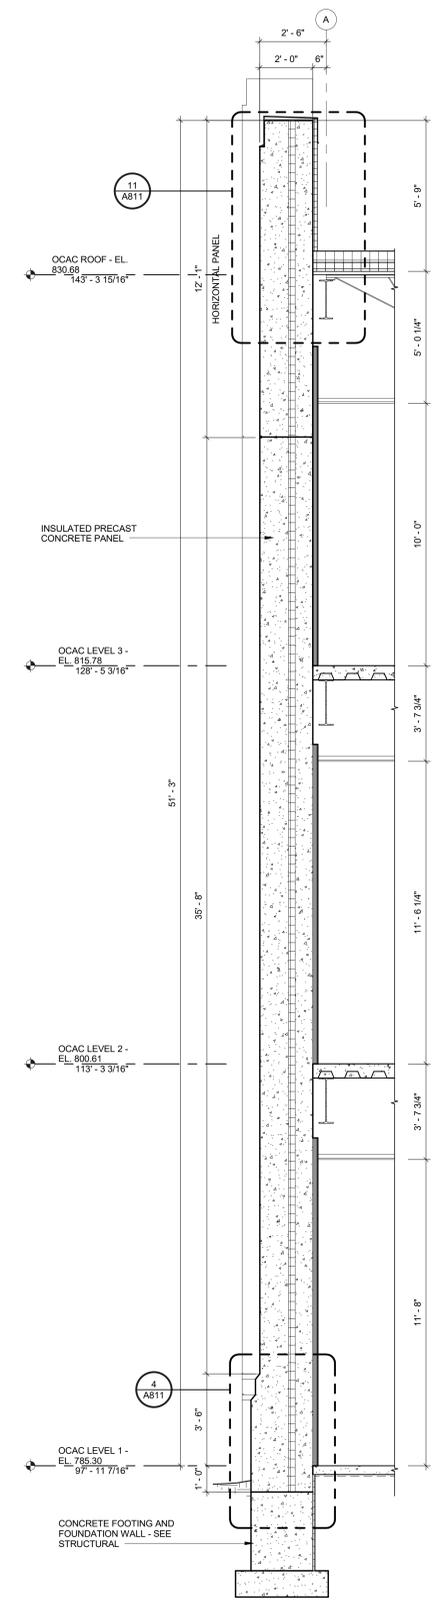


4 WALL SECTION
A320 3/8" = 1'-0"

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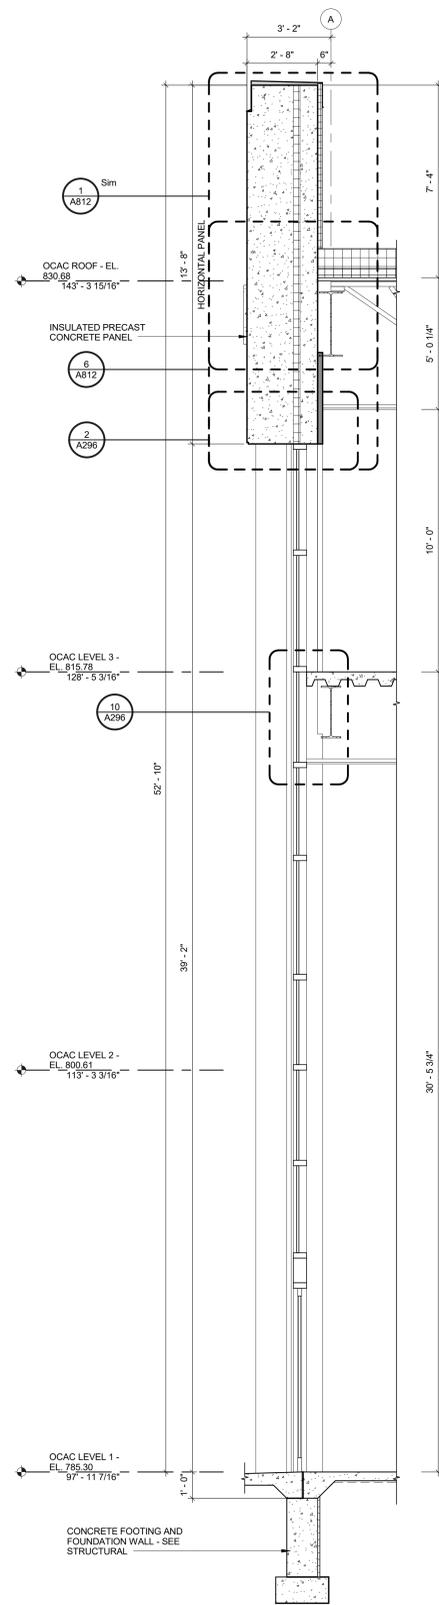
NO.	DATE	REVISION

ALTERATION / ADDITION
OUTAGAME COUNTY ADMINISTRATION CENTER
S. WALNUT & W. 8TH, APPLETON WI 54911
WALL SECTIONS


DESIGNED ASF	DRAWN BLG
PROJECT NO. 0002-61600160	
DATE MARCH 3, 2017	
SHEET NO. A320	

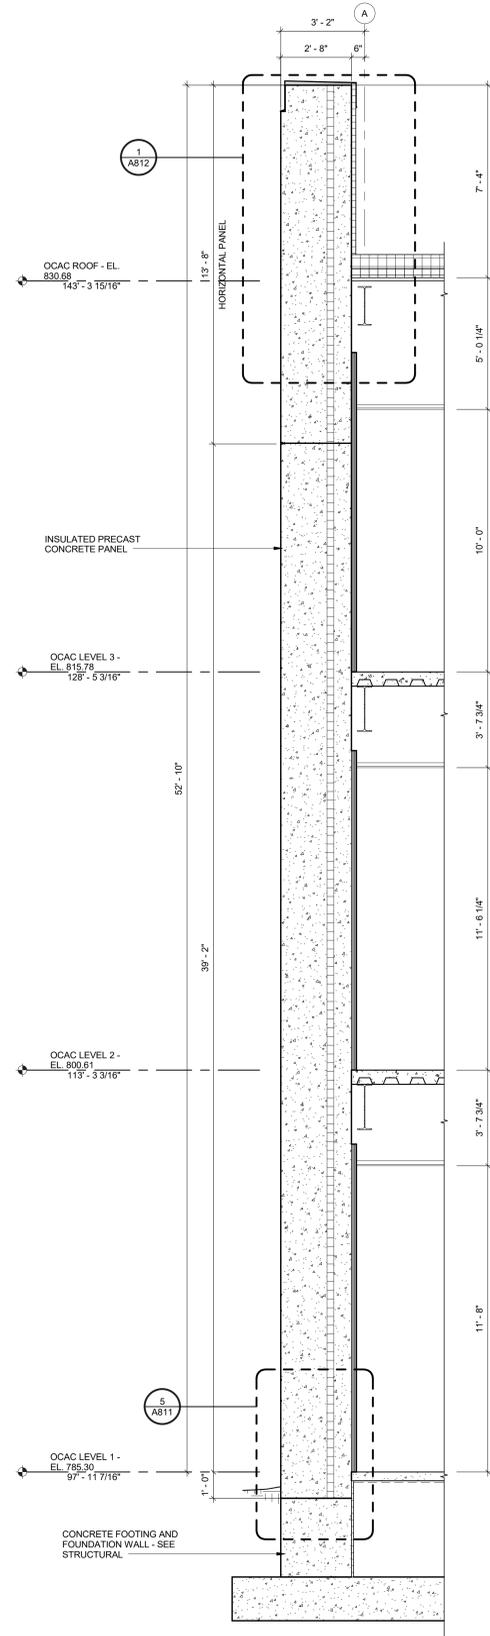


1 WALL SECTION
A321 3/8" = 1'-0"



2 WALL SECTION
A321 3/8" = 1'-0"

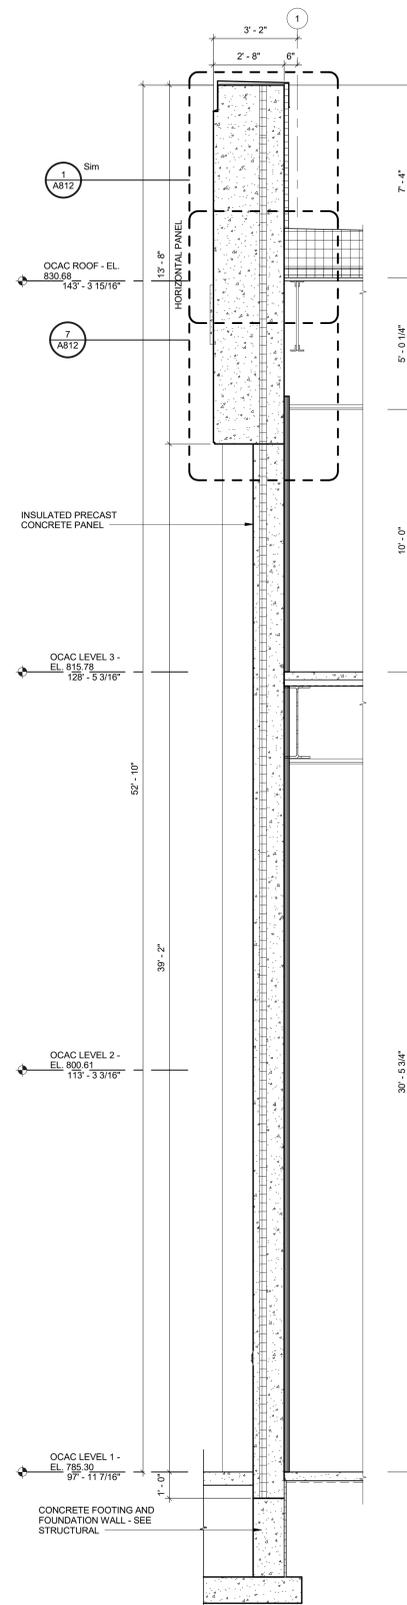

3 WALL SECTION
A321 3/8" = 1'-0"

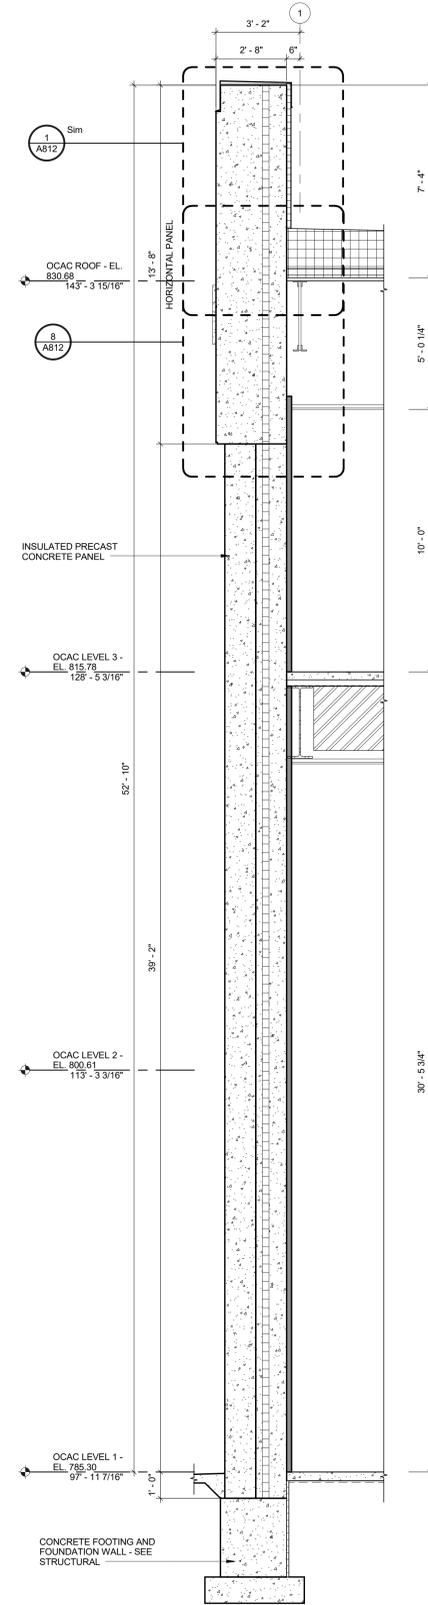

4 WALL SECTION
A321 3/8" = 1'-0"


McMahon provides this drawing as a service to the client. The client is responsible for the accuracy of the information provided. McMahon is not responsible for any errors or omissions in this drawing. All dimensions are in feet and inches. Changes made to the original drawing must be in writing and signed by McMahon.

NO.	DATE	REVISION


ALTERATION / ADDITION
OUTAGAMIE COUNTY ADMINISTRATION CENTER
S. WALNUT & W. 8TH, APPLETON WI 54911
WALL SECTIONS

DESIGNED	DRAWN
ASF	BLG
PROJECT NO.	
0002-61600160	
DATE	
MARCH 3, 2017	
SHEET NO.	


A321

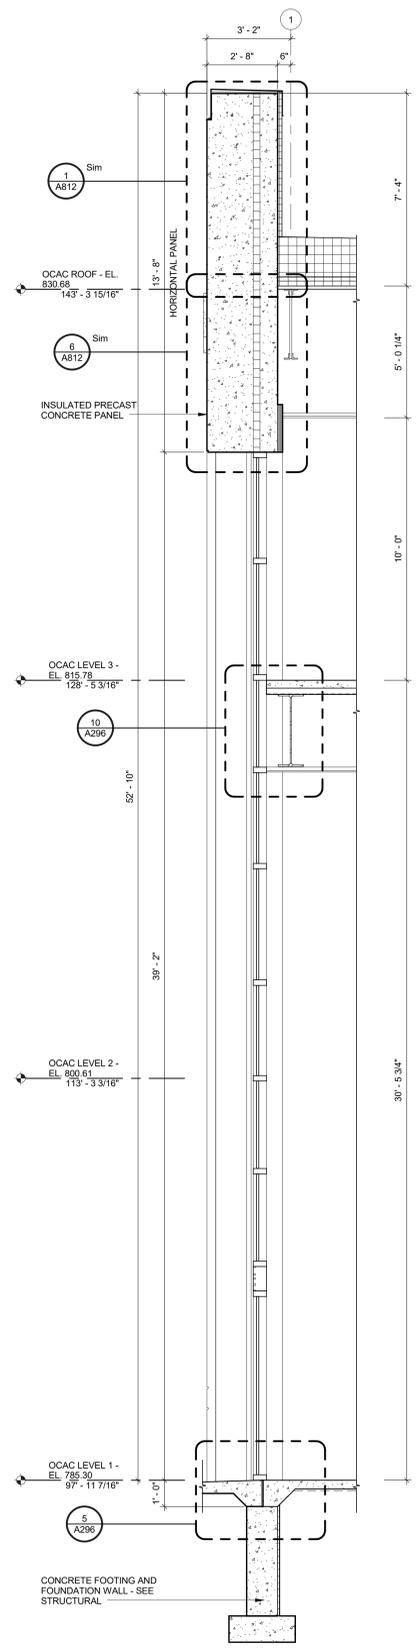


1 WALL SECTION
A322 3/8" = 1'-0"

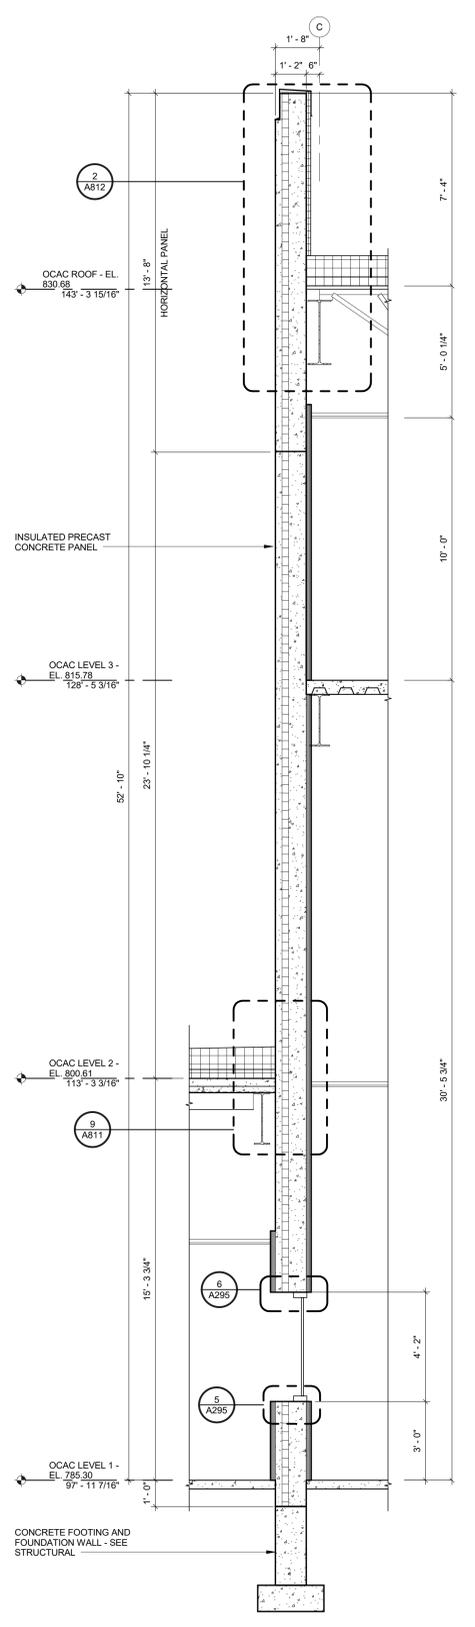

2 WALL SECTION
A322 3/8" = 1'-0"

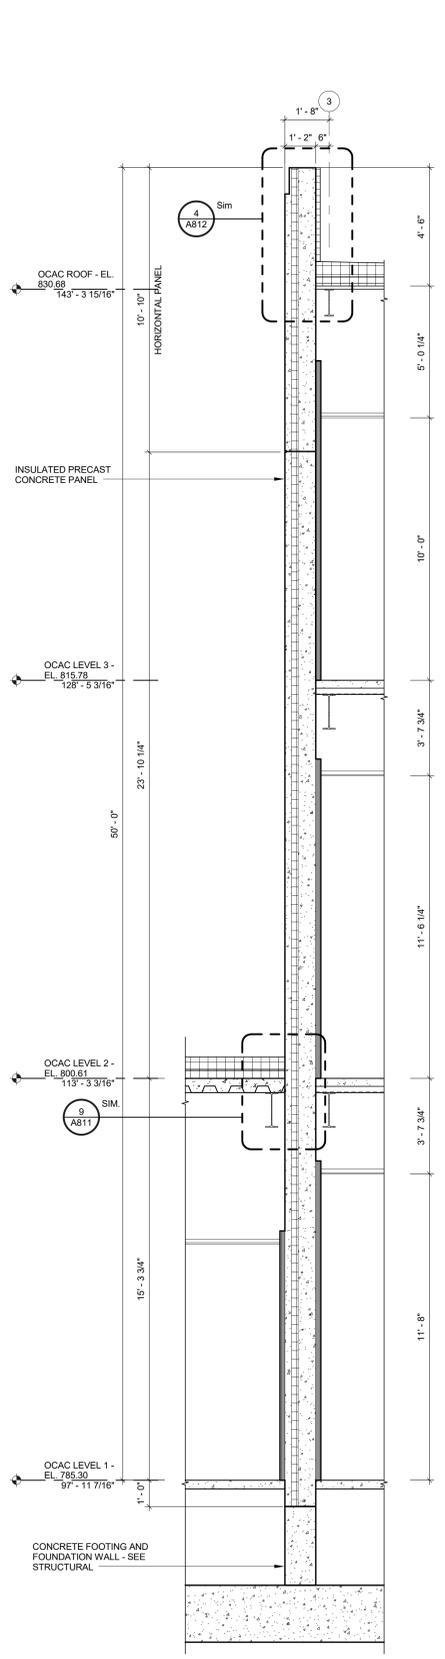

3 WALL SECTION
A322 3/8" = 1'-0"

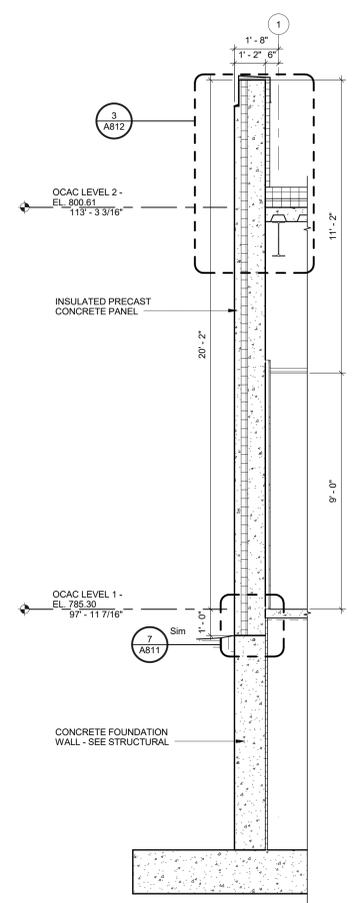


4 WALL SECTION
A322 3/8" = 1'-0"

McMahon provides this drawing as a representation of service. All information is provided as is. The client is responsible for the accuracy of the information. McMahon is not responsible for any errors or omissions. All changes made to the original drawing must be in writing and signed by McMahon.


NO.	DATE	REVISION

ALTERATION / ADDITION
OUTAGAME COUNTY ADMINISTRATION CENTER
S. WALNUT & W. 8TH, APPLETON WI 54911
WALL SECTIONS


DESIGNED ASF	DRAWN BLG
PROJECT NO. 0002-61600160	
DATE MARCH 3, 2017	
SHEET NO. A322	

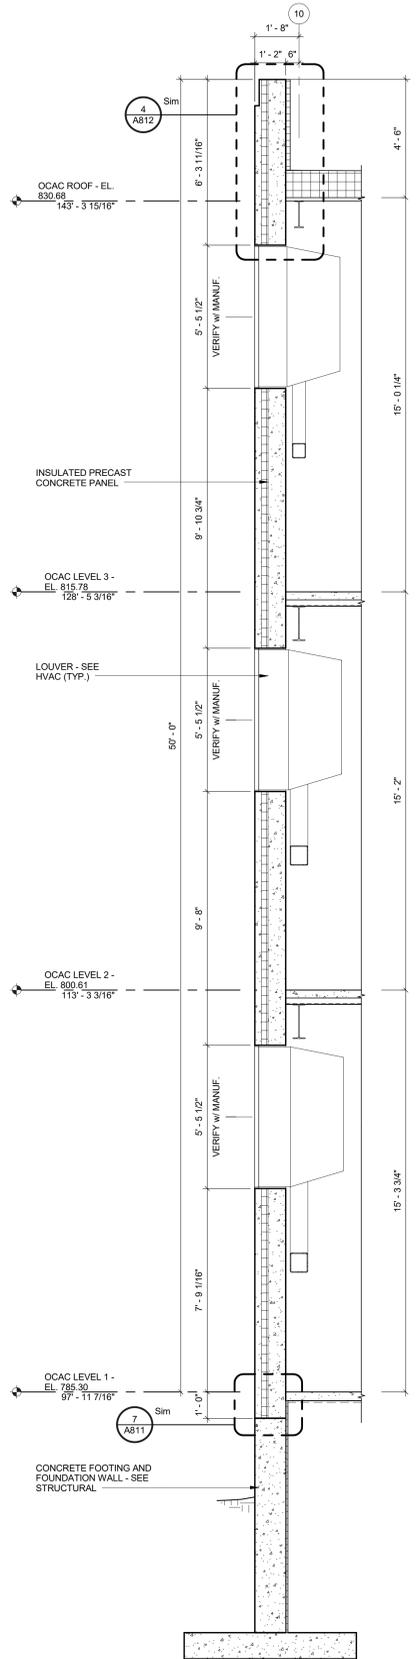

1 WALL SECTION
A324 3/8" = 1'-0"

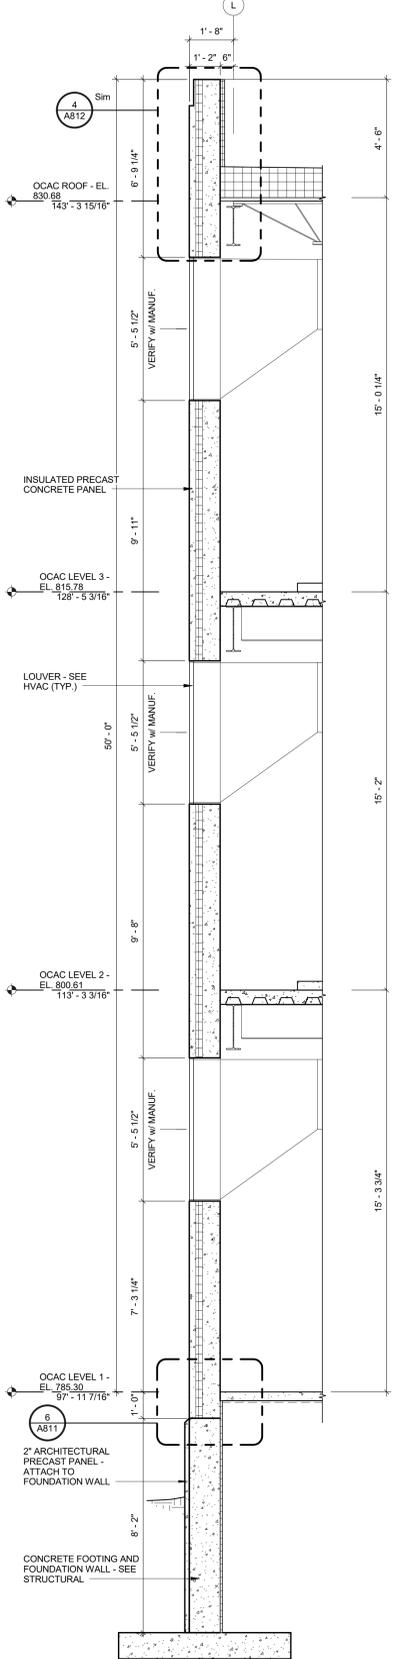

2 WALL SECTION
A324 3/8" = 1'-0"

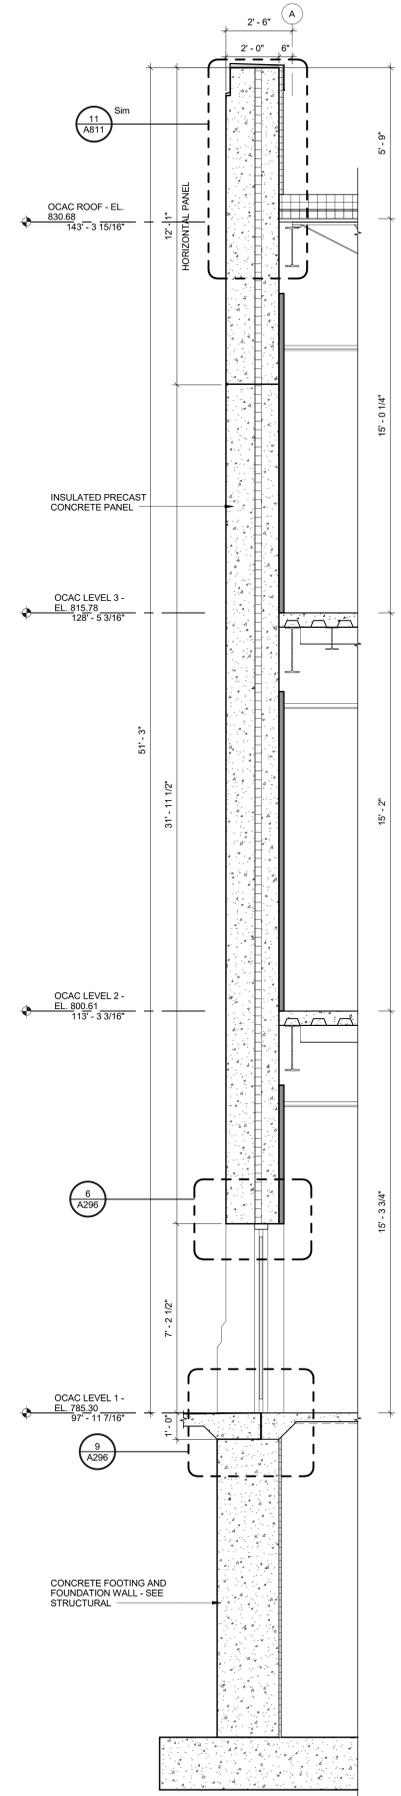

3 WALL SECTION
A324 3/8" = 1'-0"

NO.	DATE	REVISION

ALTERATION / ADDITION
OUTAGAME COUNTY ADMINISTRATION CENTER
S. WALNUT & W. 8TH, APPLETON WI 54911
WALL SECTIONS


DESIGNED	DRAWN
ASF	BLG
PROJECT NO. 0002-61600160	
DATE MARCH 3, 2017	
SHEET NO. A324	

OCAC ROOF - EL.
830.66
143'-3 15/16"

OCAC LEVEL 3 - EL.
815.78
128'-3 3/16"

OCAC LEVEL 2 - EL.
800.81
113'-3 3/16"

OCAC LEVEL 1 - EL.
785.30
97'-11 7/16"

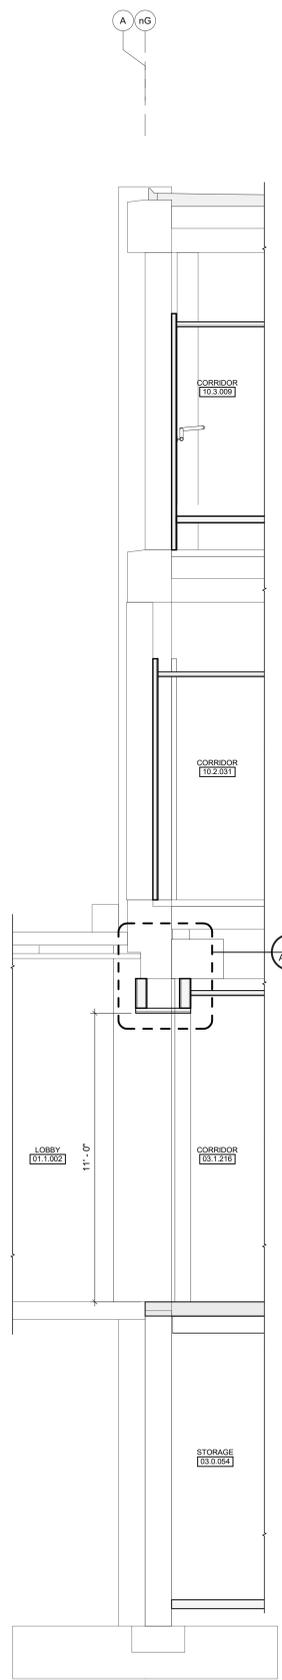


1 SECTION
A325 3/8" = 1'-0"

OCAC ROOF - EL.
830.66
143'-3 15/16"

OCAC LEVEL 3 - EL.
815.78
128'-3 3/16"

OCAC LEVEL 2 - EL.
800.81
113'-3 3/16"

OCAC LEVEL 1 - EL.
785.30
97'-11 7/16"

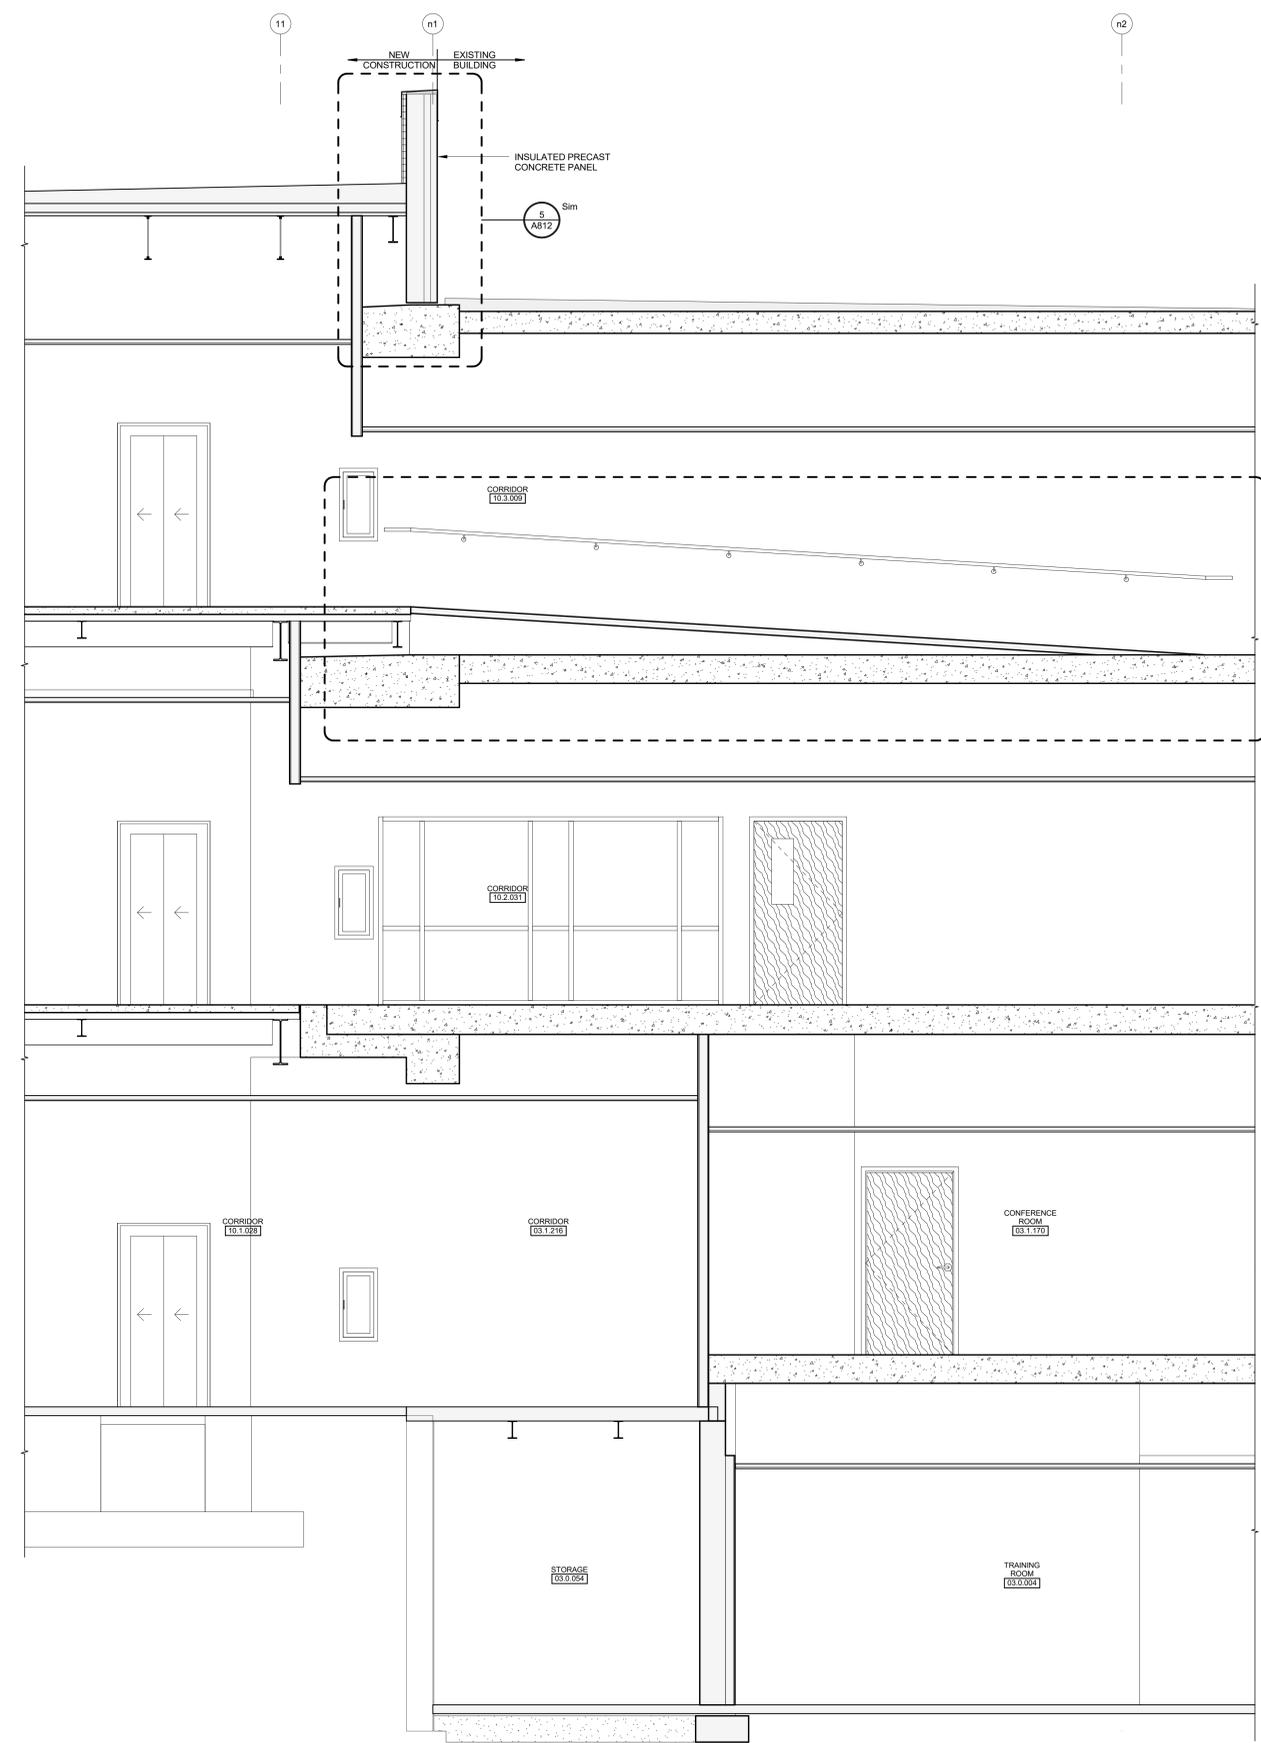


2 SECTION
A325 3/8" = 1'-0"

McMahon provides this drawing as a representation of service. All information is based on data furnished by the client. The client is responsible for the accuracy of the information. McMahon is not responsible for any errors or omissions in this drawing. Changes made to the original drawing shall be noted in the revision block.


NO.	DATE	REVISION

ALTERATION / ADDITION
OUTAGAMIE COUNTY ADMINISTRATION CENTER
S. WALNUT & W. 8TH, APPLETON WI 54911
SECTIONS

DESIGNED	DRAWN
ASF	BLG
PROJECT NO. 0002-61600160	
DATE MARCH 3, 2017	
SHEET NO. A325	

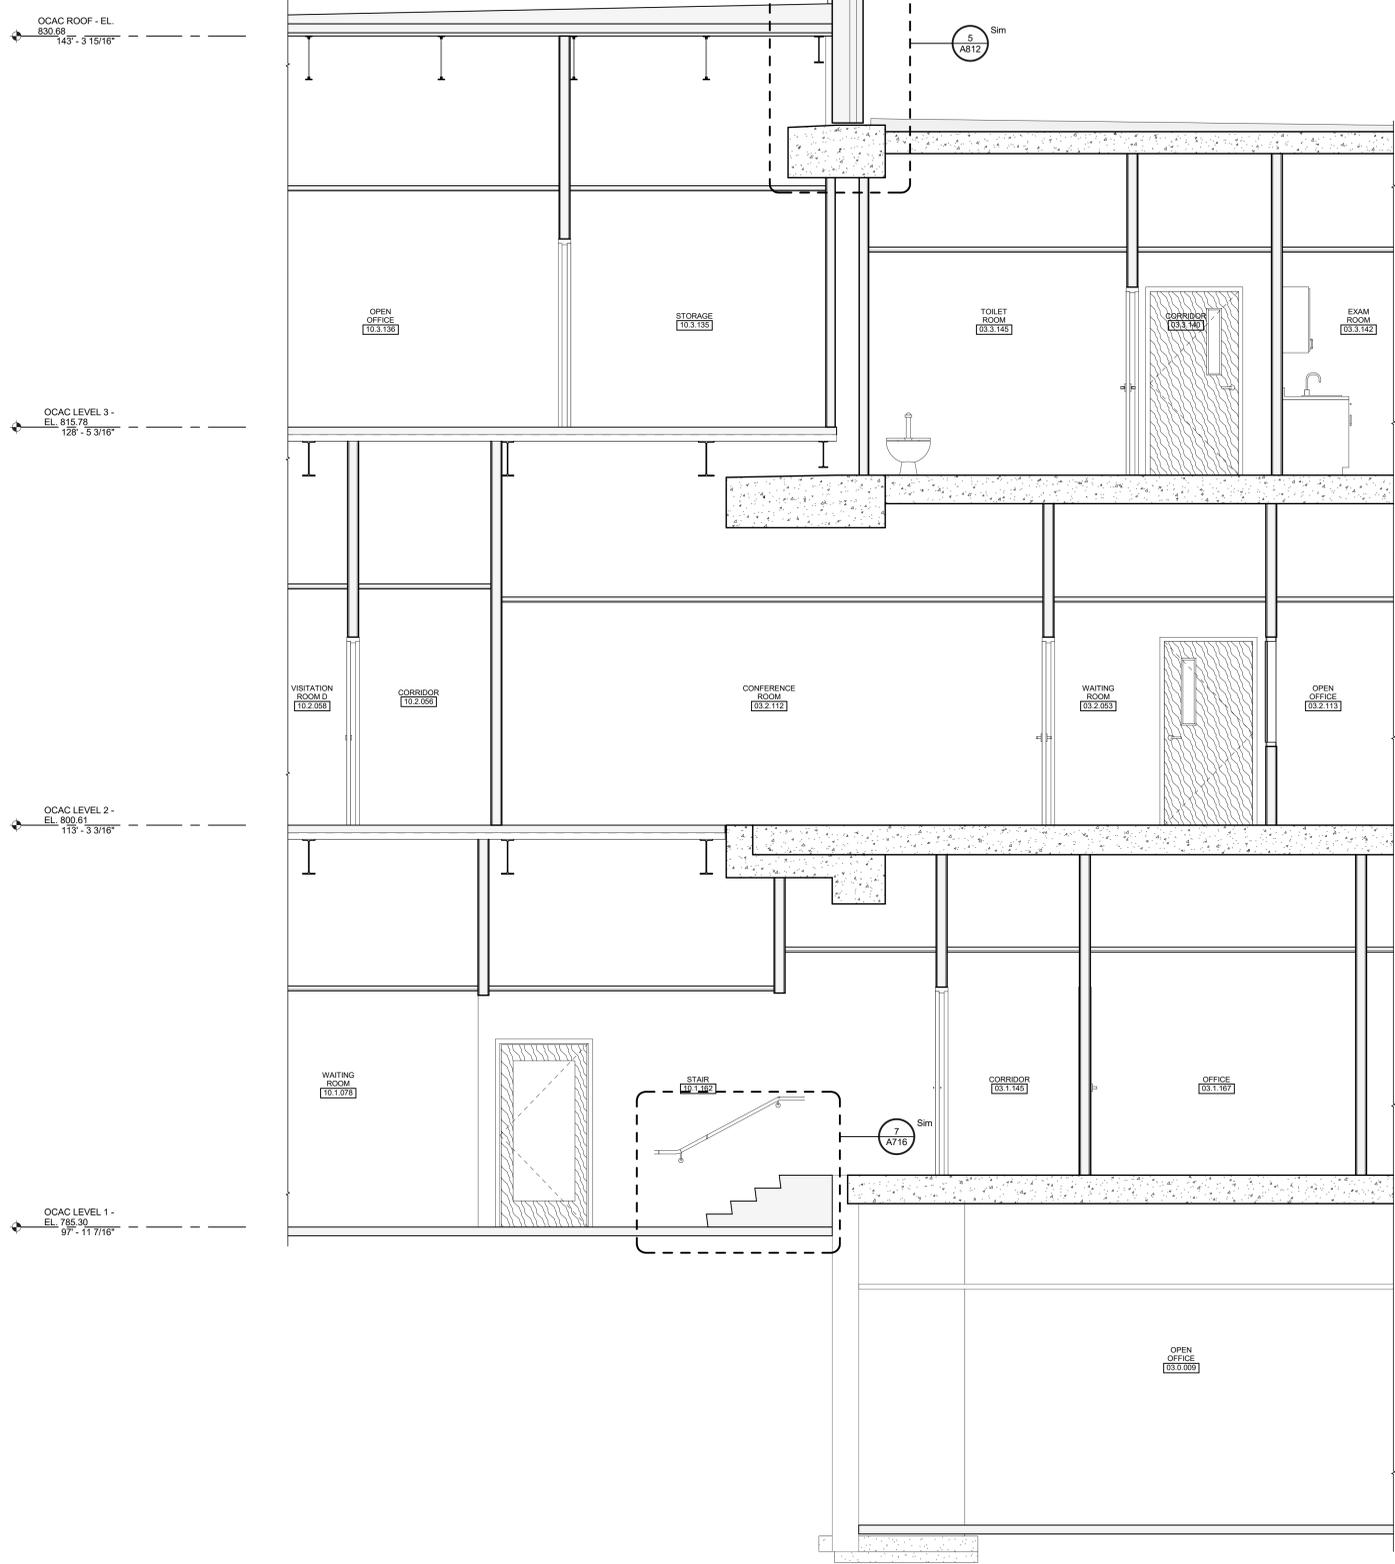

1 SECTION
A326 3/8" = 1'-0"

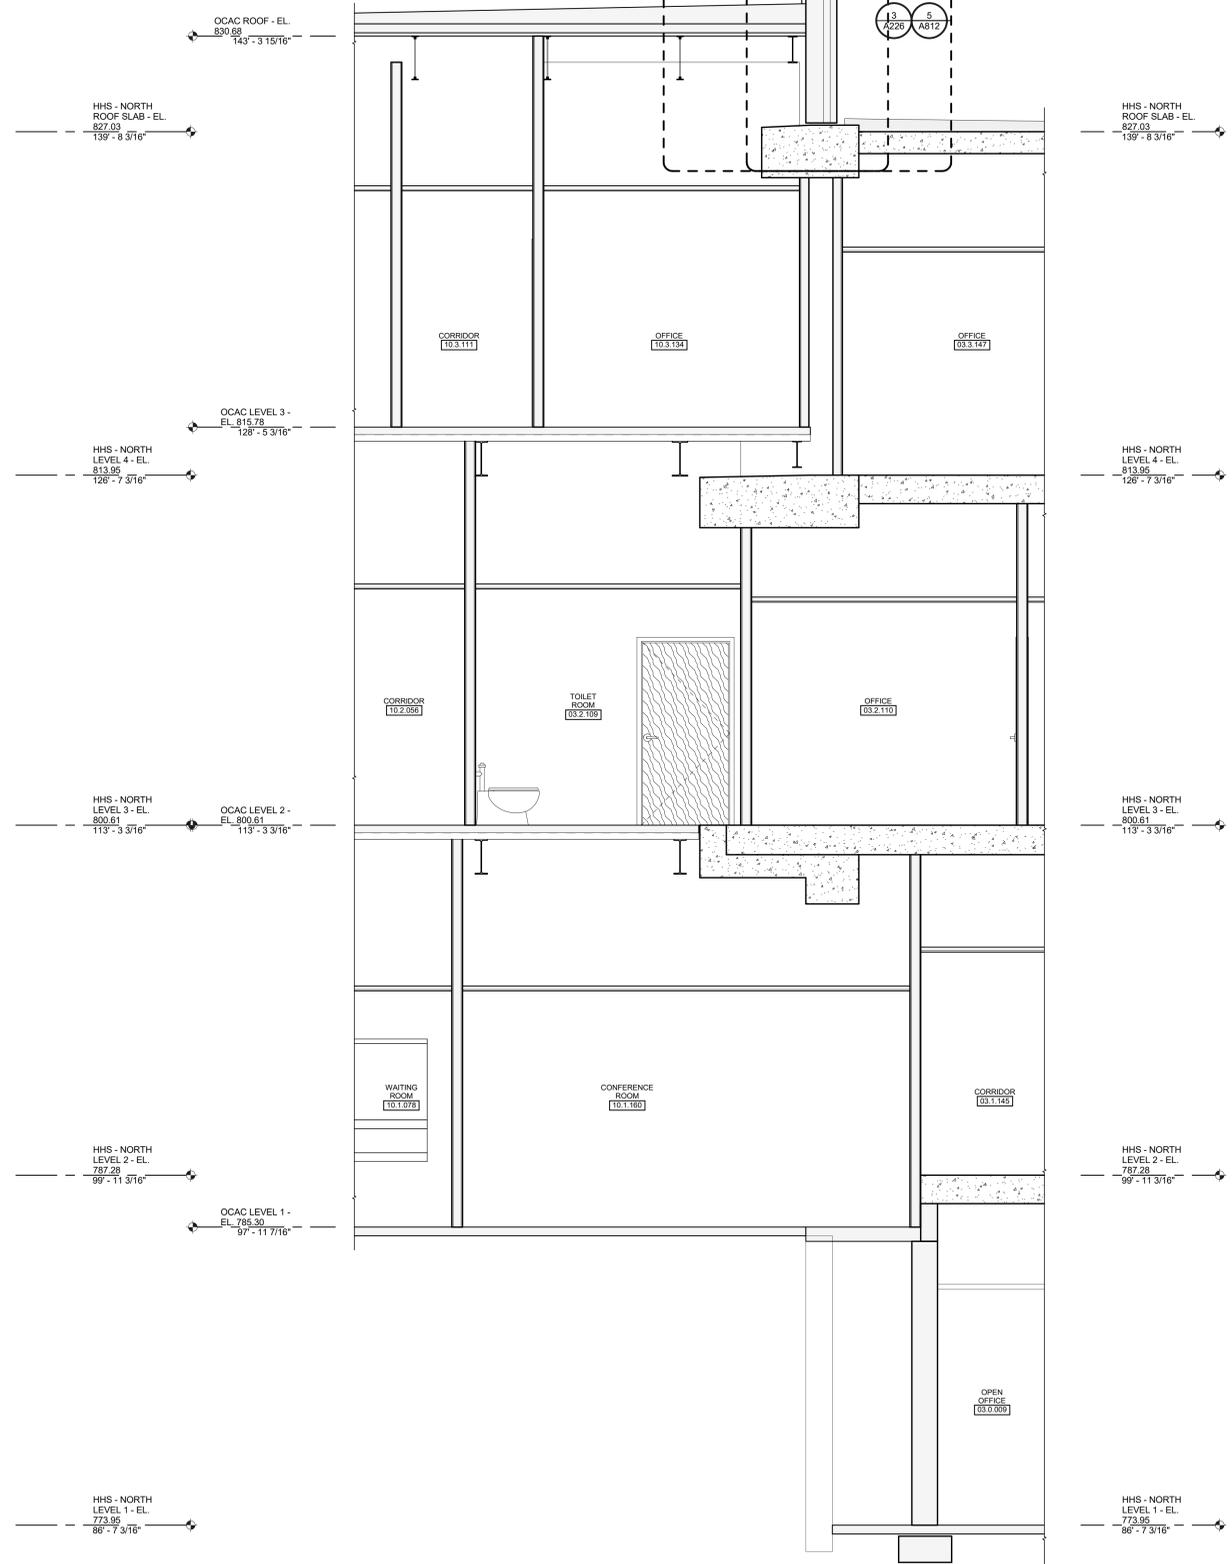


2 SECTION
A326 3/8" = 1'-0"


McMahon provides this drawing as a service to the client. All information is provided as is. The client is responsible for verifying the accuracy of the information. McMahon is not responsible for any errors or omissions. Changes made to the original drawing must be in writing and signed by McMahon.

NO.	DATE	REVISION

DESIGNED: ASF
DRAWN: BLG
PROJECT NO.: 00002-61600160
DATE: MARCH 3, 2017
SHEET NO.: A326

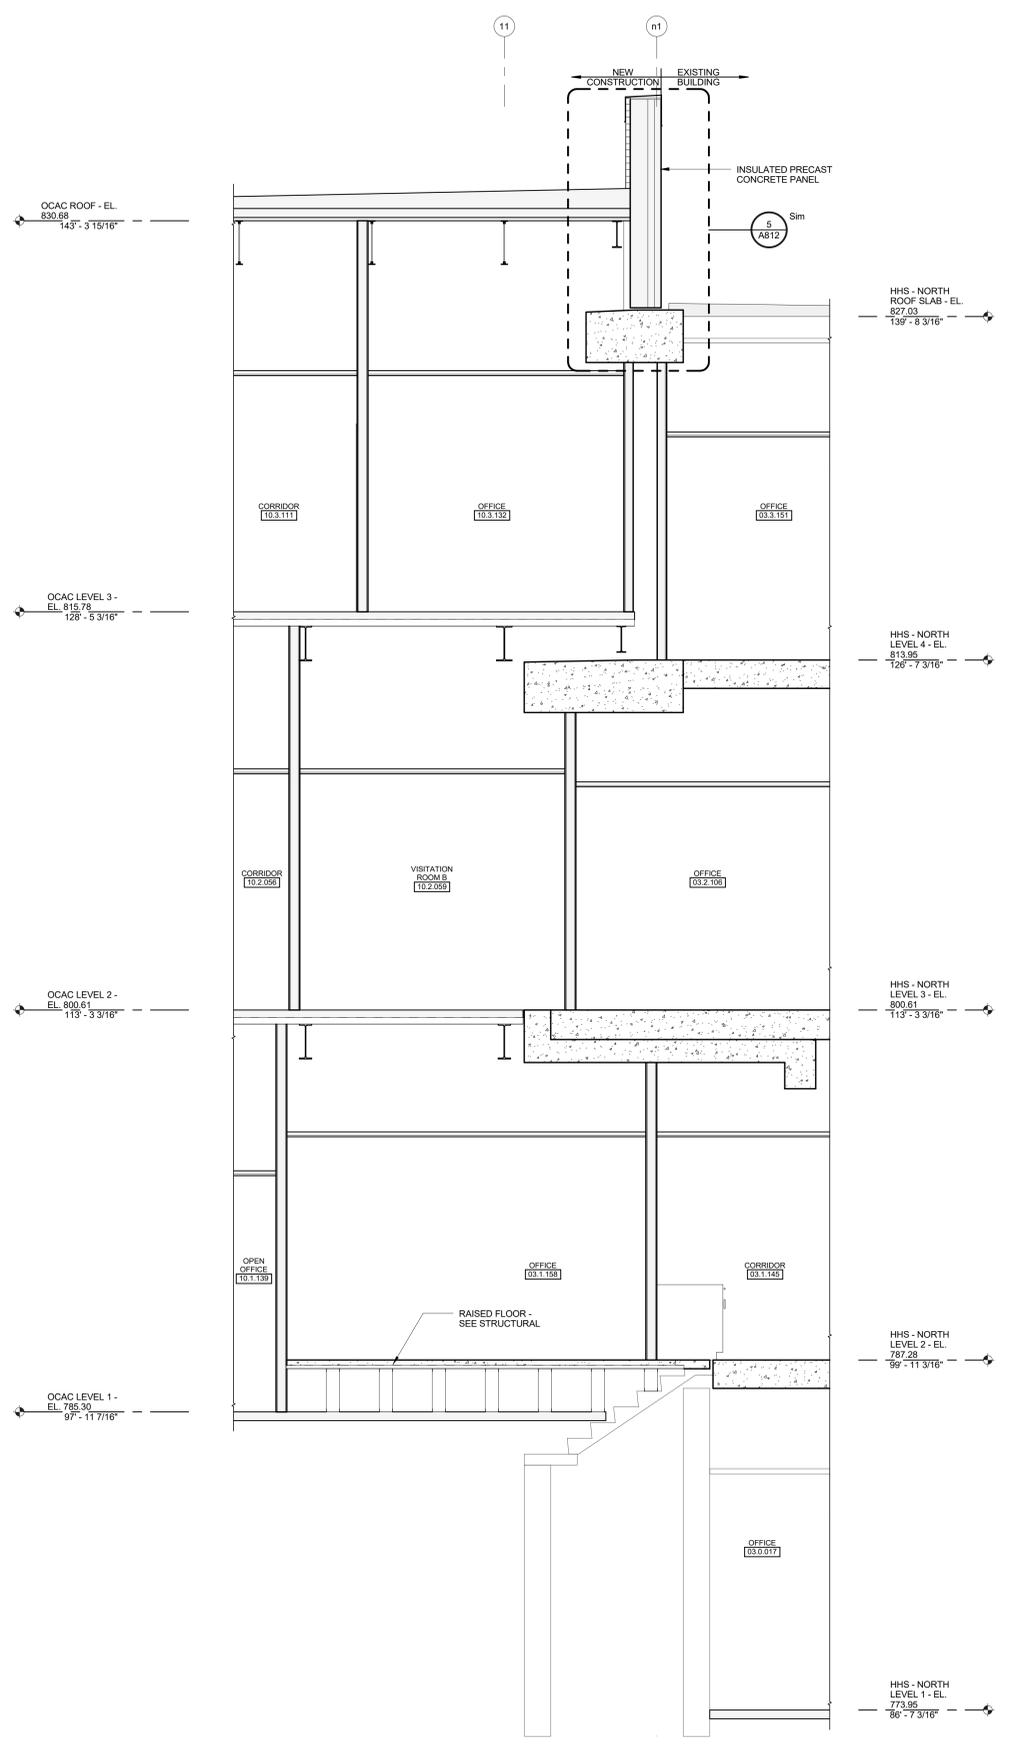

1 SECTION
A327 3/8" = 1'-0"

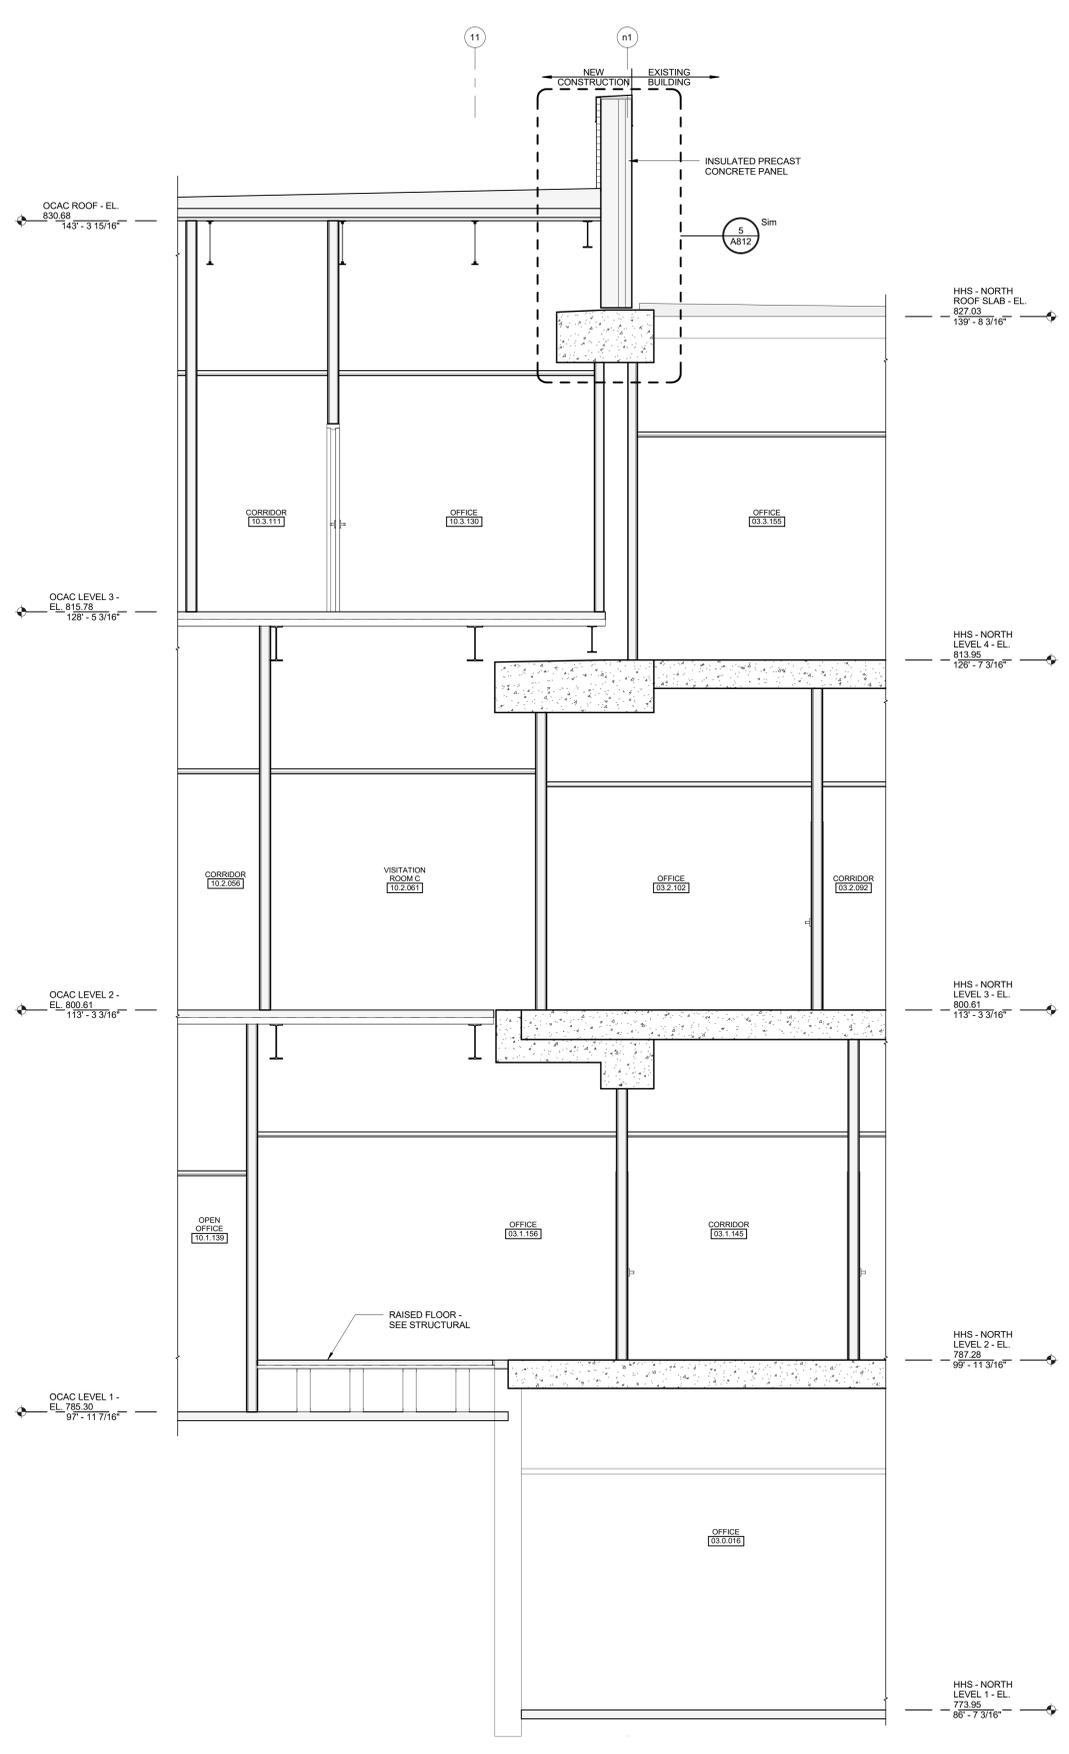


2 SECTION
A327 3/8" = 1'-0"

McMahon provides this drawing as a service to the client. It is not to be used for any other purpose without the written consent of McMahon. The client is responsible for verifying the accuracy of the information provided by McMahon. The client is responsible for obtaining all necessary permits and approvals from the appropriate authorities. McMahon is not responsible for any errors or omissions in this drawing, or for any consequences arising from the use of this drawing. All changes made to the original drawing must be in writing and signed by McMahon.


NO.	DATE	REVISION

ALTERATION / ADDITION
OUTAGAME COUNTY ADMINISTRATION CENTER
S. WALNUT & W. 8TH, APPLETON WI 54911
SECTIONS

DESIGNED	DRAWN
ASF	BLG
PROJECT NO. 0002-61600160	
DATE MARCH 3, 2017	
SHEET NO. A327	

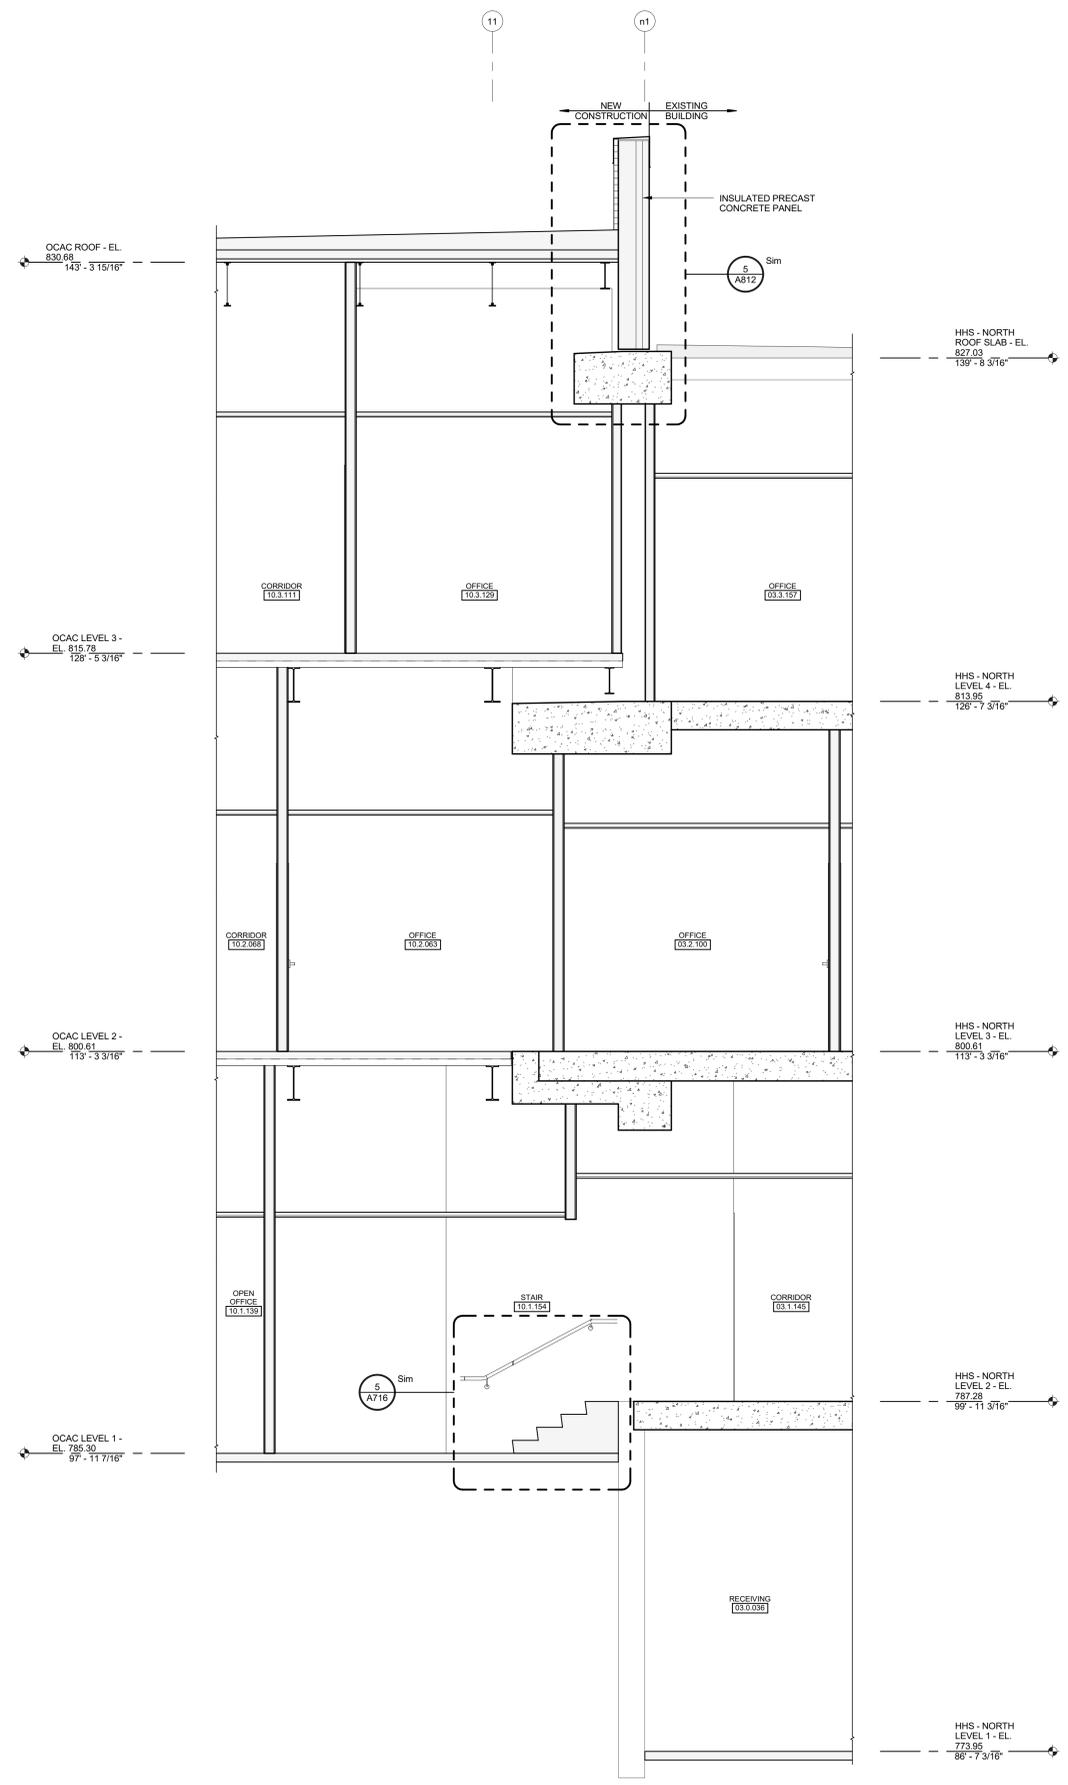

1 SECTION
A328 3/8" = 1'-0"

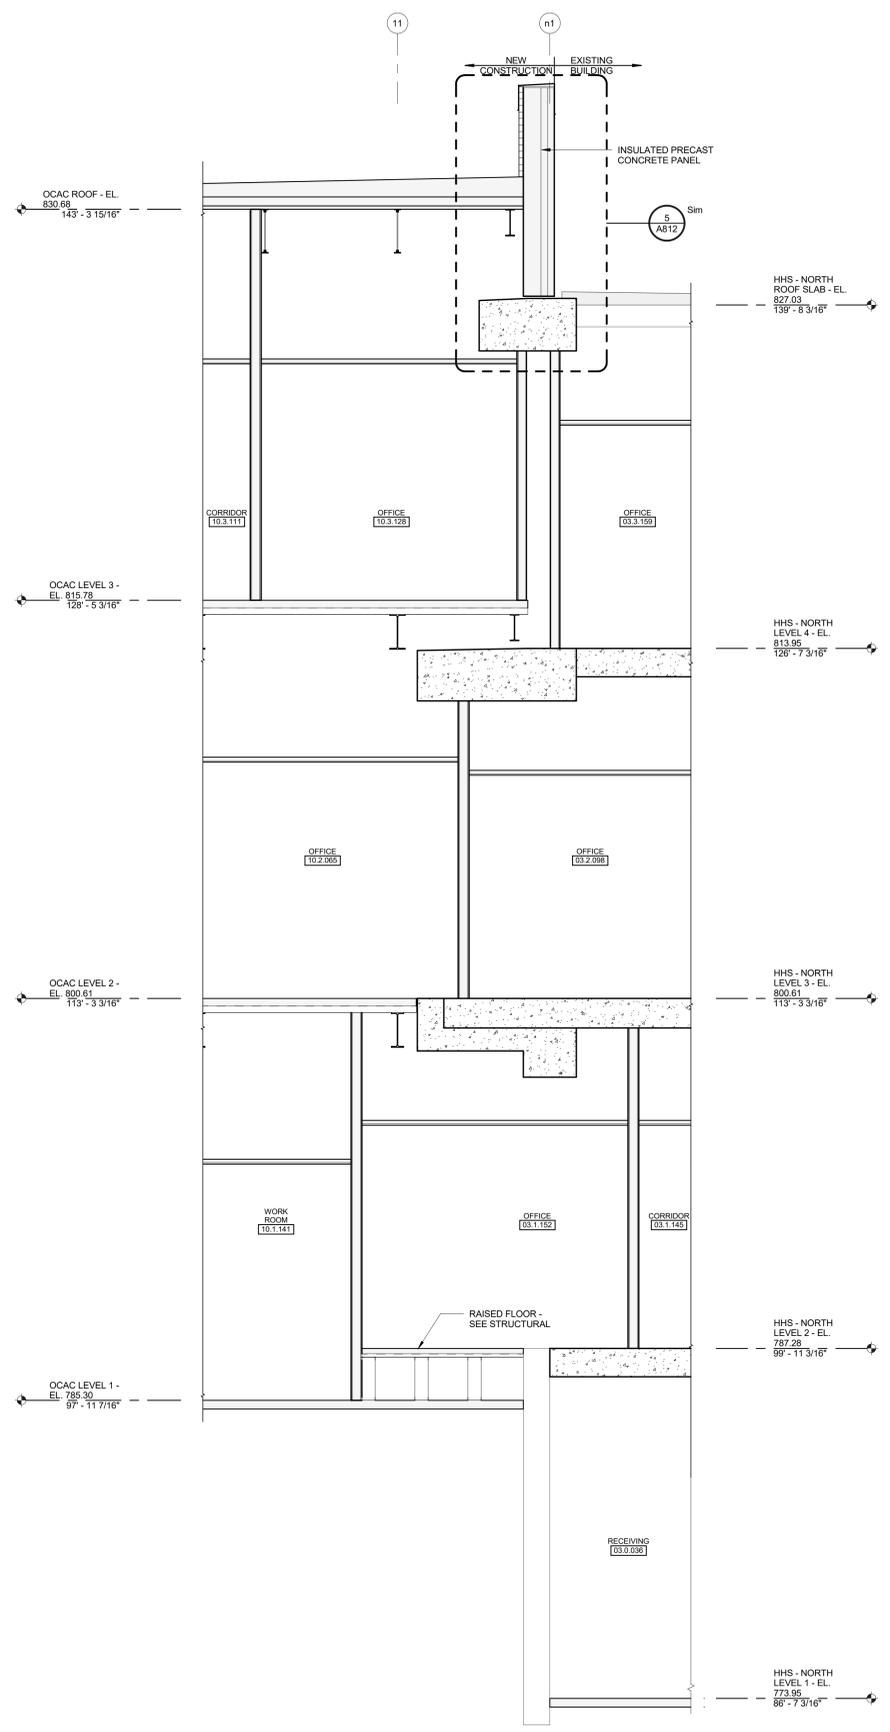


2 SECTION
A328 3/8" = 1'-0"


McMahon provides this drawing as a service to the client. The client is responsible for the accuracy of the information provided. McMahon is not responsible for any errors or omissions in this drawing. All changes made to the original drawing must be in writing and signed by McMahon.

NO.	DATE	REVISION

DESIGNED / DRAWN
 ASF / BLG
 PROJECT NO.
 0002-61600160
 DATE
 MARCH 3, 2017
 SHEET NO.

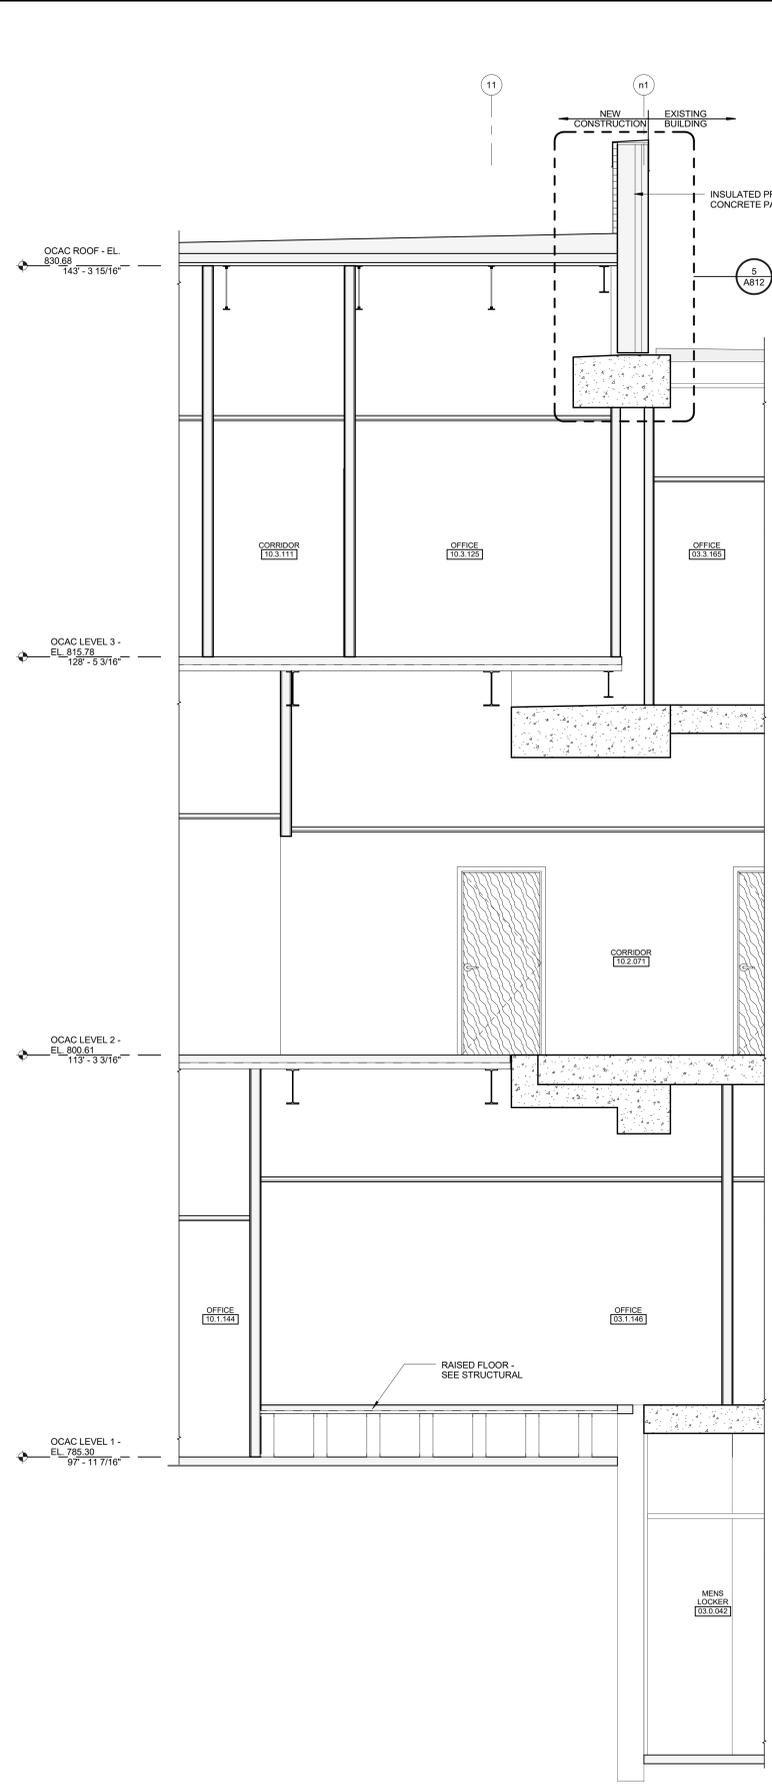

SECTION 1
A329 3/8" = 1'-0"

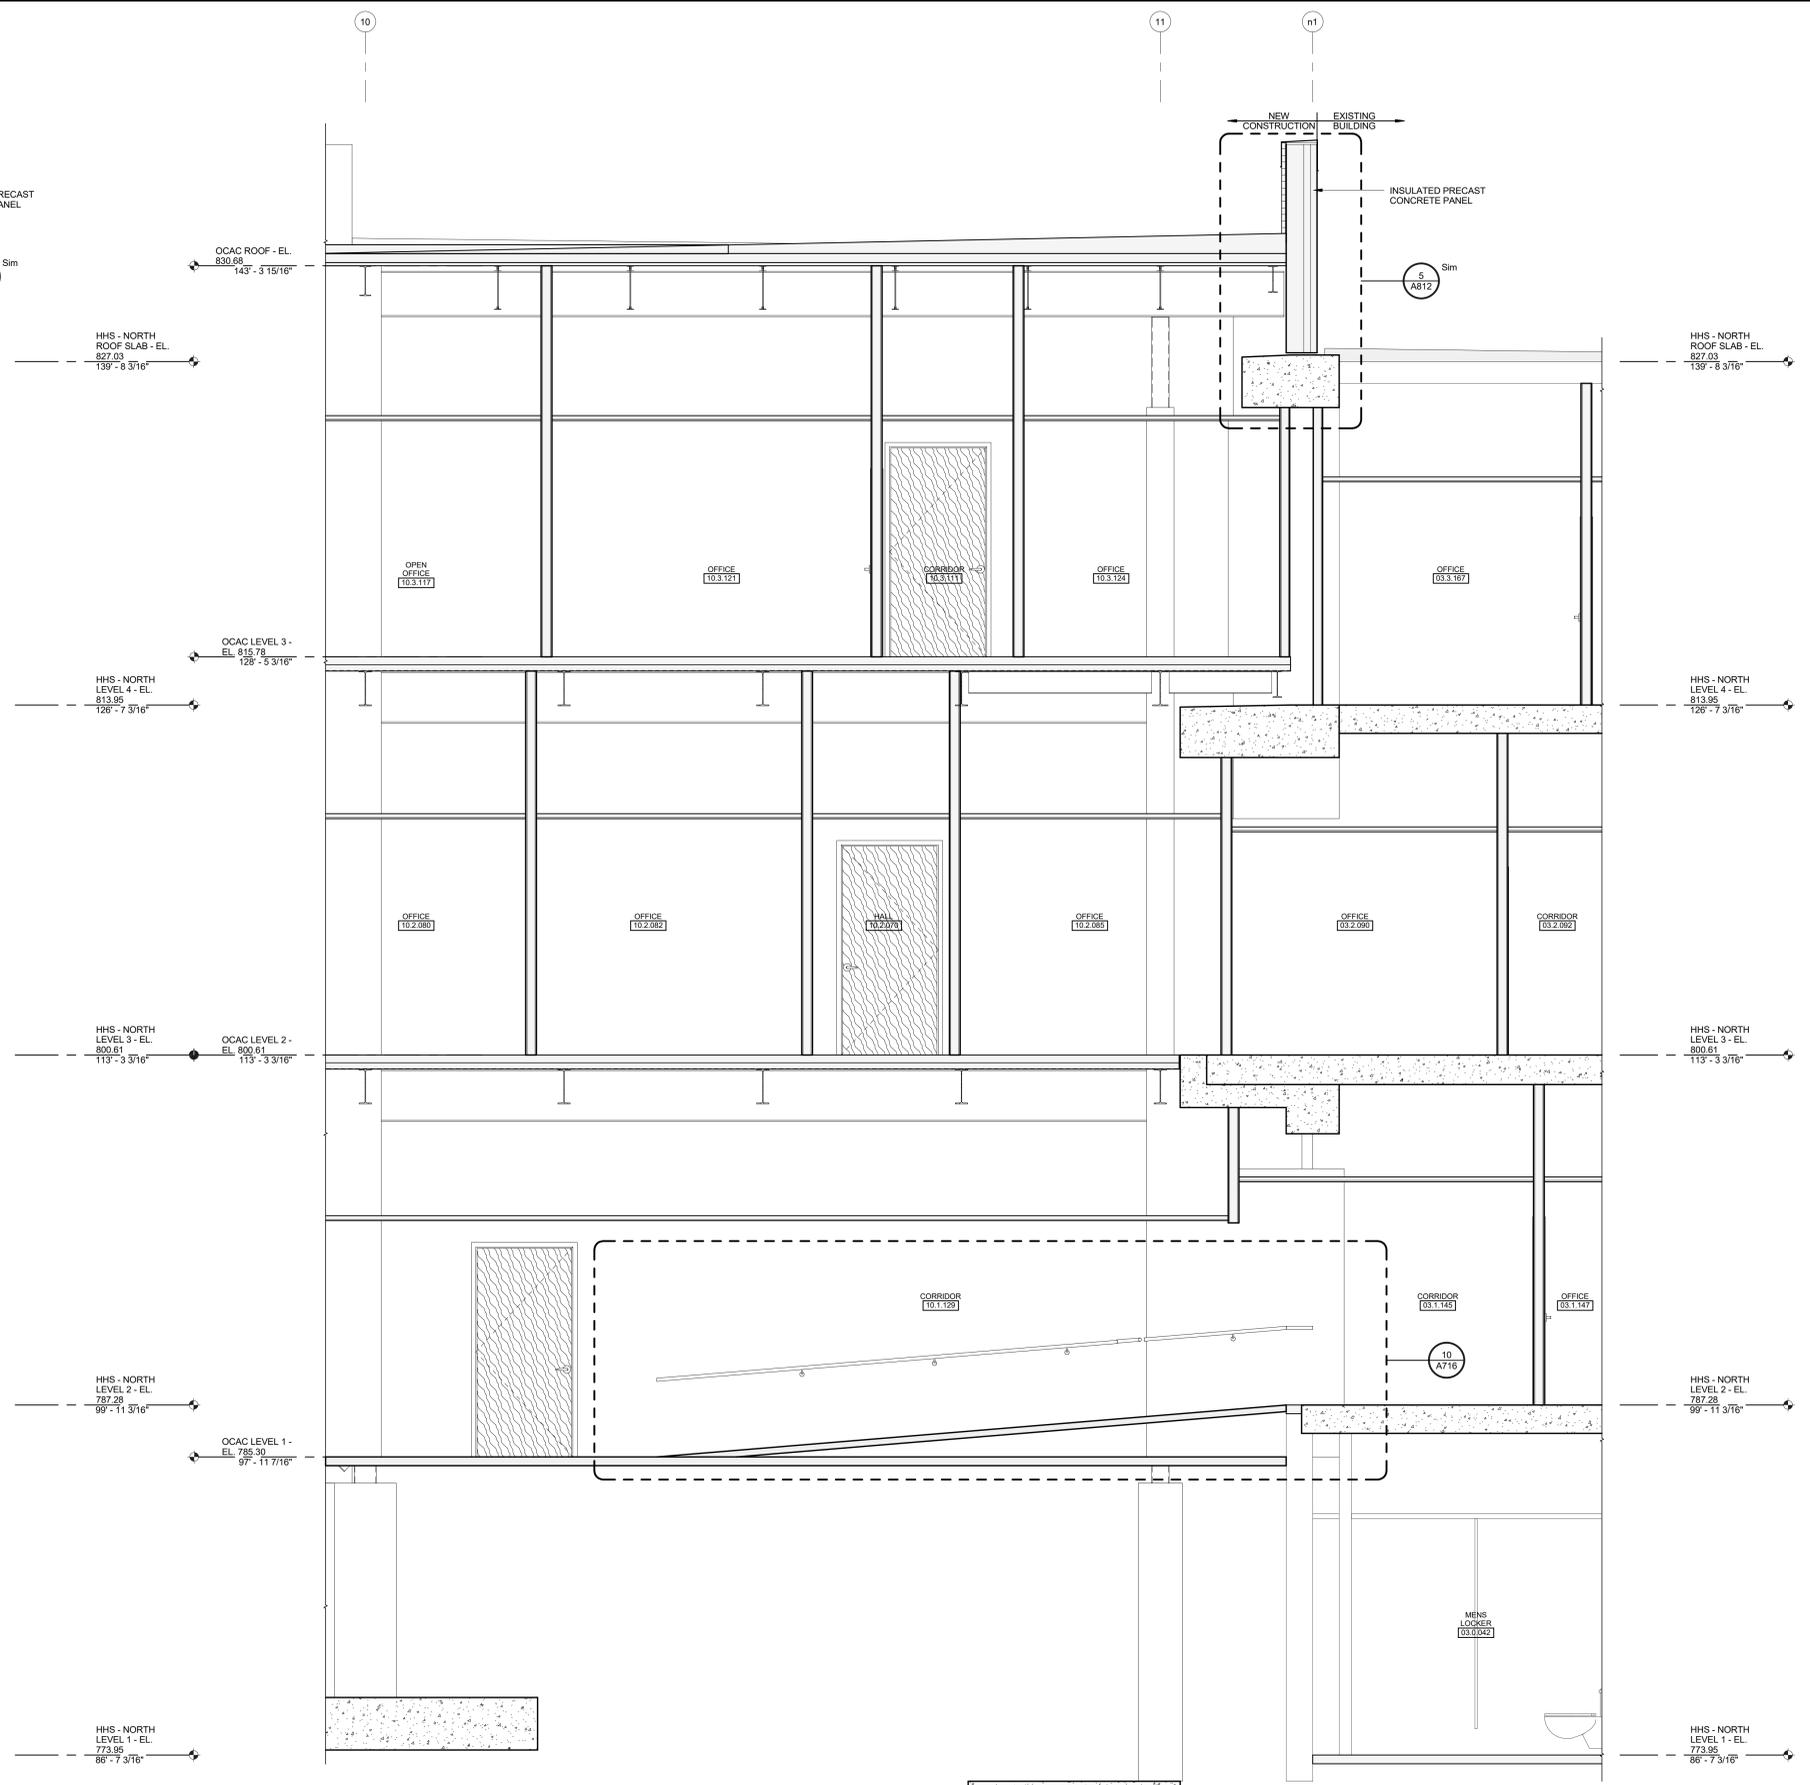


SECTION 2
A329 3/8" = 1'-0"

McMahon provides this drawing as a service to the client. It is not to be used for any other purpose without the written consent of McMahon. The client is responsible for the accuracy of the information provided by McMahon. The client is responsible for the accuracy of the information provided by McMahon. The client is responsible for the accuracy of the information provided by McMahon.

NO.	DATE	REVISION

ALTERATION / ADDITION
 OUTAGAME COUNTY ADMINISTRATION CENTER
 S. WALNUT & W. 8TH, APPLETON WI 54911
 SECTIONS

DESIGNED ASF	DRAWN BLG
PROJECT NO. 0002-61600160	
DATE MARCH 3, 2017	
SHEET NO.	

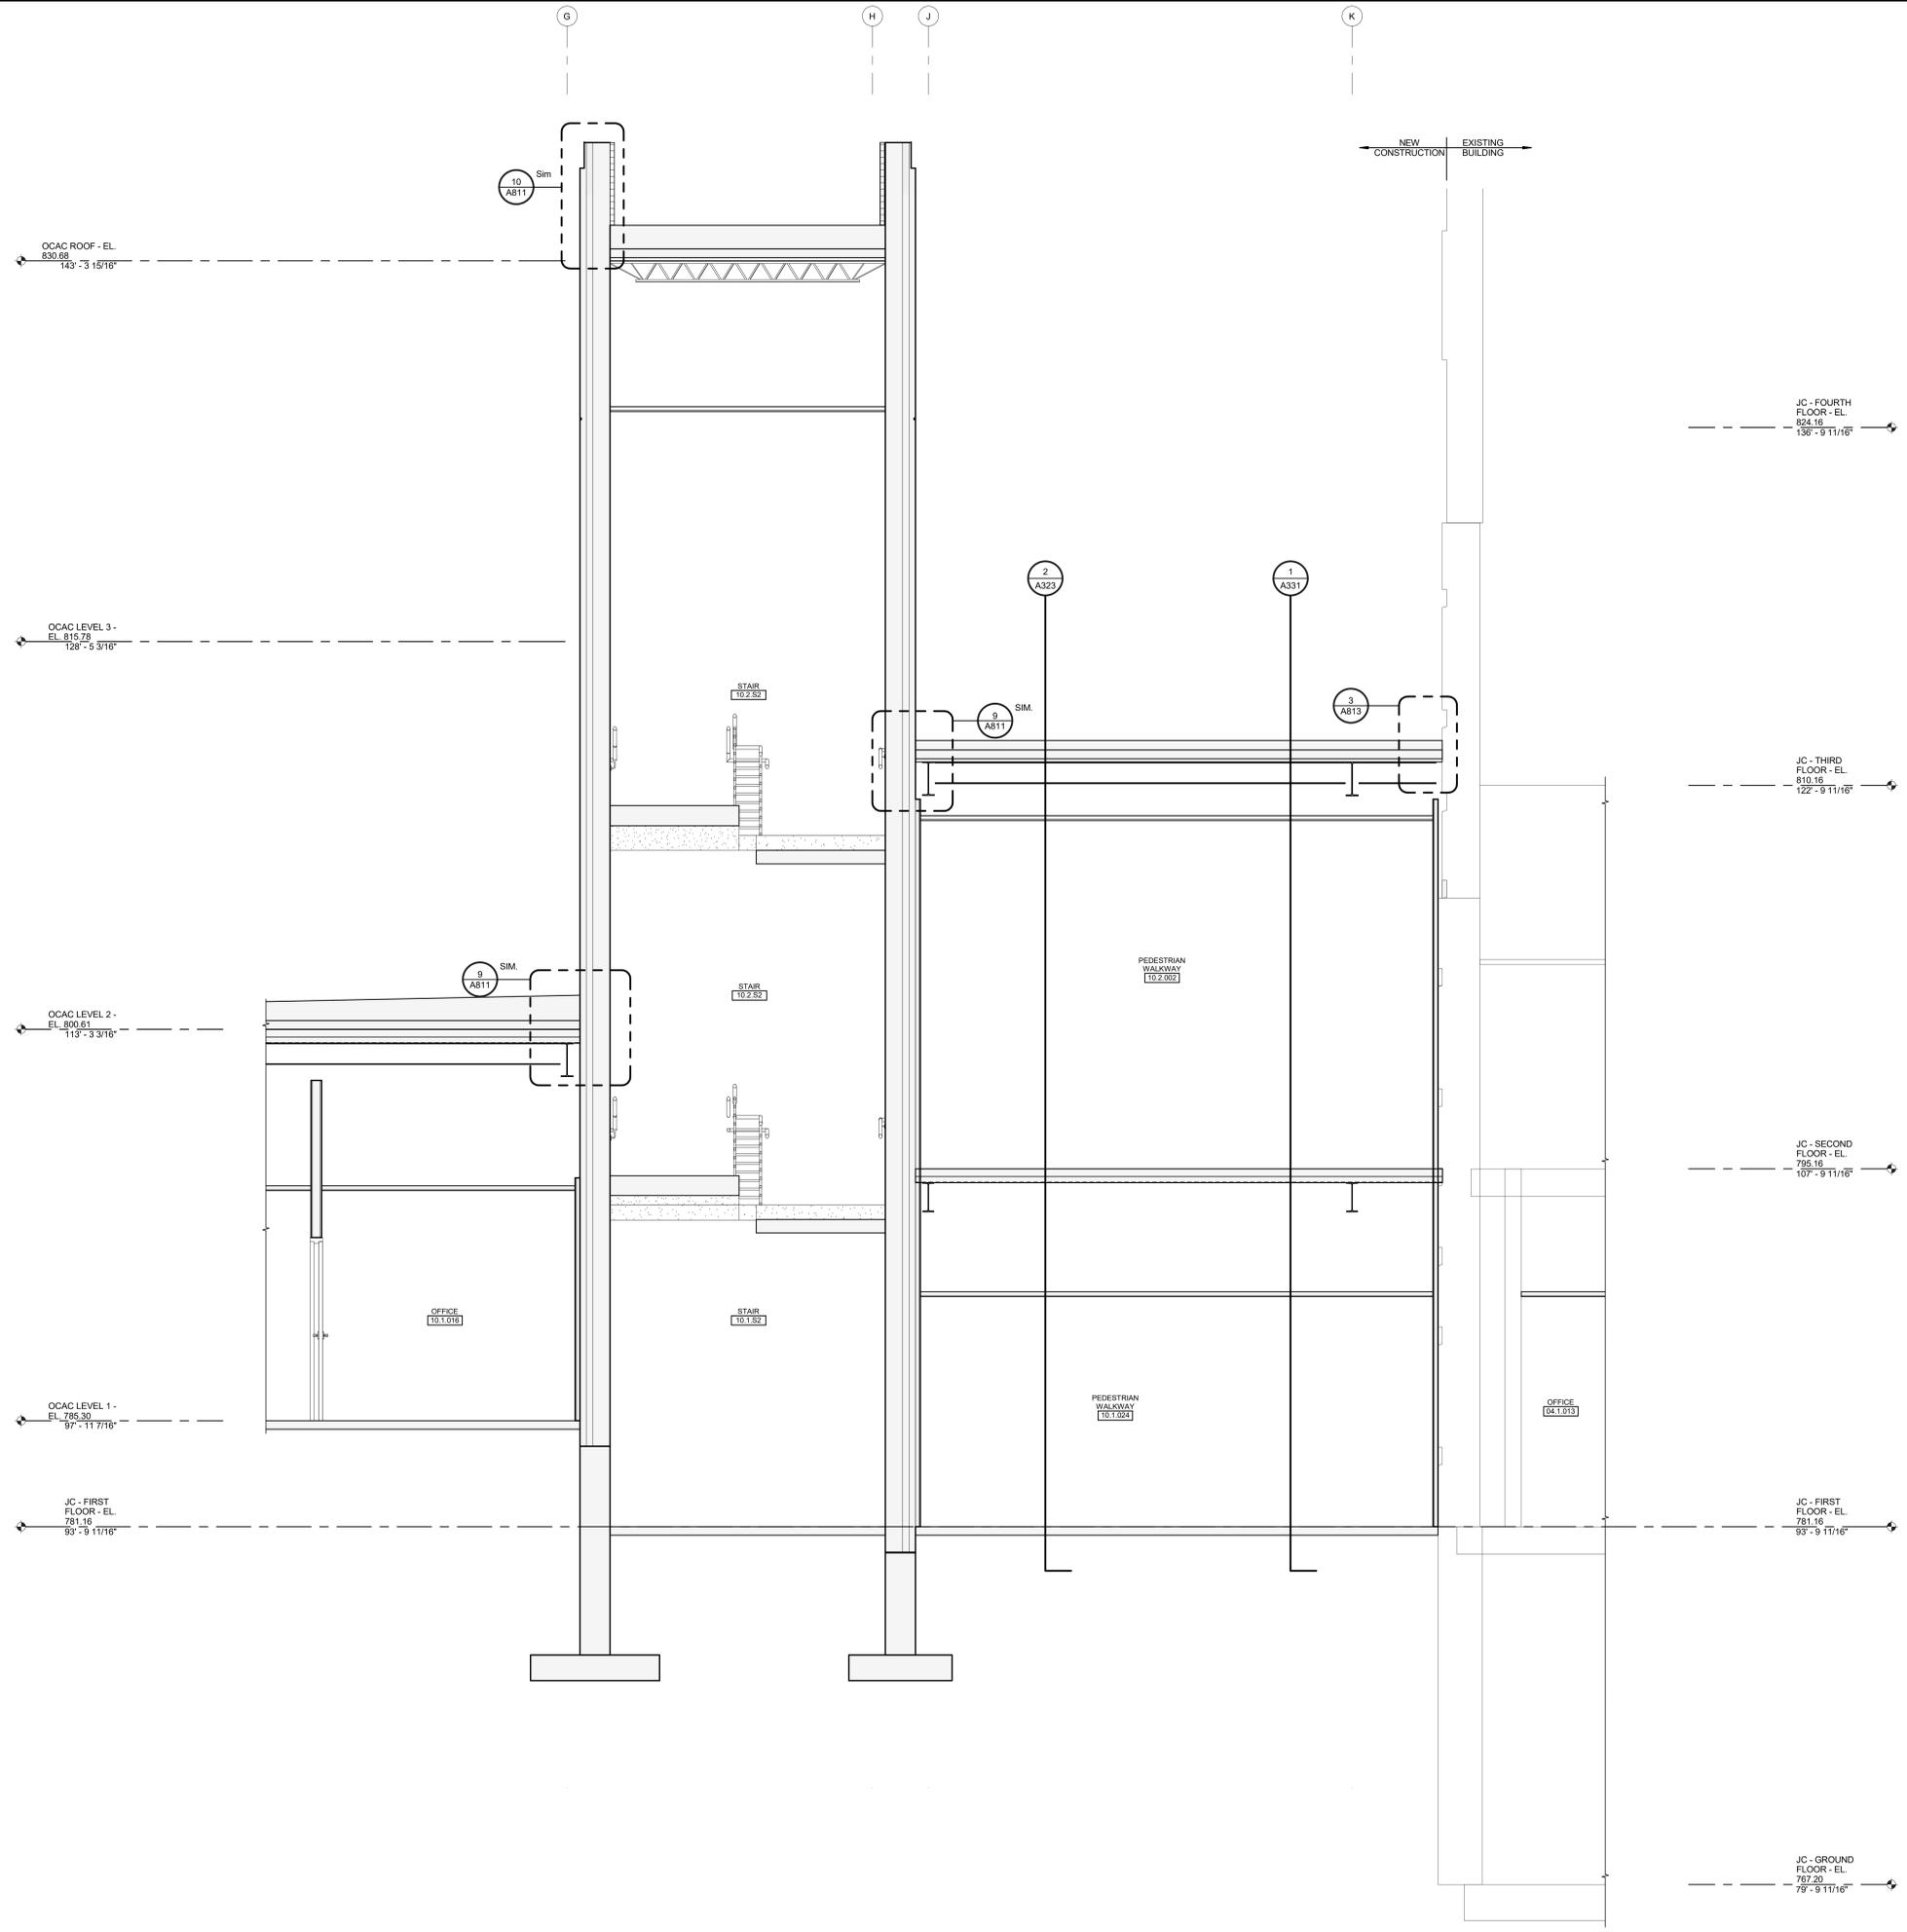


McMahon provides this drawing as a service to the client. It is not to be used for any other purpose without the written consent of McMahon. The client is responsible for the accuracy of the information provided by McMahon. The client is responsible for the accuracy of the information provided by McMahon. The client is responsible for the accuracy of the information provided by McMahon.

NO.	DATE	REVISION

ALTERATION / ADDITION
OUTAGAME COUNTY ADMINISTRATION CENTER
S. WALNUT & W. 8TH, APPLETON WI 54911
SECTIONS

DESIGNED	DRAWN
ASF	BLG
PROJECT NO. 0002-61600160	
DATE MARCH 3, 2017	
SHEET NO. A330	


SECTION
 1/A330 3/8" = 1'-0"

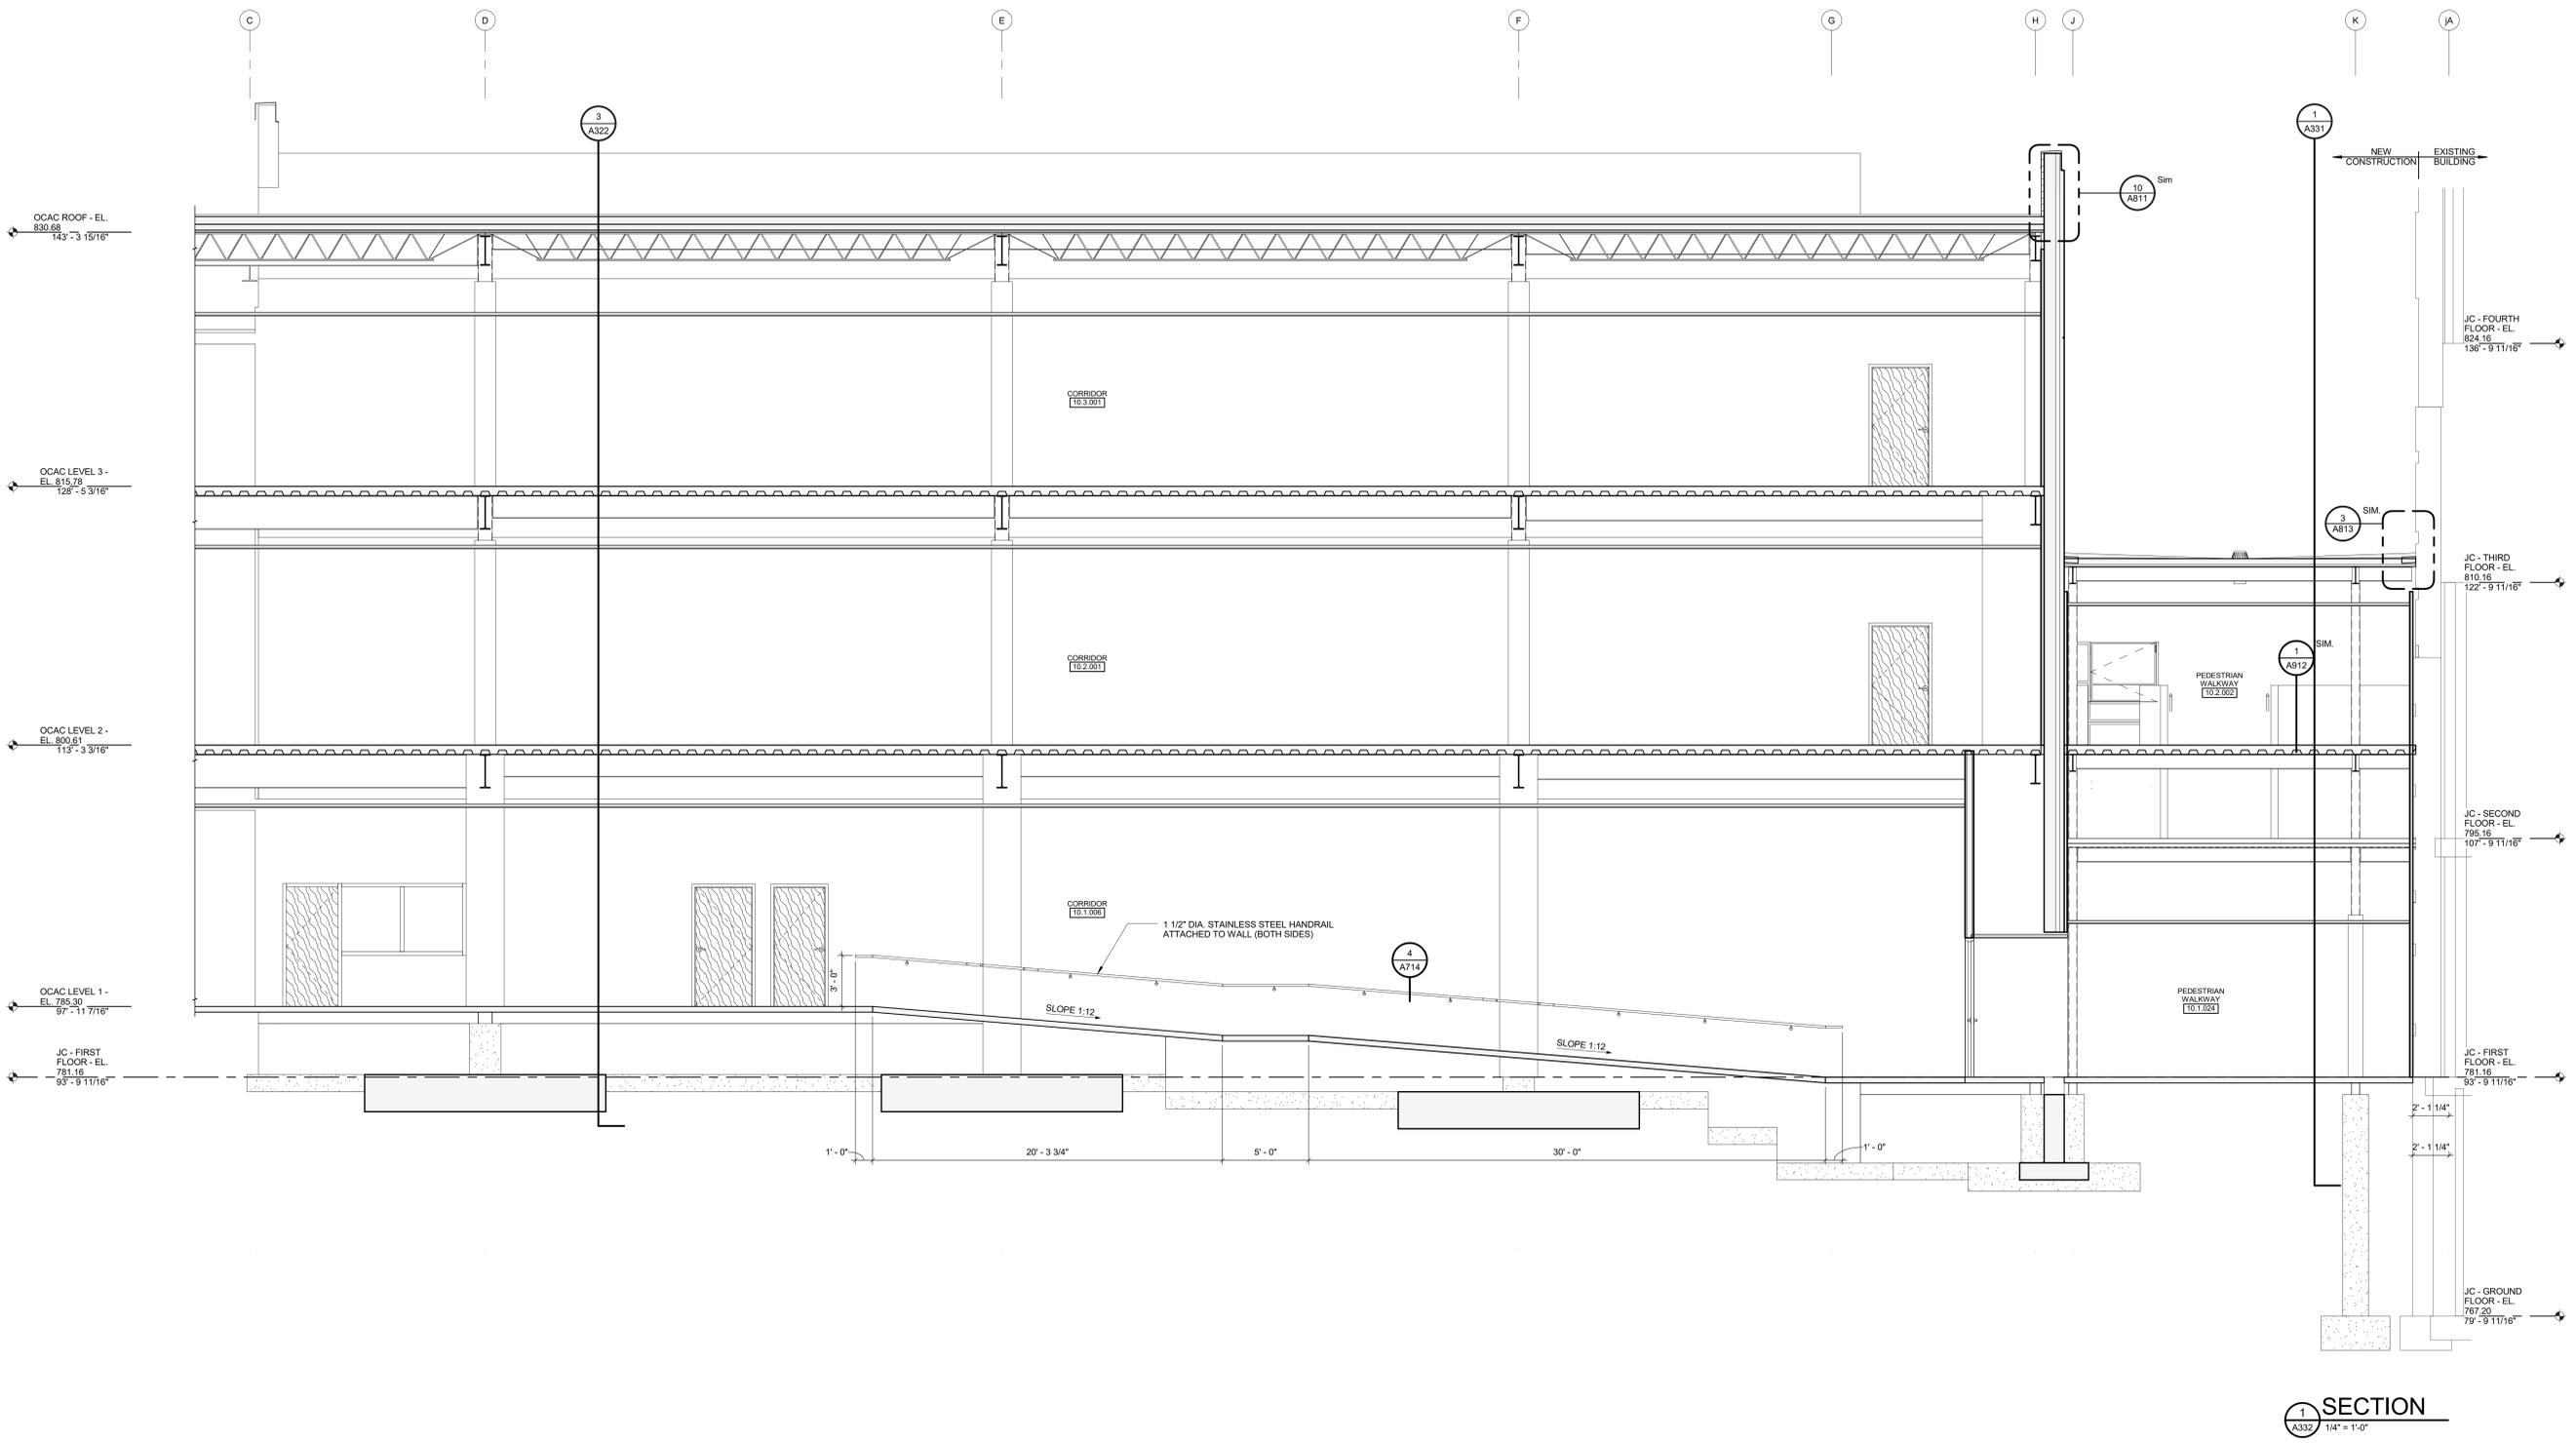

NO.	DATE	REVISION

ALTERATION / ADDITION
OUTAGAME COUNTY ADMINISTRATION CENTER
S. WALNUT & W. 8TH, APPLETON WI 54911
SECTIONS

DESIGNED	DRAWN
ASF	BLG
PROJECT NO. 0002-61600160	
DATE MARCH 3, 2017	
SHEET NO. A332	

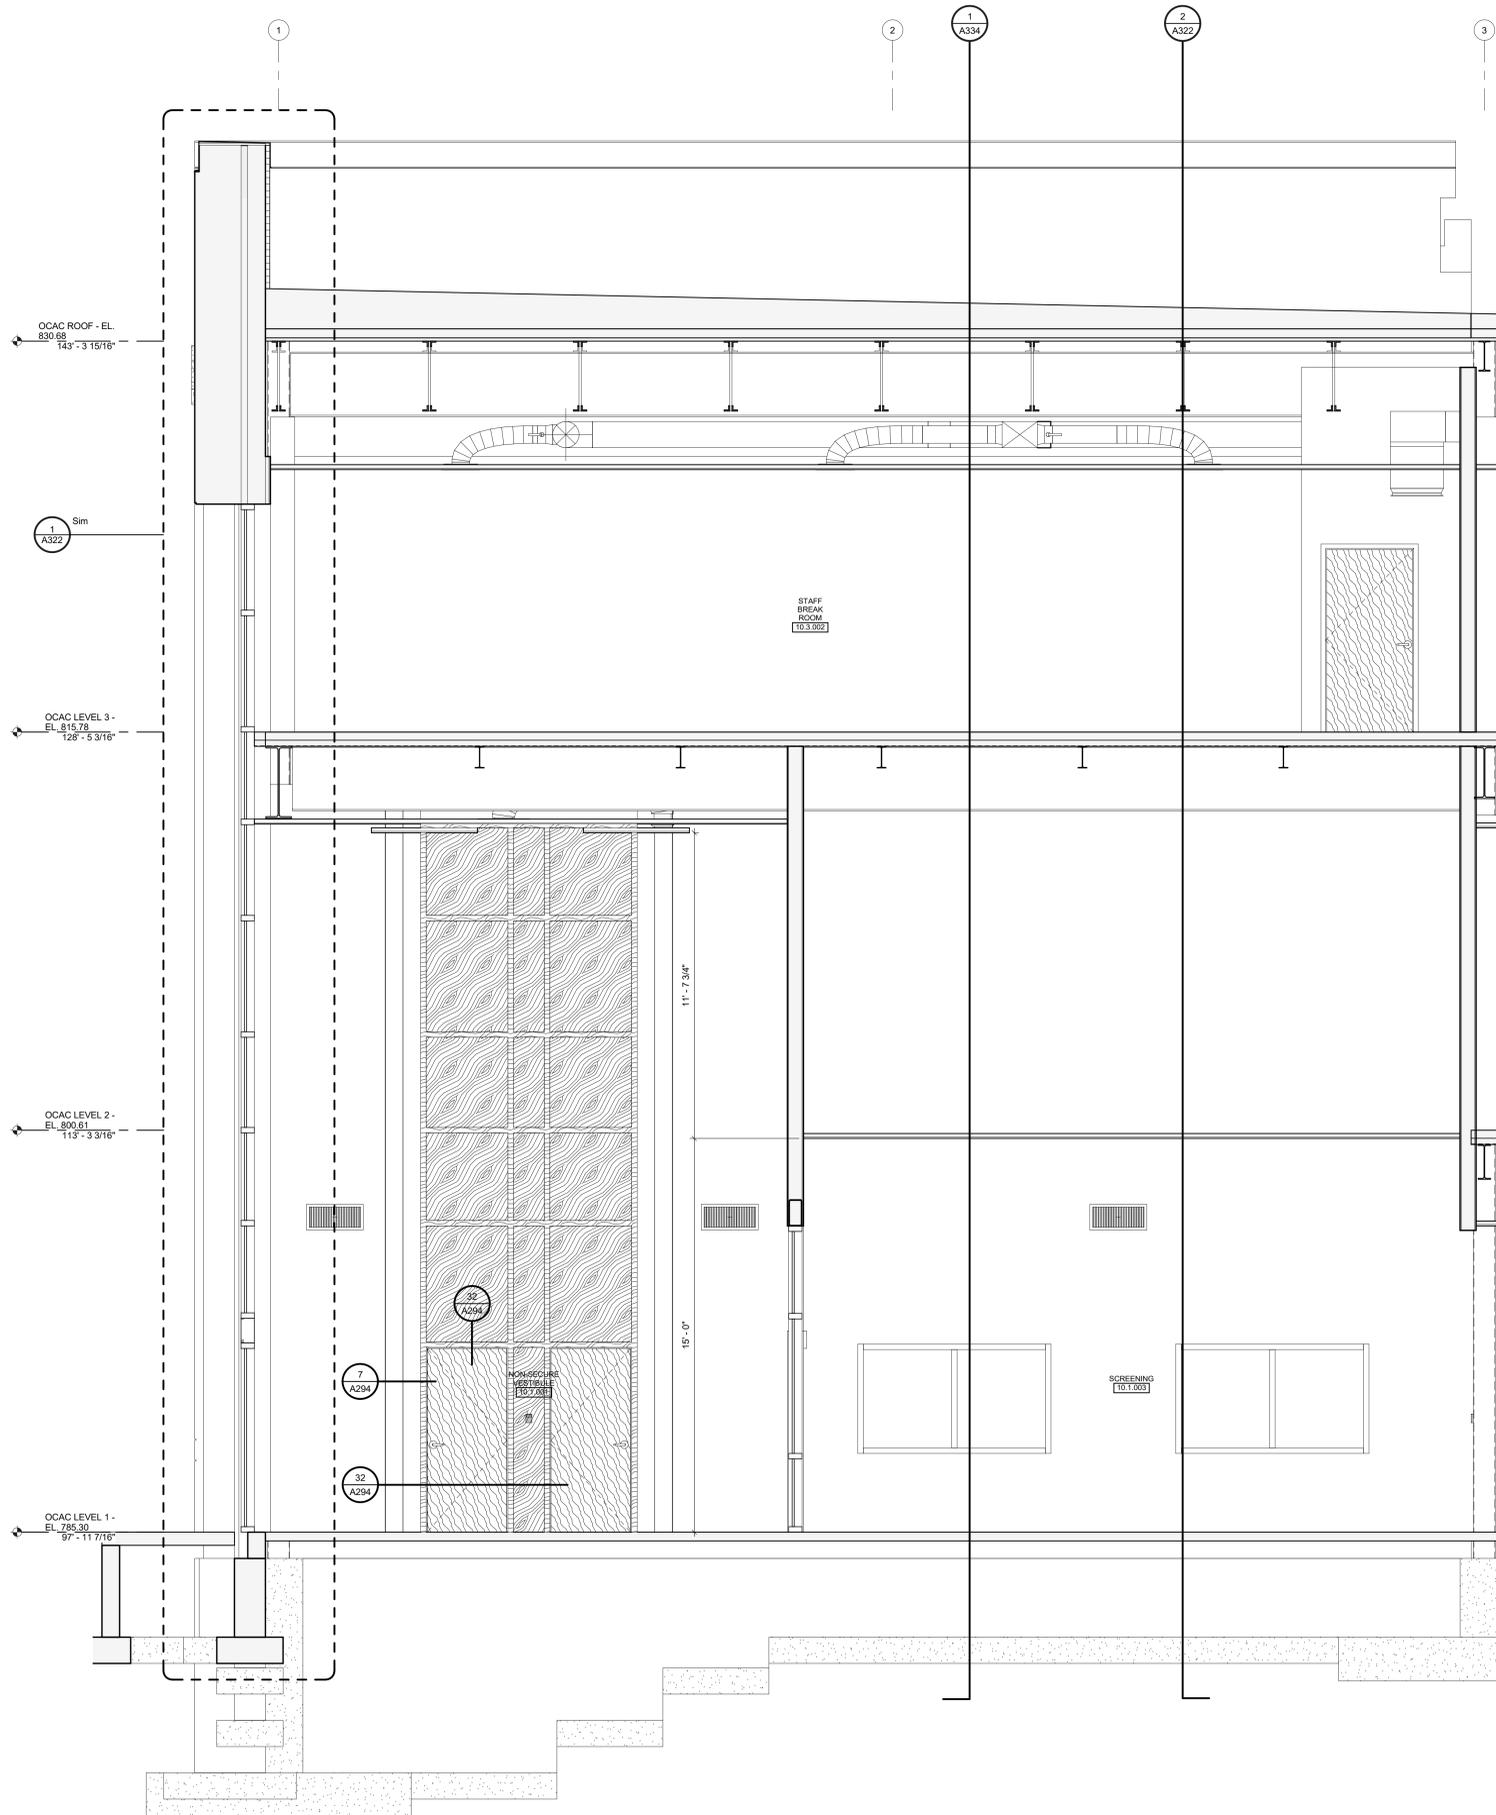


1 SECTION
A333 3/8" = 1'-0"

McMahon provides this drawing as a representation of service. All information is based on data provided by the client. The client is responsible for the accuracy of the information provided. McMahon is not responsible for any errors or omissions in this drawing. Any changes made to the original drawing must be in the original drawing.

NO.	DATE	REVISION

ALTERATION / ADDITION
 OUTAGAME COUNTY ADMINISTRATION CENTER
 S. WALNUT & W. 8TH, APPLETON WI 54911
 SECTIONS

DESIGNED ASF	DRAWN BLG
PROJECT NO. 0002-61600160	
DATE MARCH 3, 2017	
SHEET NO. A333	

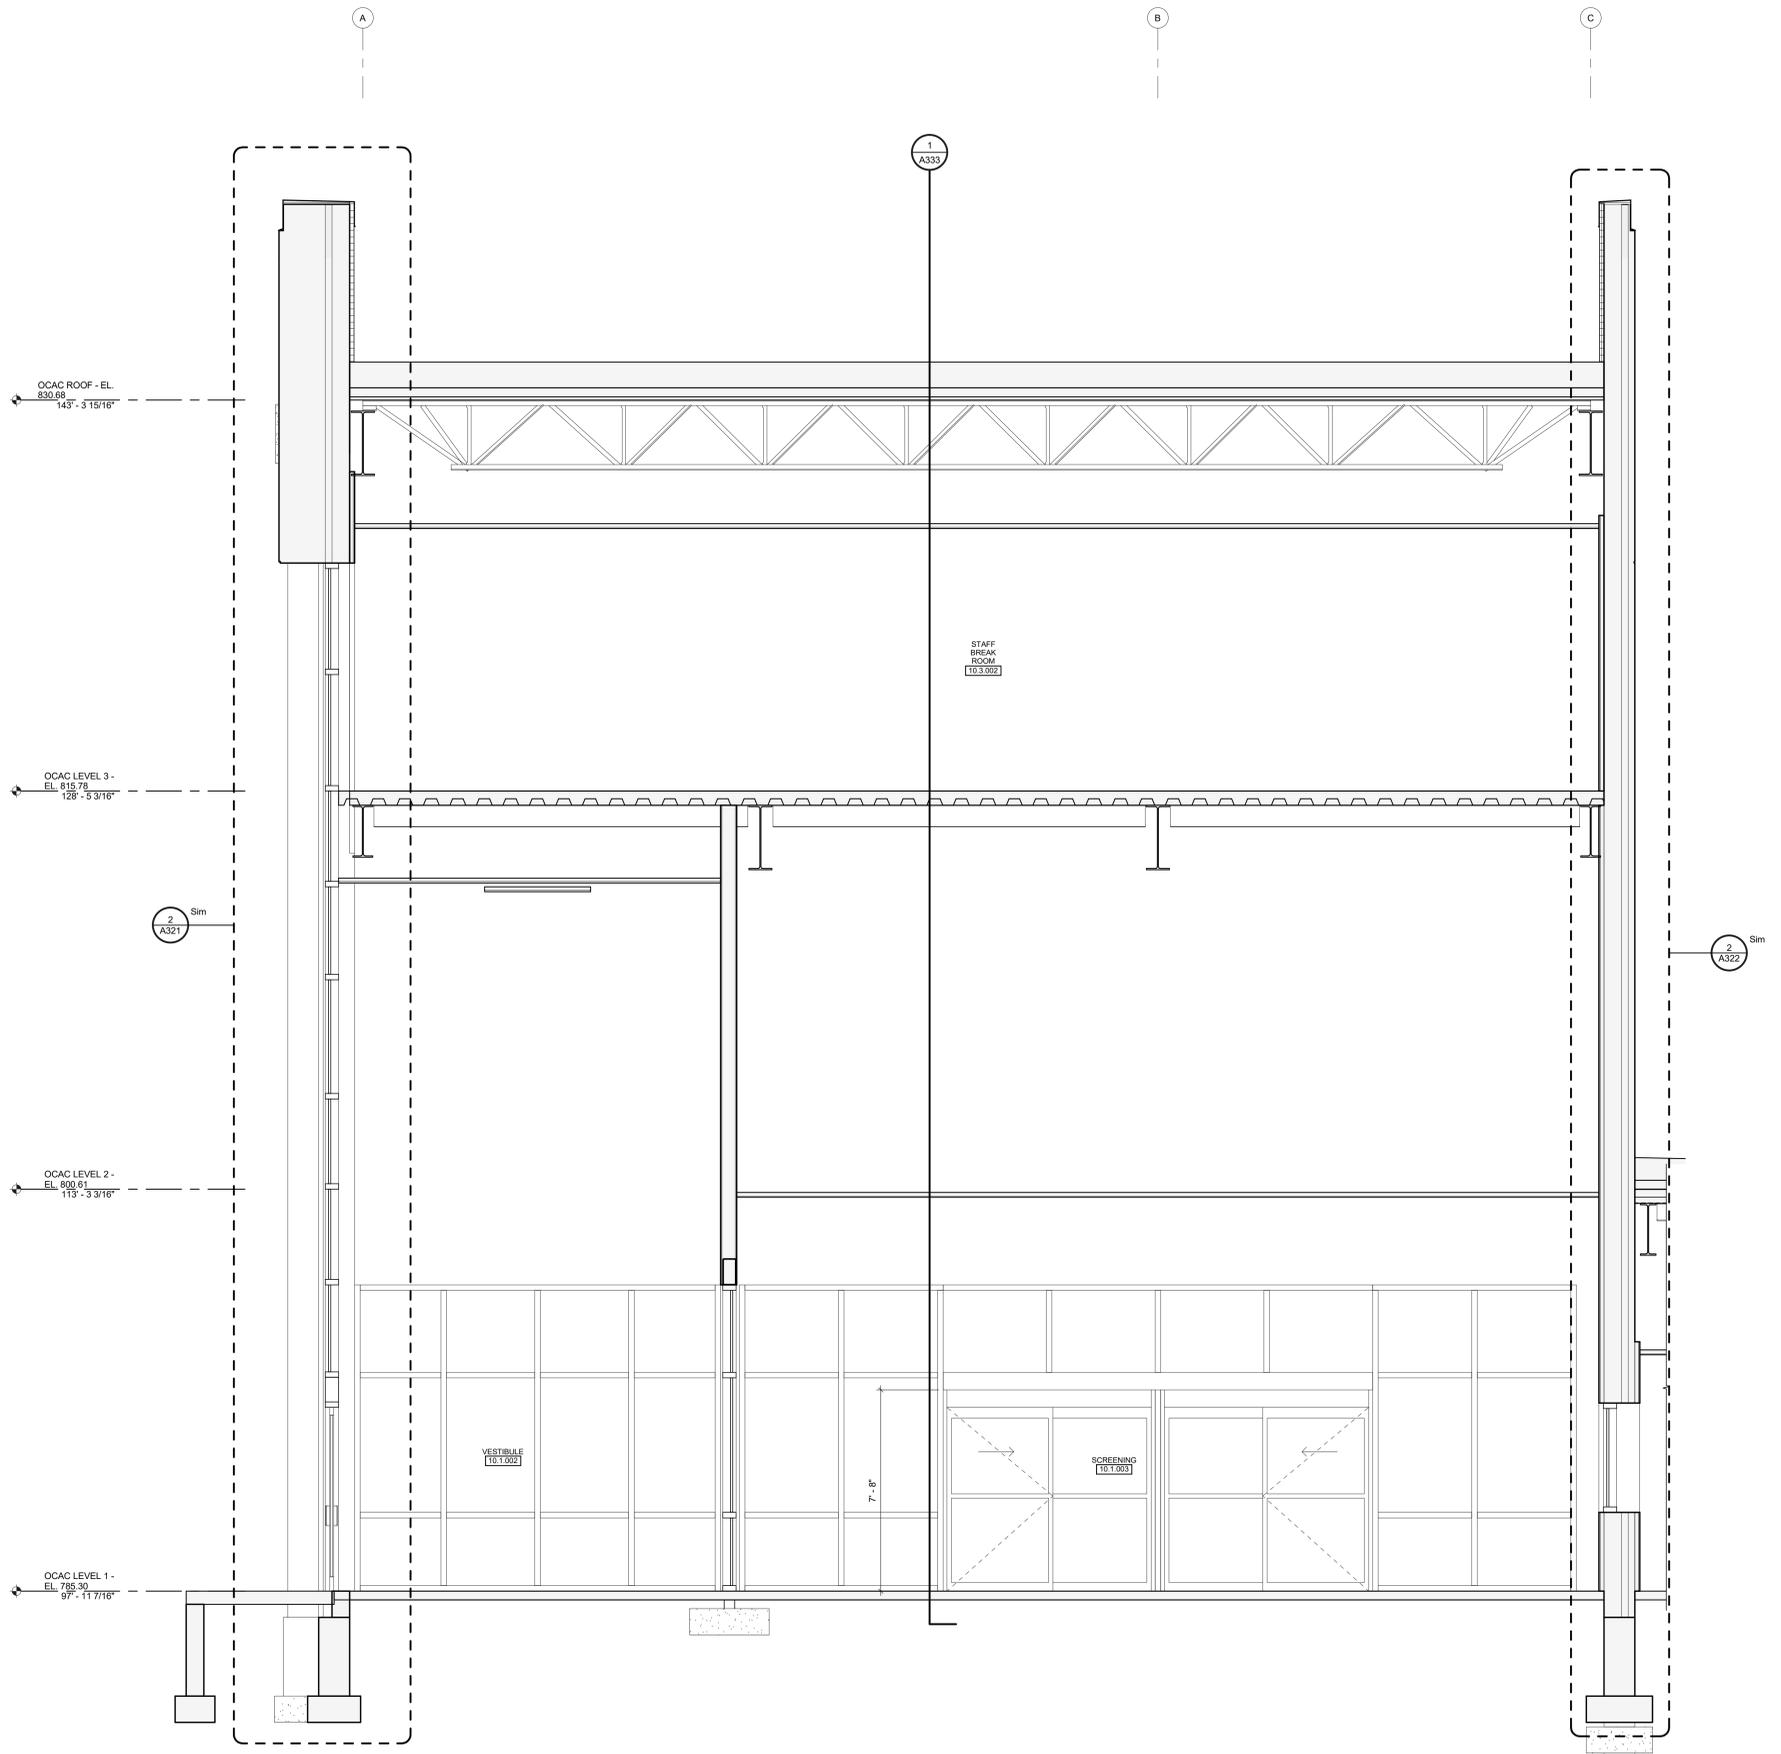


SECTION
 1
 A334 3/8" = 1'-0"

McMahon provides this drawing as a service to the client. It is not to be used for any other purpose without the written consent of McMahon. The client is responsible for obtaining all necessary permits and for verifying the accuracy of the information provided. McMahon is not responsible for any errors or omissions in this drawing.

NO.	DATE	REVISION

ALTERATION / ADDITION
OUTAGAME COUNTY ADMINISTRATION CENTER
S. WALNUT & W. 8TH, APPLETON WI 54911
SECTIONS

DESIGNED ASF	DRAWN BLG
PROJECT NO. 0002-61600160	
DATE MARCH 3, 2017	
SHEET NO.	

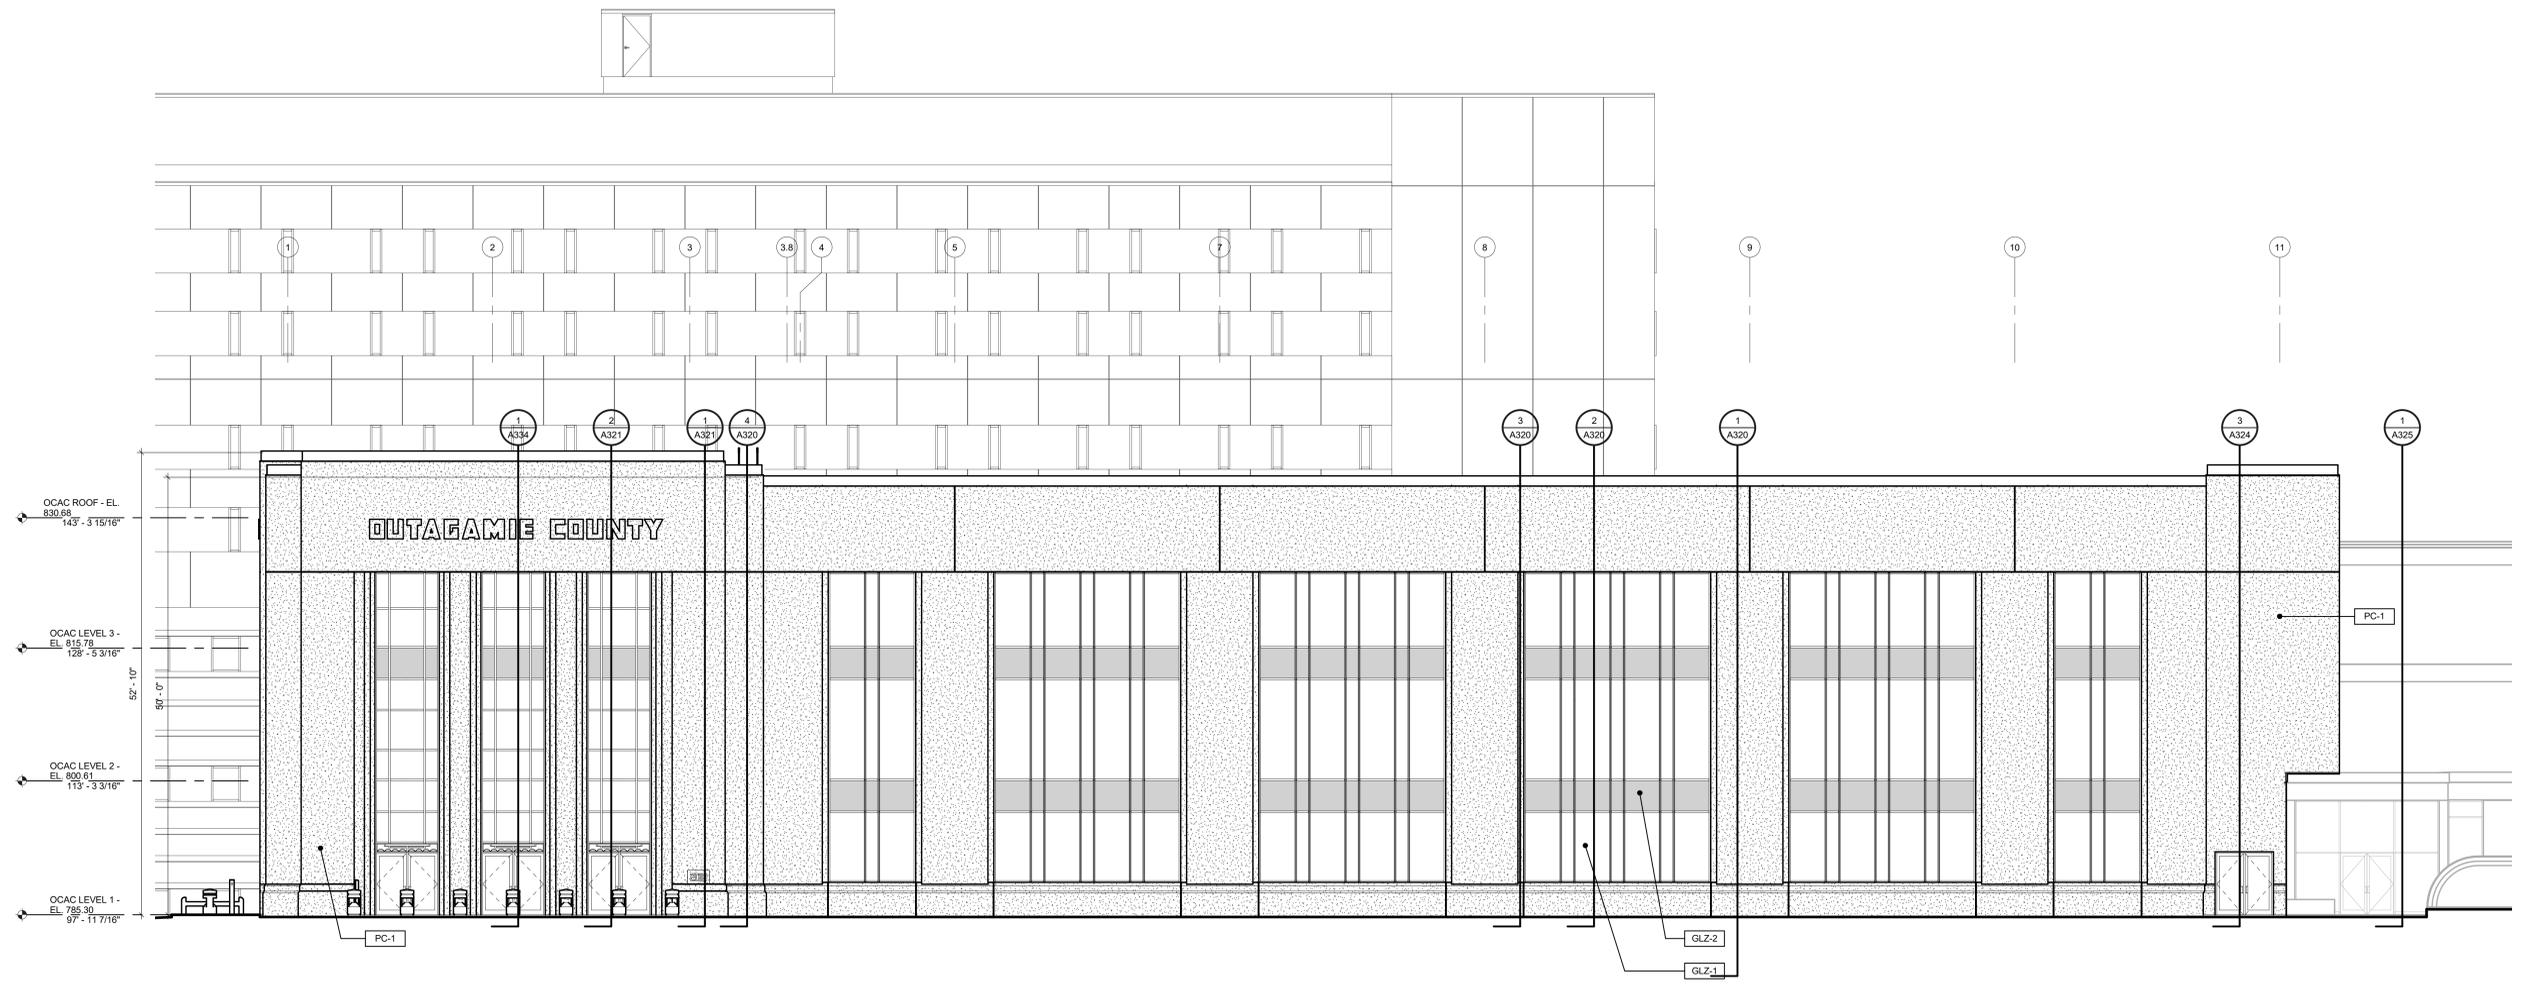

1 WEST ELEVATION
1/8\"/>


EXTERIOR MATERIALS LEGEND	
GLZ-1	GLASS
GLZ-2	GLASS SPANDREL
PC-1	PRECAST CONCRETE, SAND BLAST FINISH, COLOR TO MATCH COUNTY ADMINISTRATION BLDG.

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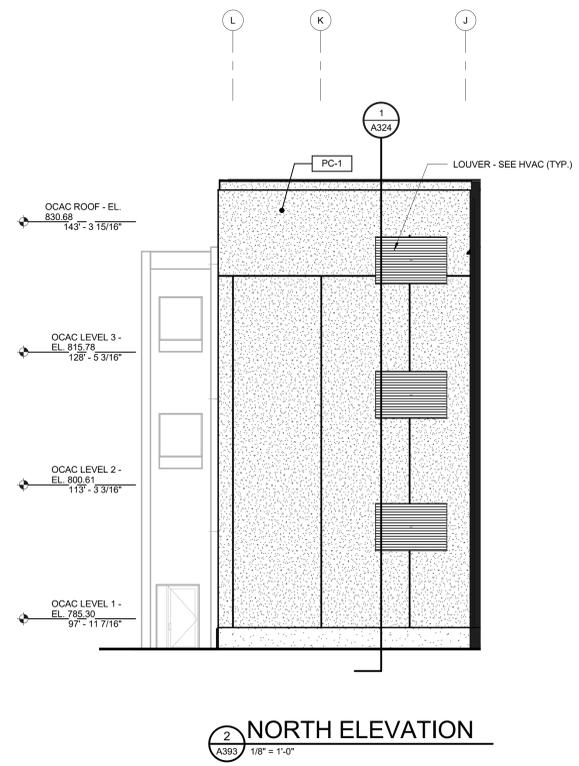
NO.	DATE	REVISION

ALTERATION / ADDITION
OUTAGAMIE COUNTY ADMINISTRATION CENTER
S. WALNUT & W. 8TH, APPLETON WI 54911
EXTERIOR ELEVATIONS


DESIGNED	DRAWN
ASF	BLG
PROJECT NO. 0002-61600160	
DATE MARCH 3, 2017	
SHEET NO. A391	

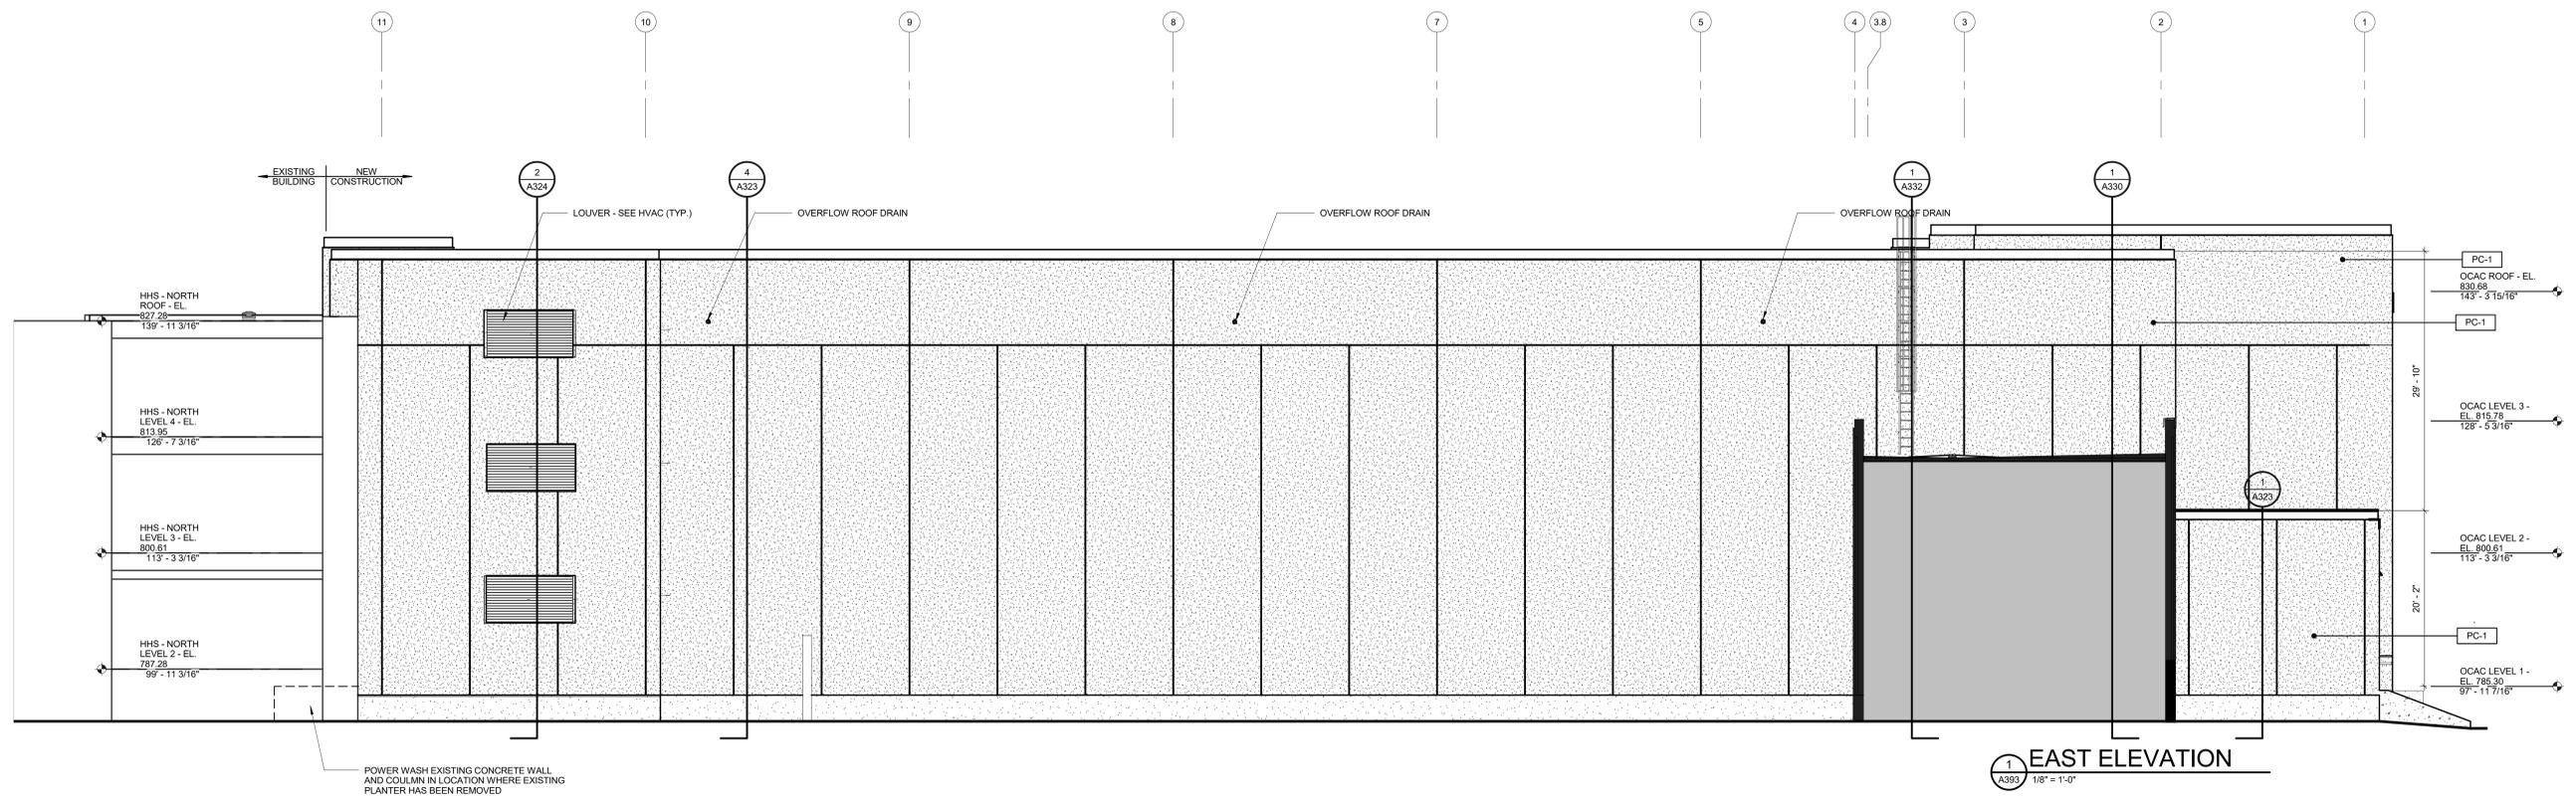

1 EAST ELEVATION
1/8" = 1'-0"



2 NORTH ELEVATION
1/8" = 1'-0"

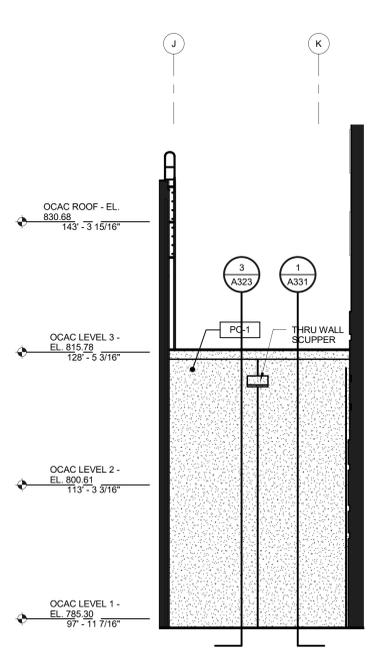

3 SOUTH ELEVATION
1/8" = 1'-0"


EXTERIOR MATERIALS LEGEND	
PC-1	PRECAST CONCRETE, SAND BLAST FINISH, COLOR TO MATCH COUNTY ADMINISTRATION BLDG.

McMahon provides this drawing as a representation of service. All information is to be used in accordance with the contract documents. The client is responsible for the accuracy of the information provided. McMahon is not responsible for any errors or omissions in this drawing. Changes made to the original drawing shall be noted in the revision block.

NO.	DATE	REVISION

ALTERATION / ADDITION
OUTAGAMIE COUNTY ADMINISTRATION CENTER
S. WALNUT & W. 8TH, APPLETON WI 54911
EXTERIOR ELEVATIONS

DESIGNED ASF/MAG	DRAWN BLG
PROJECT NO. 0002-61600160	
DATE MARCH 3, 2017	
SHEET NO.	

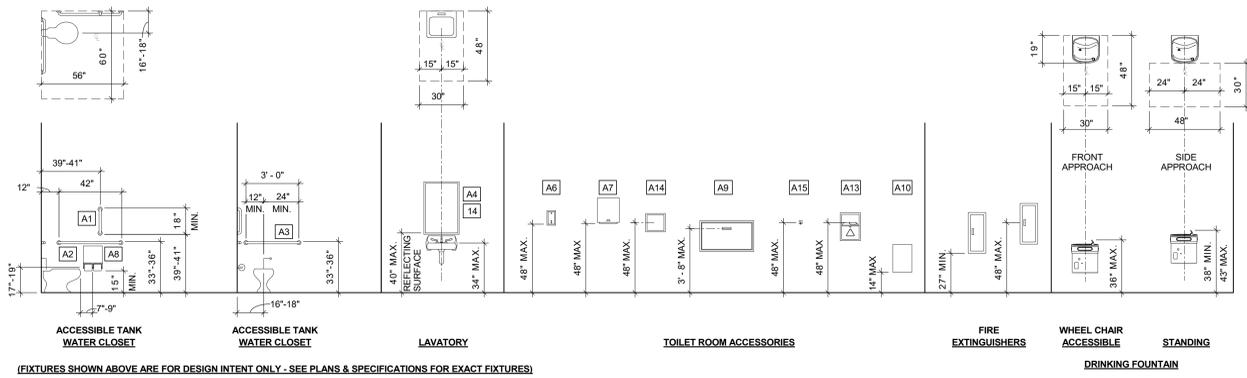

MARK	SIZE	DESCRIPTION
(A)	30"x48"	DRINKING FOUNTAIN (E.W.C.)
(B)	30"x48"	LAVATORY/SINK
(C)	30"x48"	URINAL
(D)	6"	TOE CLEARANCE AT OUTSIDE PERIMETER OF STALL
(E)	60"	TURNING RADIUS
(F)	56"x60"	WATER CLOSET
(G)	30"x48"	DENOTES CLEAR FLOOR AREA REQ'D WHEN DOOR SWINGS INTO REQ'D CLEAR FLOOR AREA AND/OR TURNING RADIUS.



MARK	DESCRIPTION	FURNISHED BY	INSTALLED BY	DESIGN BASIS
A1	GRAB BAR (18")	G.C.	G.C.	BRADLEY, MODEL 832
A2	GRAB BAR (42")	G.C.	G.C.	BRADLEY, MODEL 832
A3	GRAB BARS (36")	G.C.	G.C.	BRADLEY, MODEL 832
A4	MIRROR	G.C.	G.C.	BRADLEY, MODEL 7481 SERIES
A5	WASTE RECEPTACLE - SURFACE MOUNTED	G.C.	G.C.	BRADLEY, MODEL 396
A6	SOAP DISPENSER	OWNER	G.C.	GOJO, MODEL ADX-7
A7	PAPER TOWEL DISPENSER	OWNER	G.C.	GP EMOTION, MODEL 59462
A8	TOILET TISSUE DISPENSER	G.C.	G.C.	GP COMPACT, MODEL 56790
A9	BABY CHANGING STATION	G.C.	G.C.	DIAPER DECK & CO, MODEL: DIAPER DECK
A10	CHILD PROTECTION SEAT	G.C.	G.C.	DIAPER DECK & CO, MODEL: FLL-HOLD-THE-BABY
A11	NAPKIN VENDOR - SURFACE MOUNTED	G.C.	G.C.	BRADLEY, MODEL 4017-11
A12	NAPKIN DISPOSAL - SURFACE MOUNTED	G.C.	G.C.	BRADLEY, MODEL 4761-15
A14	SPECIMEN PASS-THRU CABINET	G.C.	G.C.	BRADLEY, MODEL 9813
A15	COAT HOOK	G.C.	G.C.	BRADLEY, MODEL 9114 BRADEX
A16	SHARPS CONTAINER	OWNER	G.C.	MARKETLAB INC., MODEL MK48516
A17	SHELF	OWNER	G.C.	BRADLEY, MODEL 758 SERIES

- ### GENERAL PLAN NOTES
- SEE SHEET A002 FOR WALL TYPE DESCRIPTIONS.
 - ALL NEW STUD PARTITIONS SHALL BE TYPE 0B UNLESS NOTED OTHERWISE.
 - VERIFY EXISTING DIMENSIONS, CONDITIONS, AND FINISHES BEFORE PROCEEDING WITH WORK. DO NOT SCALE FROM DRAWINGS. BRING ANY DISCREPANCIES TO THE ARCHITECTS ATTENTION IMMEDIATELY.
 - COORDINATE LOCATIONS AND QUANTITY OF WORK WITH MECHANICAL, ELECTRICAL, AND PLUMBING CONTRACTORS.
 - ALL DIMENSIONS ARE CLEAR FROM CENTERLINE OF WALL/PARTITION TO CENTERLINE OF WALL/PARTITION OR FACE OF EXISTING WALLS ACTUAL FACE.
 - ALL PIPING, CONDUIT AND RELATED MECHANICAL AND ELECTRICAL ITEMS SHALL BE CONCEALED WITHIN GYPSUM BOARD FURRING AS REQUIRED IN FINISHED AREAS WHETHER SHOWN ON DRAWINGS OR NOT, UNLESS NOTED OTHERWISE.
 - PROVIDE METAL PLATE BACKING AND/OR TREATED WOOD BLOCKING IN WALLS WHERE WALL-MOUNTED EQUIPMENT IS SHOWN ON PLANS OR ELEVATIONS. VERIFY HEIGHT AND LENGTH WITH ACTUAL EQUIPMENT.
 - MATCH FINISHED WALL OR PARTITION THICKNESS WHERE NEW WALLS OR PARTITIONS OCCUR IN LINE WITH EXISTING WALL FINISHES, REGARDLESS OF PARTITION TAG.
 - PROVIDE DUST CONTROL BETWEEN CONSTRUCTION AREAS AND OCCUPIED AREAS AT ALL TIMES.
 - PATCH LEVEL AND PREP ALL EXISTING WALLS AND COLUMNS SCHEDULED TO RECEIVE WALL FINISHES.
 - FILL LEVEL AND ALIGN EXISTING FLOORS AS REQUIRED TO RECEIVE NEW FLOOR FINISHES.
 - REMOVE ALL DEMOLITION AND CONSTRUCTION DEBRIS FROM THE CONSTRUCTION SITE DAILY AND PLACE IN THE APPROPRIATE REUSE OR RECYCLING CONTAINERS. WORK AREA SHALL BE KEPT CLEAN AND FREE OF DUST, DIRT, AND DEBRIS.
 - SEE CODE PLAN AND SUMMARY SHEETS FOR LIFE SAFETY PLANS AND FIRE PARTITION RATINGS.
 - COORDINATE WALL BACKING LOCATIONS FOR SYSTEMS FURNITURE w/ OWNER'S FURNITURE VENDOR.
- ### GENERAL RESTROOM NOTES
- PROVIDE TOILET ACCESSORIES TO MATCH EXISTING OR APPROVED EQUAL. INSTALL ACCORDING TO MANUF. SPECIFICATIONS.
 - ALL BLOCKING REQUIRED FOR SUPPORT OF GRAB BARS AND TOILET ROOM ACCESSORIES SHALL BE PROVIDED BY GENERAL CONTRACTOR.
 - SEE ELEVATIONS FOR TYPICAL FIXTURE AND ACCESSORY MOUNTING HEIGHTS.
 - FIELD VERIFY ALL DIMENSIONS PRIOR TO CASEWORK CONSTRUCTIONS.
 - PROVIDE OFFSET TRAP AND HW. CW. DRAIN INSULATION KIT AT ALL OPEN SINKS.



McMAHON
ENGINEERS ARCHITECTS
1000 W. WALTON ST. SUITE 100
MILWAUKEE, WI 53233
Tel: (920) 751-4200 Fax: (920) 751-4284
www.mcmahon.com

ACCESSORY / FIXTURE MOUNTING HEIGHTS & CLEARANCES

SCALE: 1/4" = 1'-0"

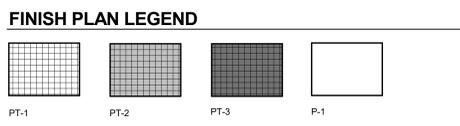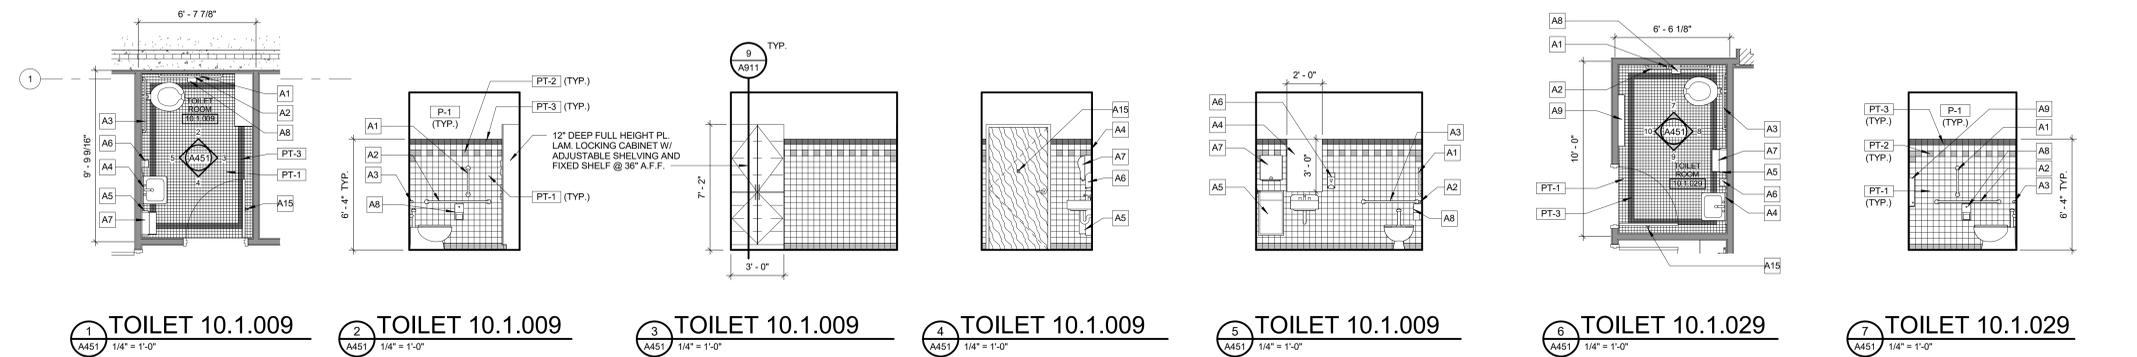


- ### ROOM FINISH ABBREVIATIONS
- FLOORS**
- PT PORCELAIN TILE: SEE ENLARGED RESTROOM FLOOR PLANS FOR SPECIFIC LOCATIONS OF THE BELOW:
- PT-1 PORCELAIN TILE: FACTORY MOUNTED GLAZED CERAMIC TILE. COLOR: MATCH EXISTING.
- PT-3 PORCELAIN TILE: FACTORY MOUNTED GLAZED CERAMIC TILE. COLOR: MATCH EXISTING.
- WALLS**
- P-1 PAINT: PITTSBURGH PAINTS: SPEEDHIDE INTERIOR FLAT LATEX. COLOR: WHITE ROCK 511-2
- PT PORCELAIN TILE: SEE INTERIOR ELEVATIONS FOR SPECIFIC LOCATIONS OF THE TILE BELOW:
- PT-1 PORCELAIN TILE: FACTORY MOUNTED GLAZED CERAMIC TILE. COLOR: MATCH EXISTING.
- PT-2 PORCELAIN TILE: FACTORY MOUNTED GLAZED CERAMIC TILE. COLOR: MATCH EXISTING.
- PT-3 PORCELAIN TILE: FACTORY MOUNTED GLAZED CERAMIC TILE. COLOR: MATCH EXISTING.

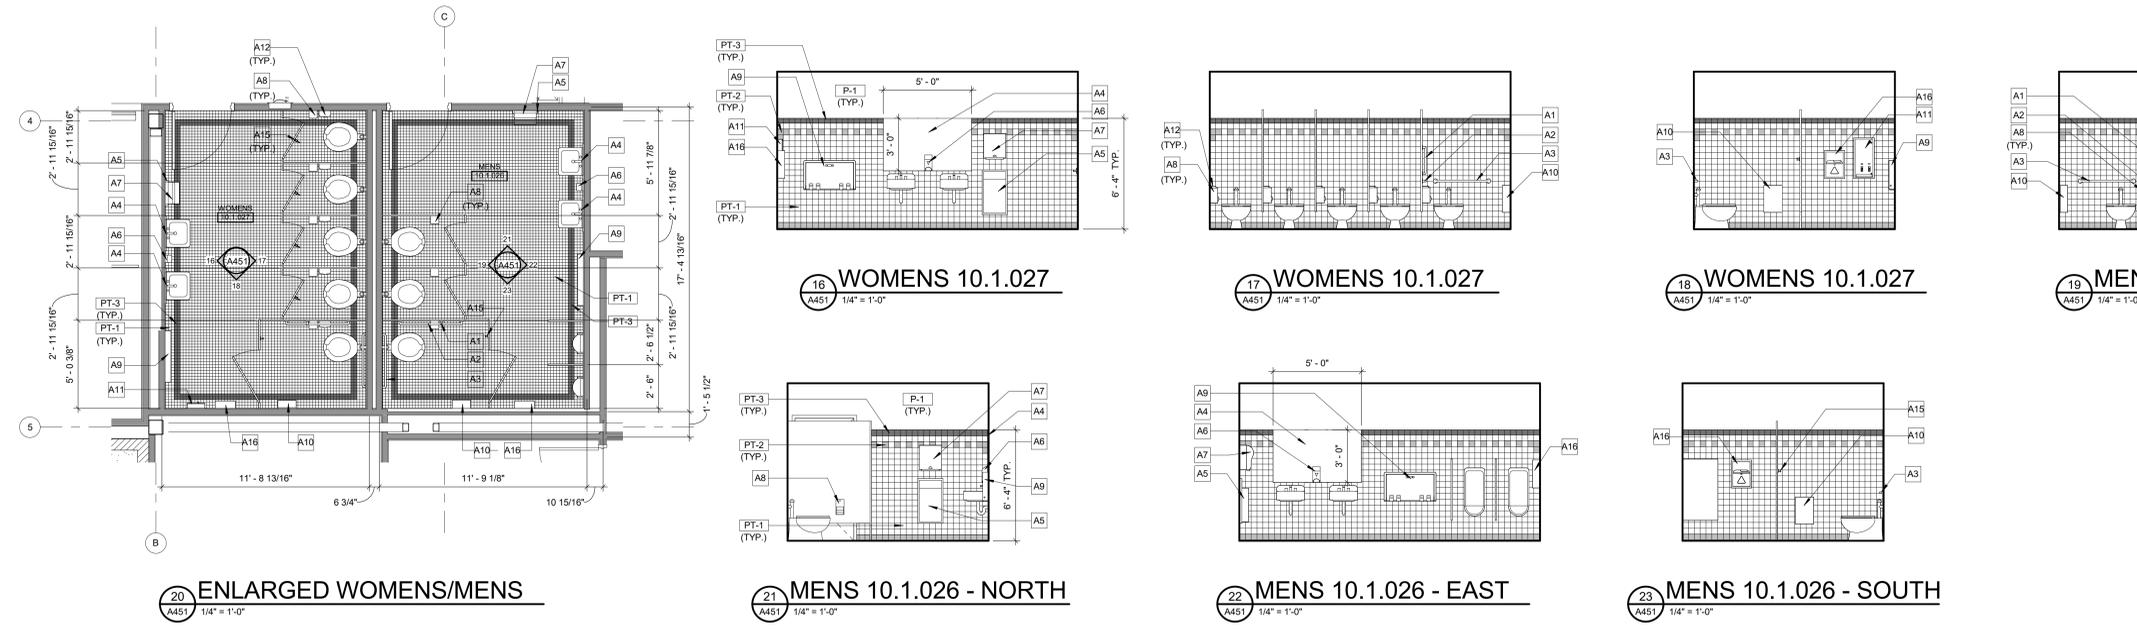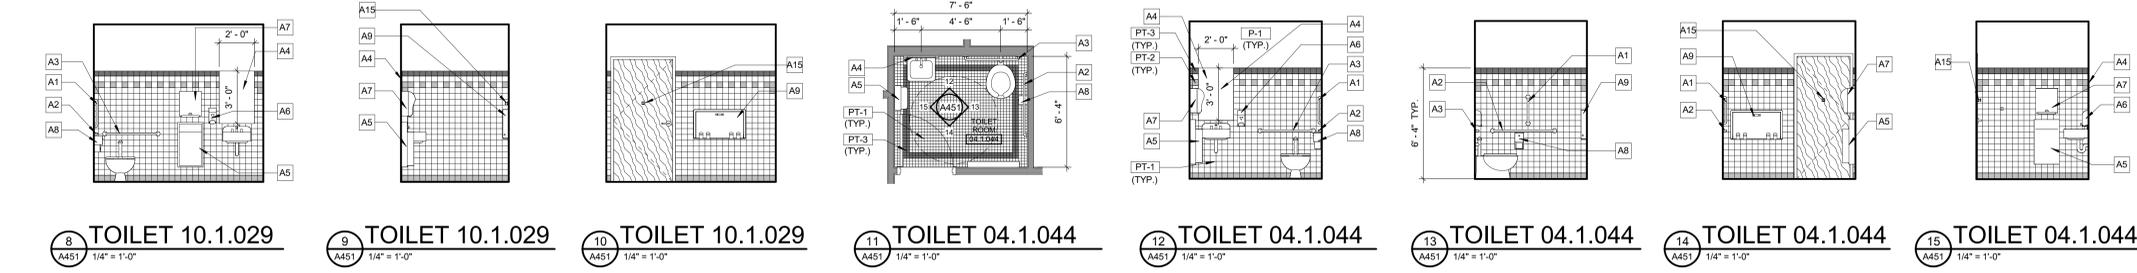

ALTERATION / ADDITION
OUTAGAME COUNTY ADMINISTRATION CENTER
S. WALNUT & W. 8TH, APPLETON WI 54911
ENLARGED RESTROOM PLANS AND INTERIOR ELEVATIONS

DESIGNED	DRAWN
ASF/MAG	BLG
PROJECT NO. 0002-61600160	
DATE MARCH 3, 2017	
SHEET NO. A451	

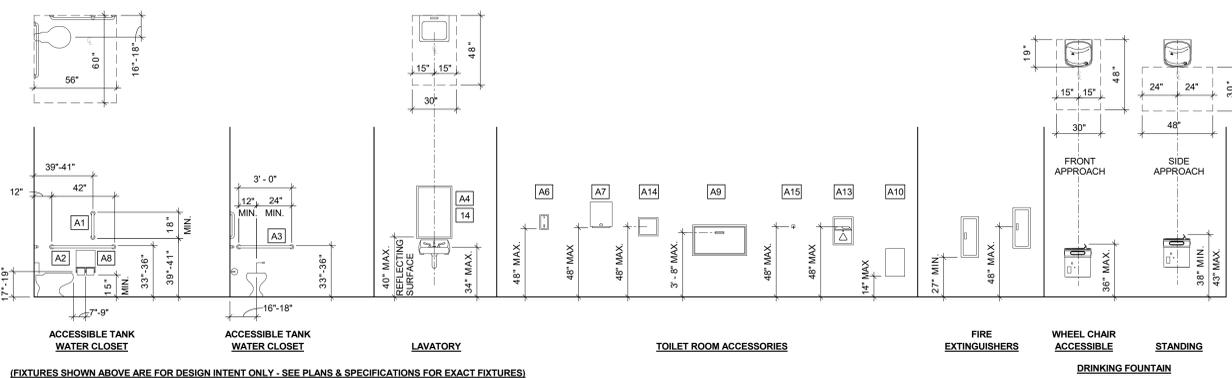

CLEAR FLOOR SPACE REQ.


MARK	SIZE	DESCRIPTION
(A)	30"x48"	DRINKING FOUNTAIN (E.W.C.)
(B)	30"x48"	LAVATORY/SINK
(C)	30"x48"	URINAL
(D)	6"	TOE CLEARANCE AT OUTSIDE PERIMETER OF STALL
(E)	60"	TURNING RADIUS
(F)	56"x60"	WATER CLOSET
(G)	30"x48"	DENOTES CLEAR FLOOR AREA REQ'D WHEN DOOR SWINGS INTO REQ'D CLEAR FLOOR AREA AND/OR TURNING RADIUS.

TOILET ROOM ACCESSORY SCHEDULE

MARK	DESCRIPTION	FURNISHED BY	INSTALLED BY	DESIGN BASIS
A1	GRAB BAR (18")	G.C.	G.C.	BRADLEY, MODEL 832
A2	GRAB BAR (42")	G.C.	G.C.	BRADLEY, MODEL 832
A3	GRAB BARS (36")	G.C.	G.C.	BRADLEY, MODEL 832
A4	MIRROR	G.C.	G.C.	BRADLEY, MODEL 7481 SERIES
A5	WASTE RECEPTACLE - SURFACE MOUNTED	OWNER	G.C.	BRADLEY, MODEL 356
A6	SOAP DISPENSER	OWNER	G.C.	GOJO, MODEL ADX-7
A7	PAPER TOWEL DISPENSER	OWNER	G.C.	GP ENVIOMOTION, MODEL 59462
A8	TOILET TISSUE DISPENSER	G.C.	G.C.	GP COMPACT, MODEL 56790
A9	DIAPER CHANGING STATION	G.C.	G.C.	DIAPER DECK & CO, MODEL: DIAPER DECK
A10	CHILD PROTECTION SEAT	G.C.	G.C.	DIAPER DECK & CO, MODEL: ILL-HOLD-THE-BABY
A11	NAPKIN VENDOR - SURFACE MOUNTED	G.C.	G.C.	BRADLEY, MODEL 4017-11
A12	NAPKIN DISPOSAL - SURFACE MOUNTED	G.C.	G.C.	BRADLEY, MODEL 4781-15
A14	SPECIMEN PASS-THRU CABINET	G.C.	G.C.	BRADLEY, MODEL 3813
A15	COAT HOOK	G.C.	G.C.	BRADLEY, MODEL 9114 BRADEX
A16	SHARPS CONTAINER	OWNER	G.C.	MARKETLAB INC., MODEL MKA8516
A17	SHELF	OWNER	G.C.	BRADLEY, MODEL 758 SERIES

- GENERAL PLAN NOTES**
- SEE SHEET A002 FOR WALL TYPE DESCRIPTIONS.
 - ALL NEW STUD PARTITIONS SHALL BE TYPE 08 UNLESS NOTED OTHERWISE.
 - VERIFY EXISTING DIMENSIONS, CONDITIONS, AND FINISHES BEFORE PROCEEDING WITH WORK. DO NOT SCALE FROM DRAWINGS. BRING ANY DISCREPANCIES TO THE ARCHITECT'S ATTENTION IMMEDIATELY.
 - COORDINATE LOCATIONS AND QUANTITY OF WORK WITH MECHANICAL, ELECTRICAL, AND PLUMBING CONTRACTORS.
 - ALL DIMENSIONS ARE CLEAR FROM CENTERLINE OF WALL/PARTITION TO CENTERLINE OF WALL/PARTITION OR FACE OF EXISTING WALLS ACTUAL FACE.
 - ALL PIPING, CONDUIT AND RELATED MECHANICAL AND ELECTRICAL ITEMS SHALL BE CONCEALED WITHIN GYPSUM BOARD FURRING AS REQUIRED IN FINISHED AREAS WHETHER SHOWN ON DRAWINGS OR NOT, UNLESS NOTED OTHERWISE.
 - PROVIDE METAL PLATE BACKING AND/OR TREATED WOOD BLOCKING IN WALLS WHERE WALL-MOUNTED EQUIPMENT IS SHOWN ON PLANS OR ELEVATIONS. VERIFY HEIGHT AND LENGTH WITH ACTUAL EQUIPMENT.
 - MATCH FINISHED WALL OR PARTITION THICKNESS WHERE NEW WALLS OR PARTITIONS OCCUR IN LINE WITH EXISTING WALL FINISHES, REGARDLESS OF PARTITION TAG.
 - PROVIDE DUST CONTROL BETWEEN CONSTRUCTION AREAS AND OCCUPIED AREAS AT ALL TIMES.
 - PATCH, LEVEL, AND PREP ALL EXISTING WALLS AND COLUMNS SCHEDULED TO RECEIVE WALL FINISHES.
 - FILL, LEVEL, AND ALIGN EXISTING FLOORS AS REQUIRED TO RECEIVE NEW FLOOR FINISHES.
 - REMOVE ALL DEMOLITION AND CONSTRUCTION DEBRIS FROM THE CONSTRUCTION SITE DAILY AND PLACE IN THE APPROPRIATE REUSE OR RECYCLING CONTAINERS. WORK AREA SHALL BE KEPT CLEAN AND FREE OF DUST, DIRT, AND DEBRIS.
 - SEE CODE PLAN AND SUMMARY SHEETS FOR LIFE SAFETY PLANS AND FIRE PARTITION RATINGS.
 - COORDINATE WALL BACKING LOCATIONS FOR SYSTEMS FURNITURE W/ OWNER'S FURNITURE VENDOR.

ACCESSORY / FIXTURE MOUNTING HEIGHTS & CLEARANCES
SCALE: 1/4" = 1'-0"

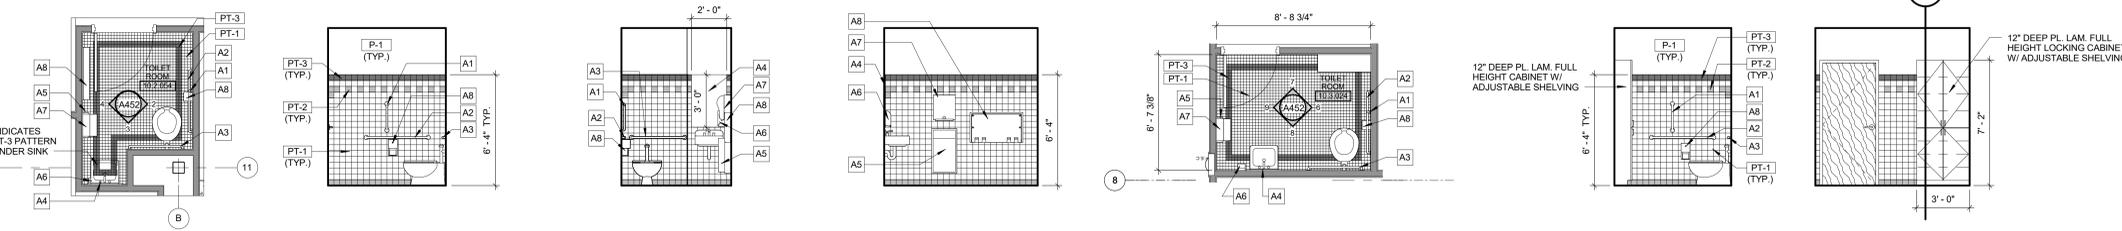

1 TOILET 10.2.054 1/4" = 1'-0"

2 TOILET 10.2.054 1/4" = 1'-0"


3 TOILET 10.2.054 1/4" = 1'-0"

4 TOILET 10.2.054 1/4" = 1'-0"


5 TOILET 10.3.024 1/4" = 1'-0"

6 TOILET 10.3.024 1/4" = 1'-0"

7 TOILET 10.3.024 1/4" = 1'-0"

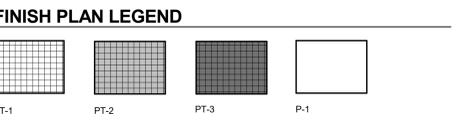

- ROOM FINISH ABBREVIATIONS**
- FLOORS**
- PT PORCELAIN TILE. SEE ENLARGED RESTROOM FLOOR PLANS FOR SPECIFIC LOCATIONS OF THE BELOW:
- PT-1: PORCELAIN TILE. FACTORY MOUNTED GLAZED CERAMIC TILE. COLOR: MATCH EXISTING.
- PT-2: PORCELAIN TILE. FACTORY MOUNTED GLAZED CERAMIC TILE. COLOR: MATCH EXISTING.
- PT-3: PORCELAIN TILE. FACTORY MOUNTED GLAZED CERAMIC TILE. COLOR: MATCH EXISTING.
- WALLS**
- P-1 PAINT: PITTSBURGH PAINTS: SPEEDHIDE INTERIOR FLAT LATEX. COLOR: WHITE ROCK 511-2
- PT PORCELAIN TILE. SEE INTERIOR ELEVATIONS FOR SPECIFIC LOCATIONS OF THE TILE BELOW:
- PT-1 PORCELAIN TILE. FACTORY MOUNTED GLAZED CERAMIC TILE. COLOR: MATCH EXISTING.
- PT-2 PORCELAIN TILE. FACTORY MOUNTED GLAZED CERAMIC TILE. COLOR: MATCH EXISTING.
- PT-3 PORCELAIN TILE. FACTORY MOUNTED GLAZED CERAMIC TILE. COLOR: MATCH EXISTING.

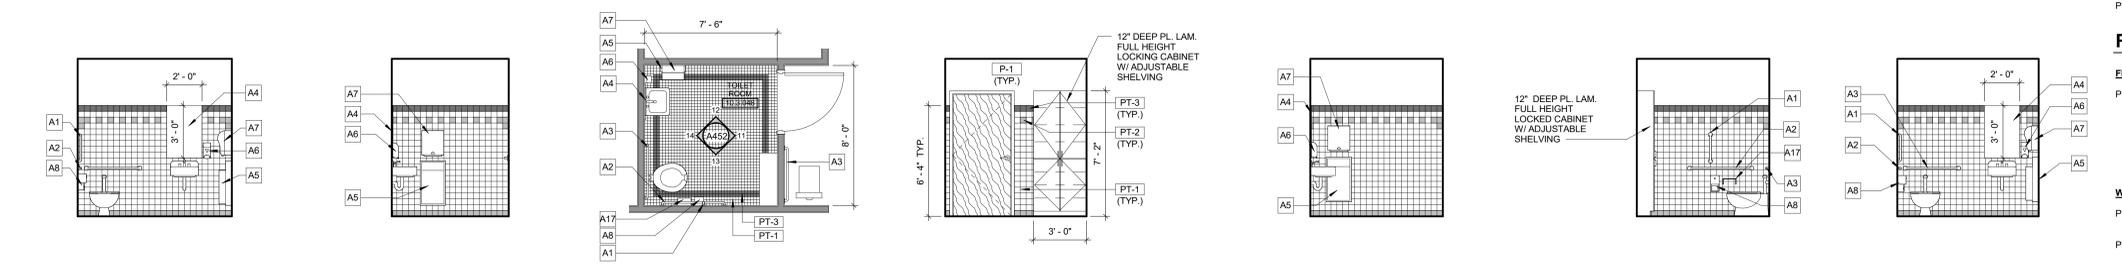

8 TOILET 10.3.024 1/4" = 1'-0"

9 TOILET 10.3.024 1/4" = 1'-0"


10 TOILET 10.3.048 1/4" = 1'-0"

11 TOILET 10.3.048 1/4" = 1'-0"

12 TOILET 10.3.048 1/4" = 1'-0"

13 TOILET 10.3.048 1/4" = 1'-0"

14 TOILET 10.3.048 1/4" = 1'-0"

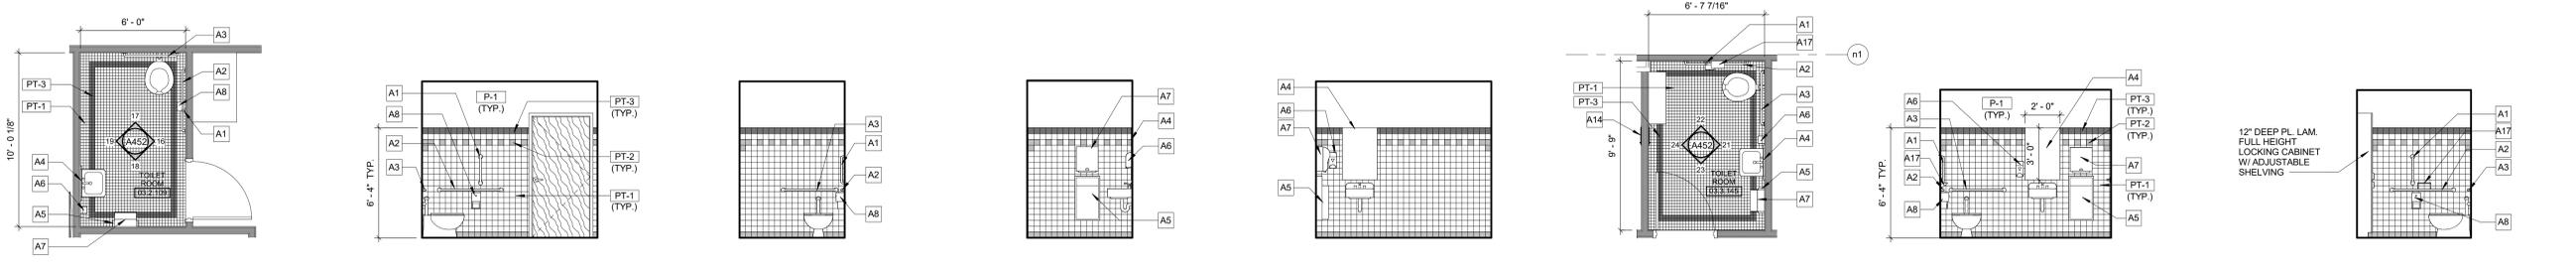

15 TOILET 03.2.109 1/4" = 1'-0"

16 TOILET 03.2.109 1/4" = 1'-0"

17 TOILET 03.2.109 1/4" = 1'-0"

18 TOILET 03.2.109 1/4" = 1'-0"

19 TOILET 03.2.109 1/4" = 1'-0"

20 TOILET 03.3.145 1/4" = 1'-0"

21 TOILET 03.3.145 1/4" = 1'-0"

22 TOILET 03.3.145 1/4" = 1'-0"



23 TOILET 03.3.145 1/4" = 1'-0"

24 TOILET 03.3.145 1/4" = 1'-0"

McMAHON ENGINEERS ARCHITECTS
1000 N. WISCONSIN ST., SUITE 200, MILWAUKEE, WI 53233
Tel: (414) 751-4200 Fax: (414) 751-4284 www.mcmahon.com


DESIGNED BY: [Signature] DRAWN BY: [Signature]

PROJECT NO.: 0002-61600160


DATE: MARCH 3, 2017

SHEET NO.: A452


ALTERATION / ADDITION
OUTGAMME COUNTY ADMINISTRATION CENTER
S. WALNUT & W. 8TH, APPLETON WI 54911
ENLARGED RESTROOM PLANS AND INTERIOR ELEVATIONS

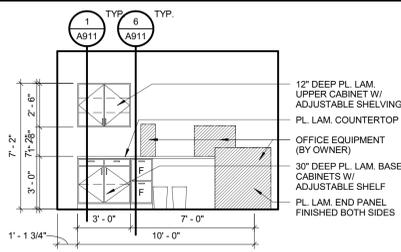


1 OPEN OFFICE 04.0.005
A500 1/4" = 1'-0"

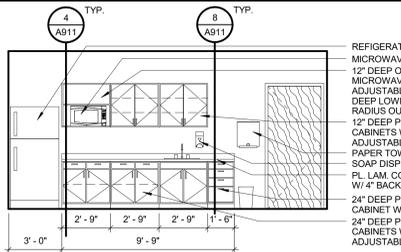


2 CLASSROOM 04.0.007B
A500 1/4" = 1'-0"

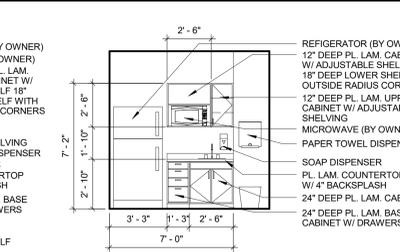


3 CORRIDOR 04.0.009
A500 1/4" = 1'-0"

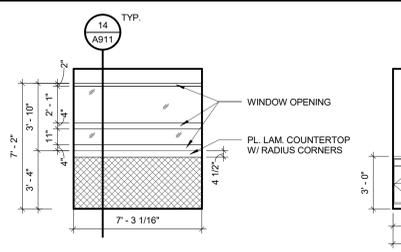

4 WAITING ROOM 01.3.001
A500 1/4" = 1'-0"

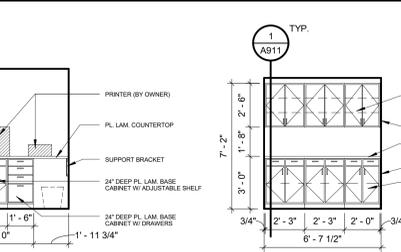


5 HALL 01.1.028
A500 1/4" = 1'-0"

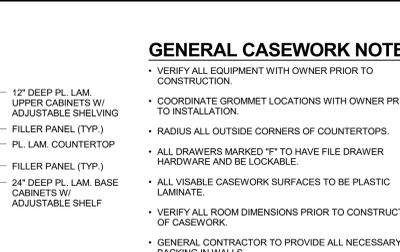


6 WORK ROOM 01.1.020
A500 1/4" = 1'-0"


- GENERAL CASEWORK NOTES**
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 - COORDINATE GROMMET LOCATIONS WITH OWNER PRIOR TO INSTALLATION.
 - RADIUS ALL OUTSIDE CORNERS OF COUNTERTOPS.
 - ALL DRAWERS MARKED "F" TO HAVE FILE DRAWER HARDWARE AND BE LOCKABLE.
 - ALL VISIBLE CASEWORK SURFACES TO BE PLASTIC LAMINATE.
 - VERIFY ALL ROOM DIMENSIONS PRIOR TO CONSTRUCTION OF CASEWORK.
 - GENERAL CONTRACTOR TO PROVIDE ALL NECESSARY BACKING IN WALLS.
 - SUPPLY AND INSTALL SUPPORT BRACKETS AS NEEDED UNDER COUNTERTOPS.
 - MINIMUM 1" FILLER WHERE CABINET IS 90 DEGREES TO WALL OR OTHER CABINETS

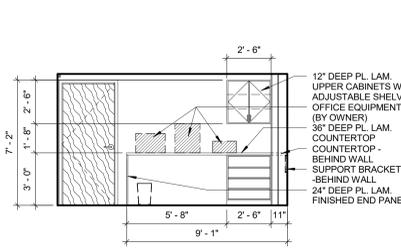


7 WORK ROOM 01.1.022
A500 1/4" = 1'-0"

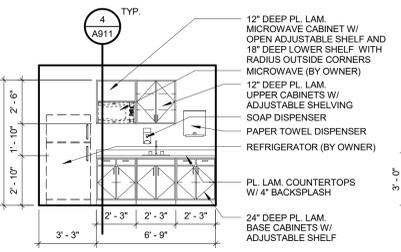


8 KITCHENETTE 01.1.031
A500 1/4" = 1'-0"

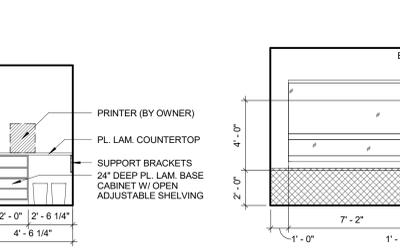


9 WORK AREA 01.1.036
A500 1/4" = 1'-0"

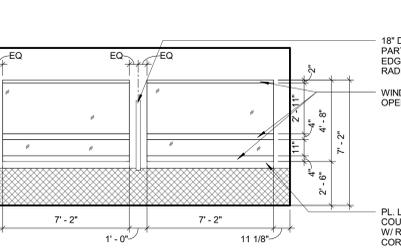


10 WAITING ROOM 10.1.078
A500 1/4" = 1'-0"

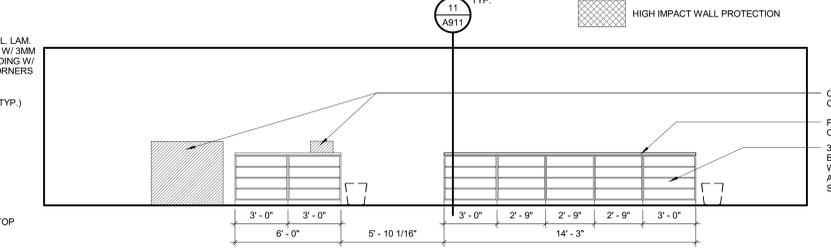


11 OPEN OFFICE 10.1.139 - NORTH
A500 1/4" = 1'-0"

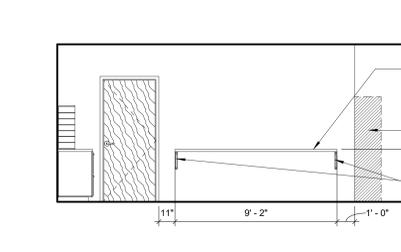


12 WORK ROOM 10.1.141
A500 1/4" = 1'-0"

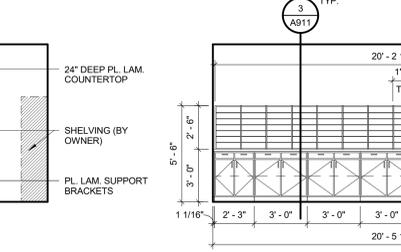


13 WORK ROOM 10.1.141
A500 1/4" = 1'-0"

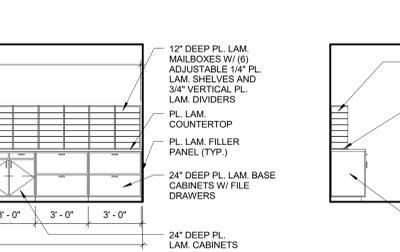


14 WORK ROOM 10.1.141
A500 1/4" = 1'-0"

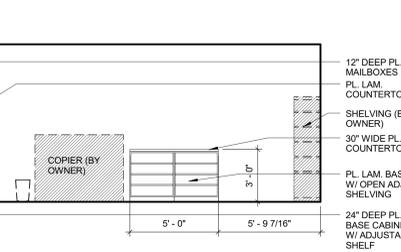


15 WORK ROOM 10.1.141
A500 1/4" = 1'-0"

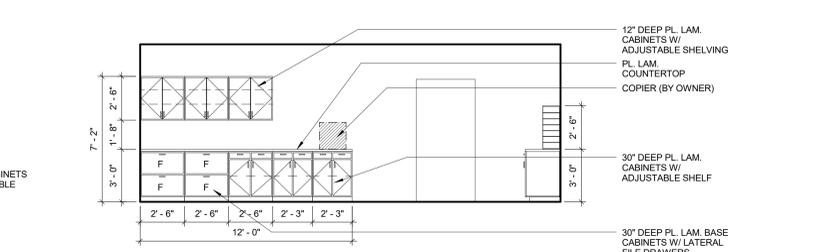


16 WORK AREA
A500 1/4" = 1'-0"

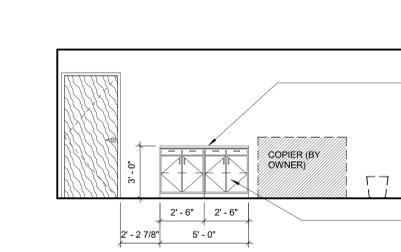


17 BREAKROOM 03.1.186
A500 1/4" = 1'-0"

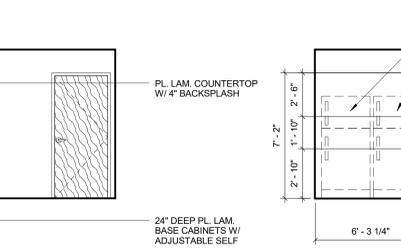


18 BREAKROOM 03.1.186
A500 1/4" = 1'-0"

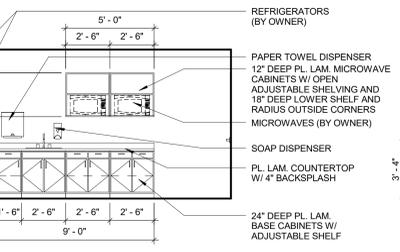


19 WAITING ROOM 03.1.192
A500 1/4" = 1'-0"

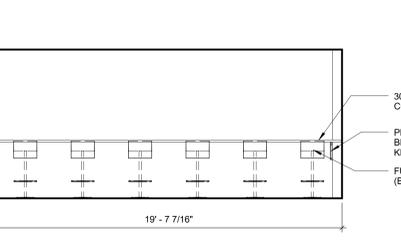


20 INTERVIEW ROOM 03.2.200
A500 1/4" = 1'-0"

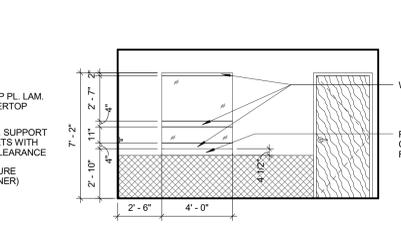


21 WORK ROOM 03.1.201
A500 1/4" = 1'-0"

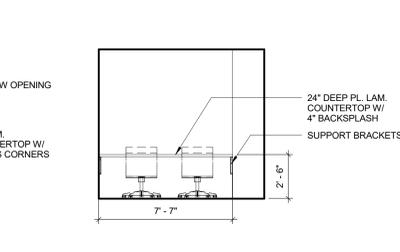


22 WORK ROOM 03.1.201
A500 1/4" = 1'-0"

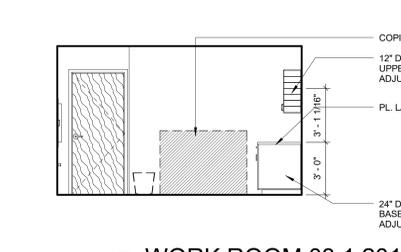


23 WORK ROOM 03.1.201
A500 1/4" = 1'-0"

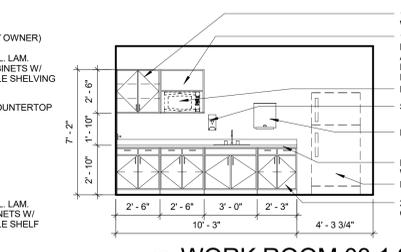


24 SCREENING 10.1.003
A500 1/4" = 1'-0"

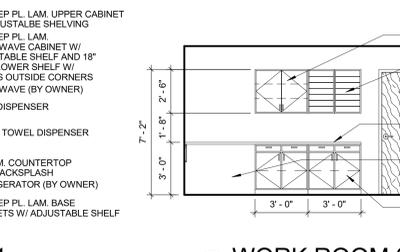


25 CJU 10.1.005 - EAST
A500 1/4" = 1'-0"

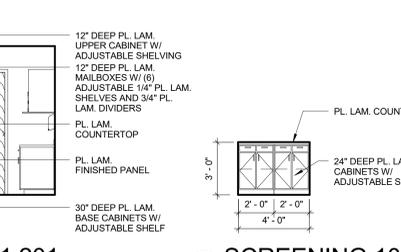


26 CJU 10.1.005 - WEST
A500 1/4" = 1'-0"

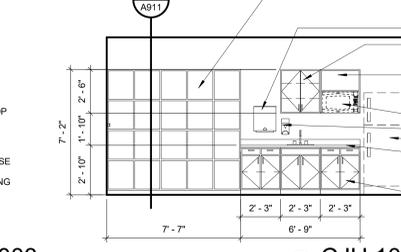


27 WAITING ROOM 10.1.007
A500 1/4" = 1'-0"

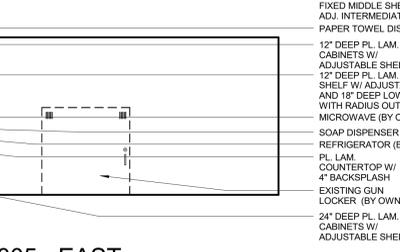

28 OPEN OFFICE 10.1.022
A500 1/4" = 1'-0"

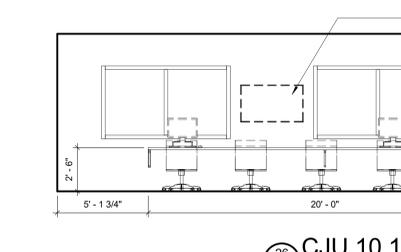


29 KITCHENETTE 10.1.023
A500 1/4" = 1'-0"

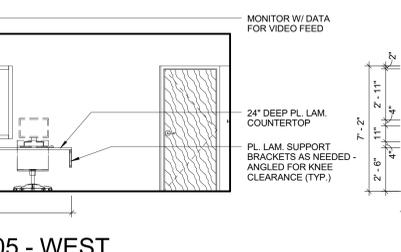


30 ALCOVE 10.1.057
A500 1/4" = 1'-0"


DESIGNED	DRAWN
MAG	BLG
PROJECT NO.	0002-61600160
DATE	MARCH 3, 2017
SHEET NO.	A500

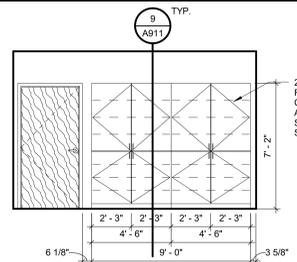


1 CORRIDOR 10.1.054
A501 1/4" = 1'-0"

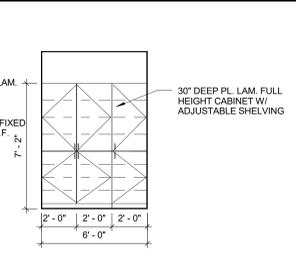


2 CORRIDOR 10.1.038
A501 1/4" = 1'-0"

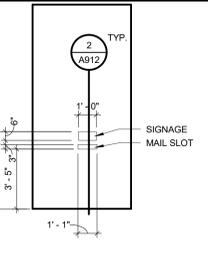


3 MAIL SLOT
A501 1/4" = 1'-0"

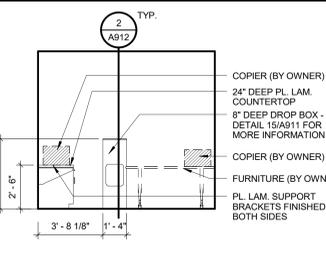

4 APPLICATIONS 10.1.081
A501 1/4" = 1'-0"

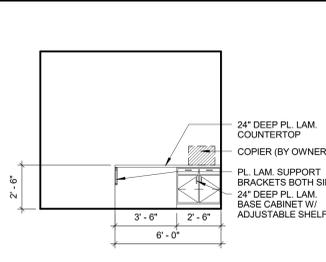


5 APPLICATIONS 10.1.081
A501 1/4" = 1'-0"

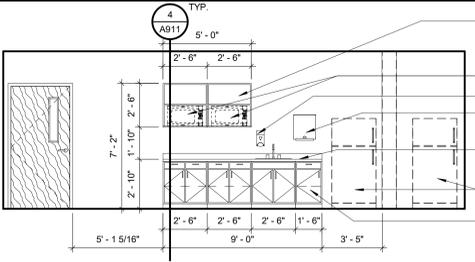


6 KITCHENETTE 10.1.061
A501 1/4" = 1'-0"


- GENERAL CASEWORK NOTES**
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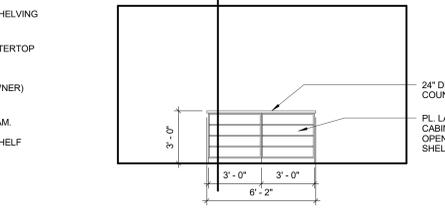
7 CORRIDOR 10.1.060
A501 1/4" = 1'-0"

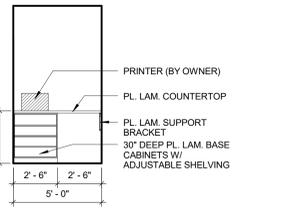


8 WAITING ROOM 10.1.031
A501 1/4" = 1'-0"

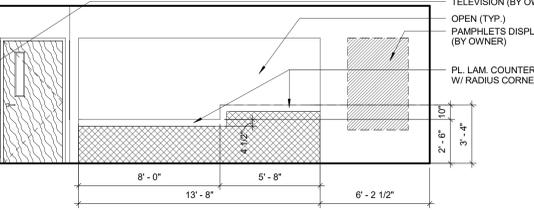


9 OPEN OFFICE 10.1.035
A501 1/4" = 1'-0"

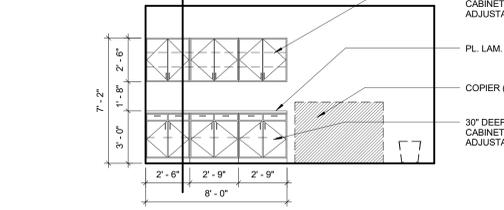


10 OPEN OFFICE 10.1.035
A501 1/4" = 1'-0"

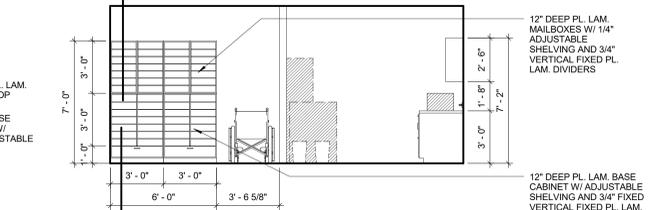


11 ALCOVE 10.1.037 - EAST
A501 1/4" = 1'-0"

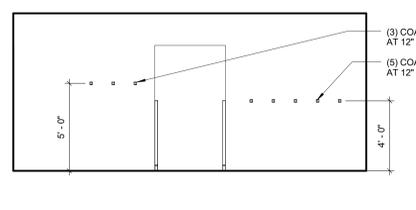


12 ALCOVE 10.1.037 - WEST
A501 1/4" = 1'-0"

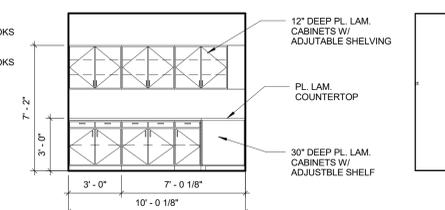


13 WORK ROOM 10.1.036
A501 1/4" = 1'-0"

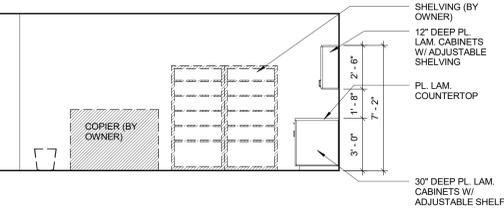


14 WORK ROOM 10.1.036
A501 1/4" = 1'-0"

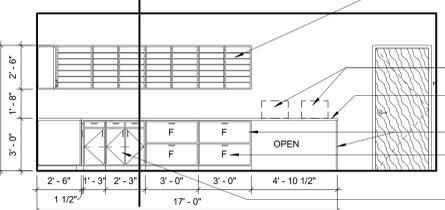


15 WORK ROOM 10.1.036
A501 1/4" = 1'-0"

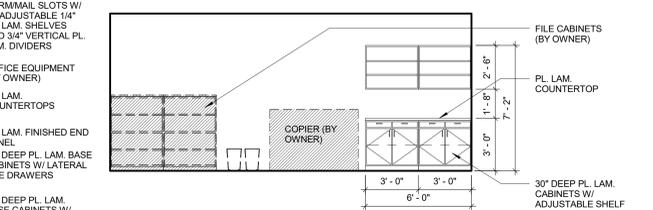


16 WORK AREA 10.1.098
A501 1/4" = 1'-0"

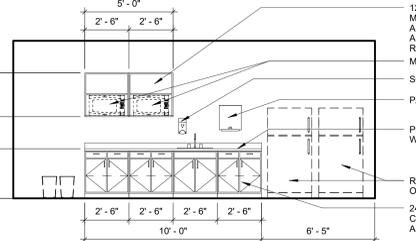


17 KITCHENETTE 10.1.127 - WEST
A501 1/4" = 1'-0"

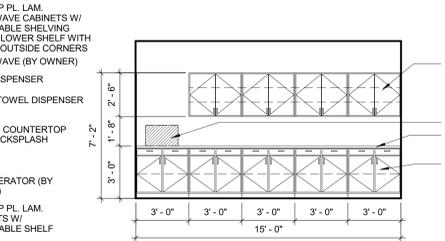


18 WORK ROOM 04.1.017
A501 1/4" = 1'-0"

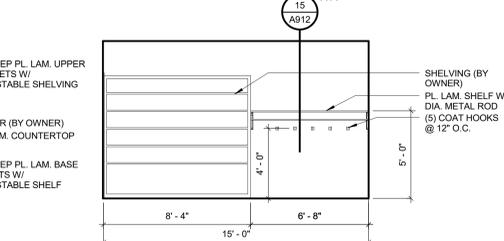


19 WORK ROOM 04.1.017
A501 1/4" = 1'-0"

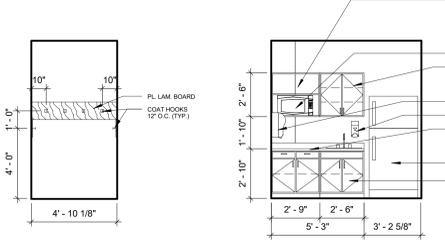


20 COAT HOOKS
A501 1/4" = 1'-0"

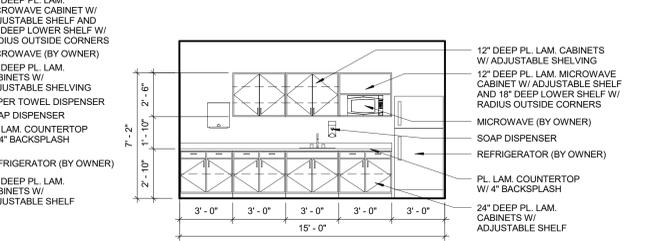


21 KITCHENETTE 04.1.037
A501 1/4" = 1'-0"

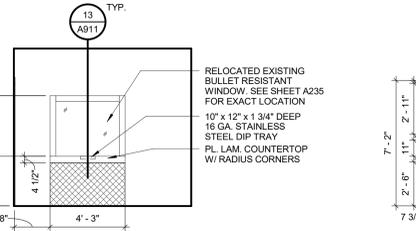


23 WAITING ROOM 04.1.001
A501 1/4" = 1'-0"

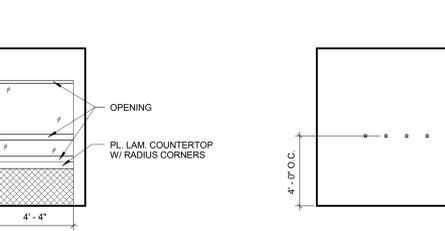


24 WAITING ROOM 10.2.038
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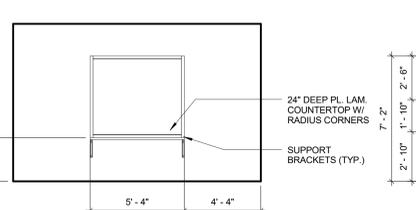
25 WAITING ROOM 10.2.033
A501 1/4" = 1'-0"

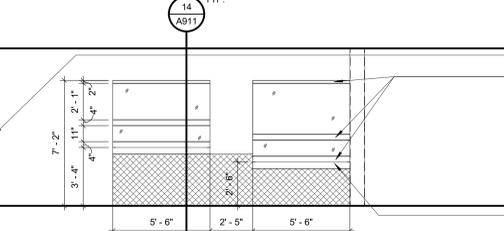


26 WORK ROOM 10.2.043
A501 1/4" = 1'-0"

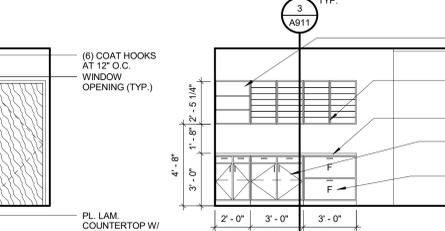


27 WORK ROOM 10.2.043
A501 1/4" = 1'-0"

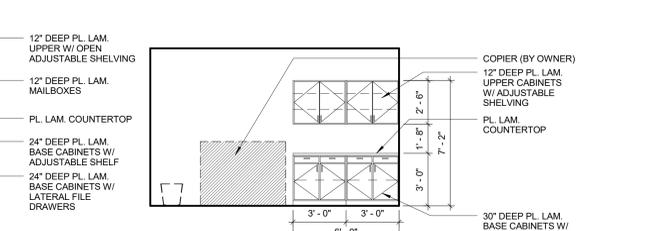


28 OBSERVATION ROOM 10.2.060
A501 1/4" = 1'-0"

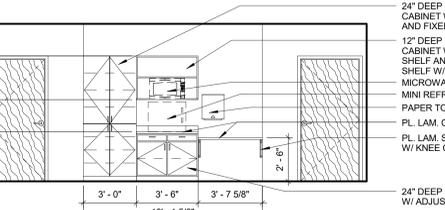


29 VISITATION ROOM A
A501 1/4" = 1'-0"

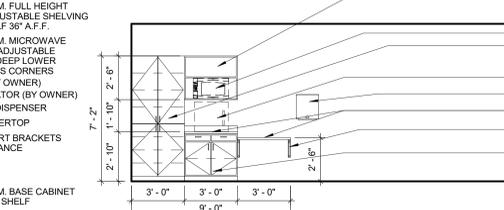

30 TYPICAL VISITATION CASEWORK
A501 1/4" = 1'-0"

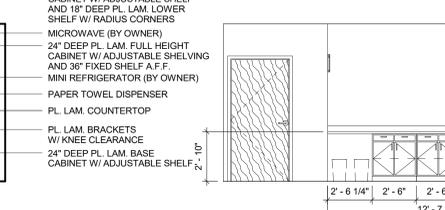

31 CONFERENCE ROOM 10.2.057
A501 1/4" = 1'-0"






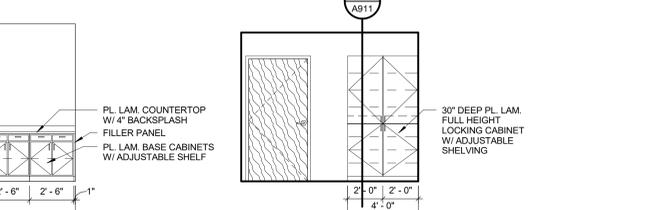


32 HALL 03.2.108
A501 1/4" = 1'-0"

McMAHON ENGINEERS ARCHITECTS
1000 W. WALNUT ST., SUITE 200
APPLETON, WI 54911
TEL: (920) 751-4200 FAX: (920) 751-4284
www.mcmahon.com

DESIGNED BY: MAG
DRAWN BY: BLW
PROJECT NO.: 0002-61600160
DATE: MARCH 3, 2017
SHEET NO.: A501

ALTERATION / ADDITION
OUTGAME COUNTY ADMINISTRATION CENTER
S. WALNUT & W. 8TH, APPLETON WI 54911
INTERIOR ELEVATIONS

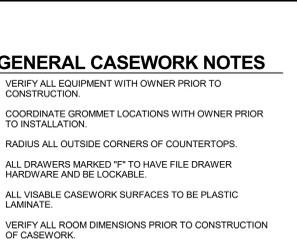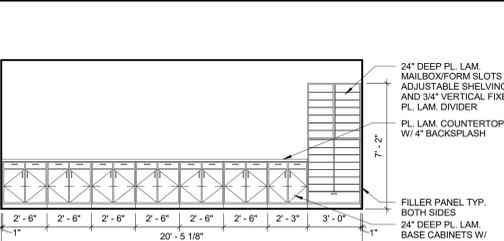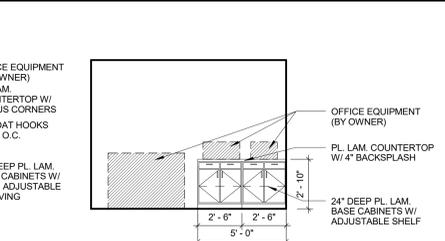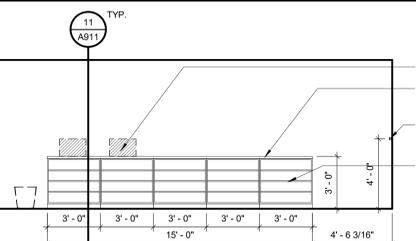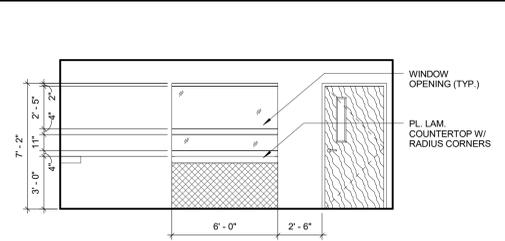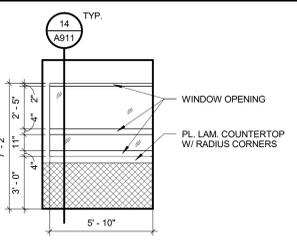

1 WAITING ROOM 03.2.053
A502 1/4" = 1'-0"





2 WAITING ROOM 03.2.053
A502 1/4" = 1'-0"

3 OPEN OFFICE 03.2.113
A502 1/4" = 1'-0"

4 WORK AREA 03.2.086
A502 1/4" = 1'-0"

5 CORRIDOR 03.2.150
A502 1/4" = 1'-0"

- GENERAL CASEWORK NOTES**
- VERIFY ALL EQUIPMENT WITH OWNER PRIOR TO CONSTRUCTION.
 - COORDINATE GROMMET LOCATIONS WITH OWNER PRIOR TO INSTALLATION.
 - RADIUS ALL OUTSIDE CORNERS OF COUNTERTOPS.
 - ALL DRAWERS MARKED "T" TO HAVE FILE DRAWER HARDWARE AND BE LOCKABLE.
 - ALL VISIBLE CASEWORK SURFACES TO BE PLASTIC LAMINATE.
 - VERIFY ALL ROOM DIMENSIONS PRIOR TO CONSTRUCTION OF CASEWORK.
 - GENERAL CONTRACTOR TO PROVIDE ALL NECESSARY BACKING IN WALLS.
 - SUPPLY AND INSTALL SUPPORT BRACKETS AS NEEDED UNDER COUNTERTOPS.
 - MINIMUM 1" FILLER WHERE CABINET IS 90 DEGREES TO WALL OR OTHER CABINETS

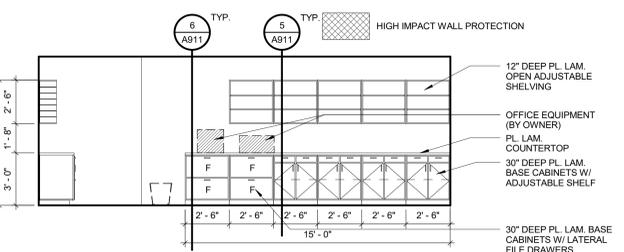
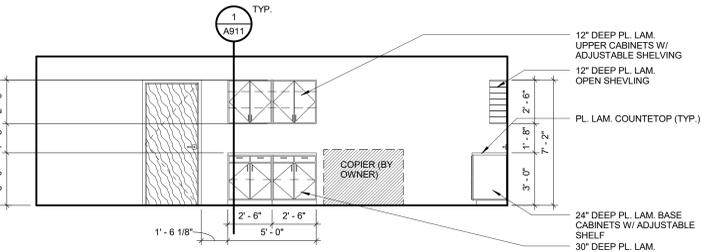
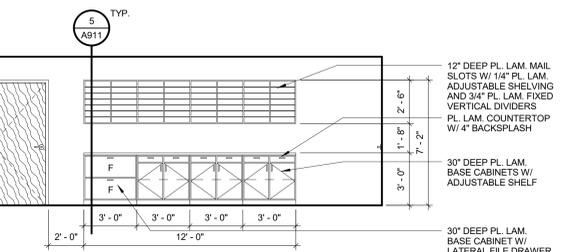
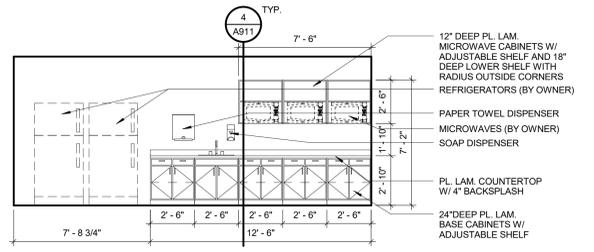


6 KITCHENETTE 03.2.093
A502 1/4" = 1'-0"

7 WORK ROOM 03.2.124
A502 1/4" = 1'-0"

8 WORK ROOM 03.2.124
A502 1/4" = 1'-0"

9 WORK ROOM 03.2.124
A502 1/4" = 1'-0"

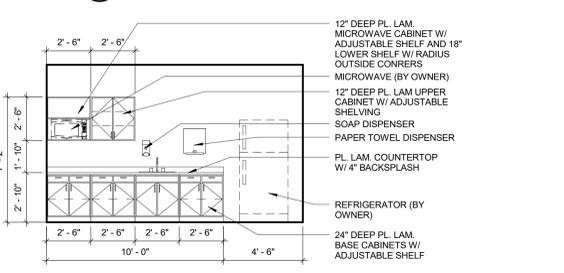
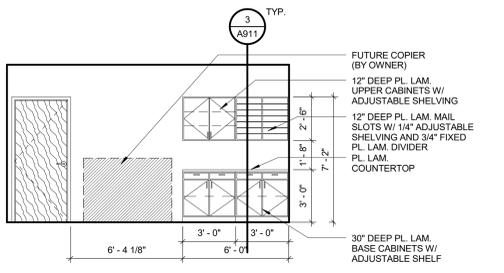
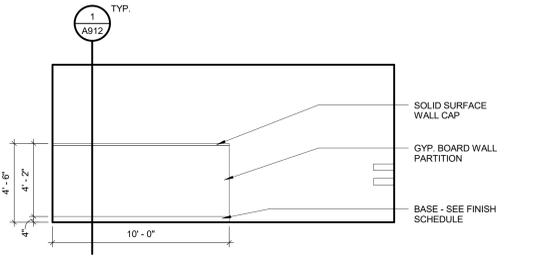
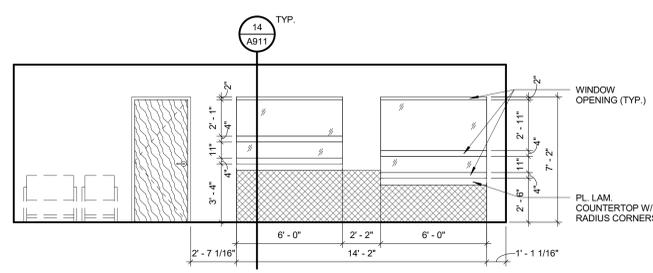


10 WAITING ROOM 10.2.018
A502 1/4" = 1'-0"

11 WAITING ROOM 10.2.018
A502 1/4" = 1'-0"

12 WORK AREA 10.2.025
A502 1/4" = 1'-0"

13 KITCHENETTE 10.2.030
A502 1/4" = 1'-0"


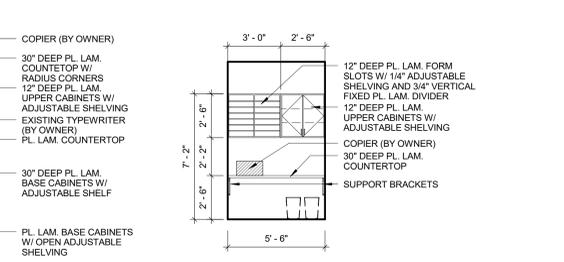
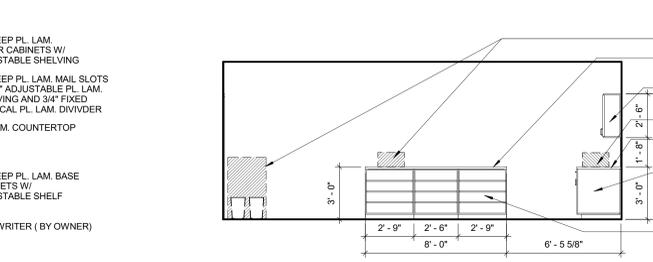
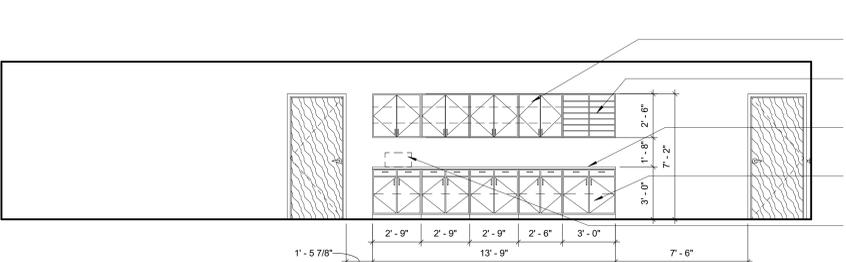
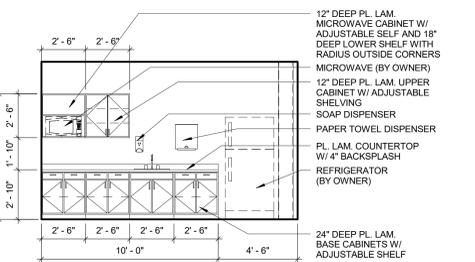


14 KITCHENETTE 10.2.036
A502 1/4" = 1'-0"

15 OPEN OFFICE 10.2.034
A502 1/4" = 1'-0"

16 OPEN OFFICE 10.2.034
A502 1/4" = 1'-0"

17 CORRIDOR 10.2.071
A502 1/4" = 1'-0"

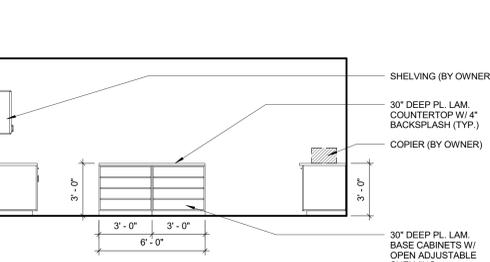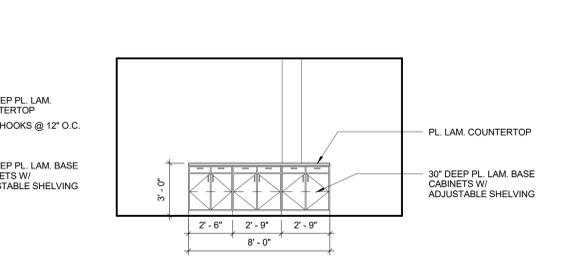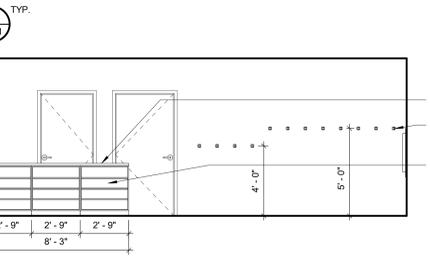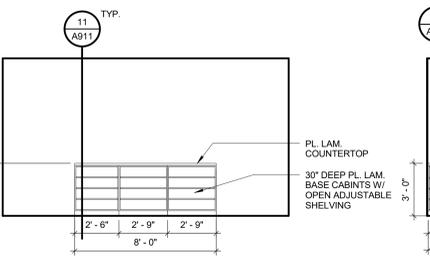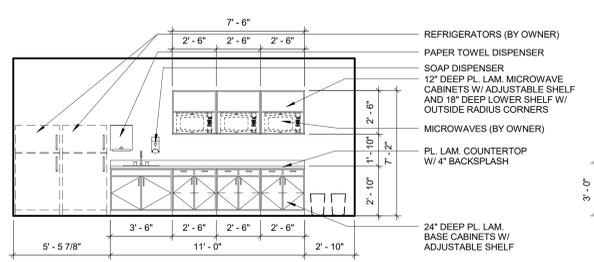






18 KITCHENETTE 10.3.113
A502 1/4" = 1'-0"

19 OPEN OFFICE 10.3.136
A502 1/4" = 1'-0"

20 OPEN OFFICE 10.3.136
A502 1/4" = 1'-0"

21 OPEN OFFICE 10.3.136
A502 1/4" = 1'-0"

22 WORK ROOM 10.3.093
A502 1/4" = 1'-0"

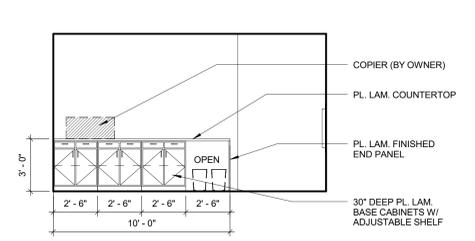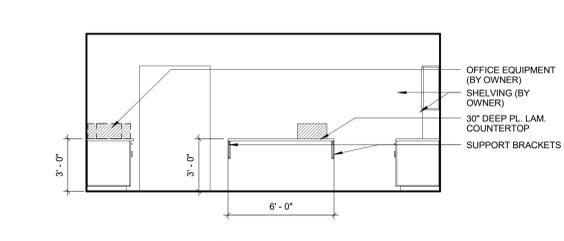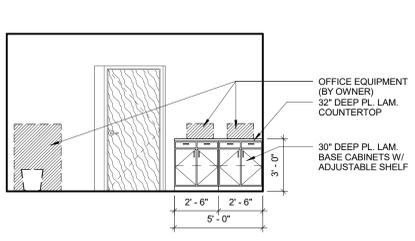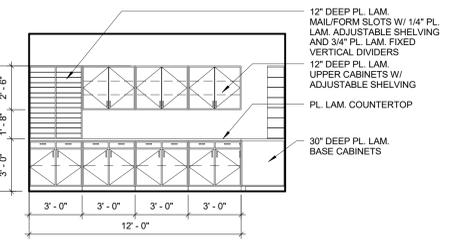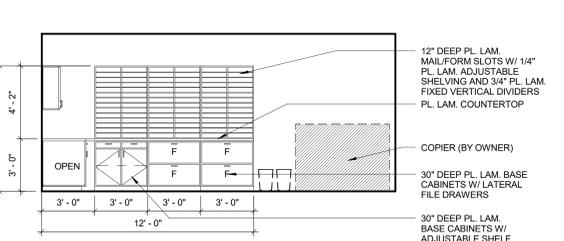

23 WORK ROOM 10.3.093
A502 1/4" = 1'-0"

24 WORK ROOM 10.3.093
A502 1/4" = 1'-0"

25 WORK ROOM 10.3.093
A502 1/4" = 1'-0"

26 WORK ROOM 10.3.093
A502 1/4" = 1'-0"

27 WORK AREA 10.3.122
A502 1/4" = 1'-0"

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NO.	DATE	REVISION

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REVISION

NO.	DATE	DESCRIPTION

NO.

DATE


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DATE


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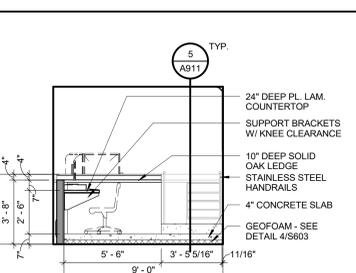
DESIGNED BY: MAG
PROJECT NO: 00002-61600160
DATE: MARCH 3, 2017
SHEET NO: A504




1 CRISIS PHONE ROOM 10.3.020
A504 1/4" = 1'-0"

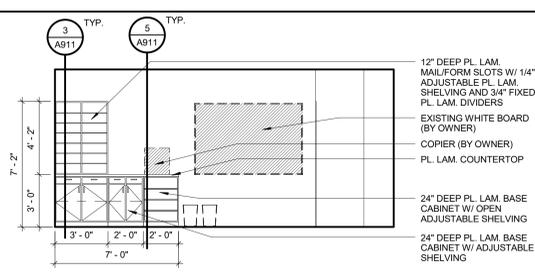


2 WAITING ROOM 10.3.010
A504 1/4" = 1'-0"

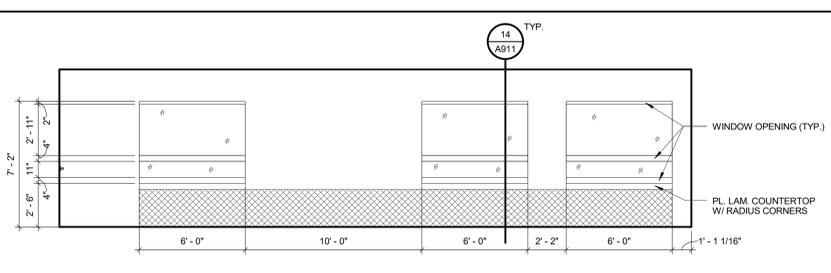


3 F.C. CLERK OF COURTS
A504 1/4" = 1'-0"

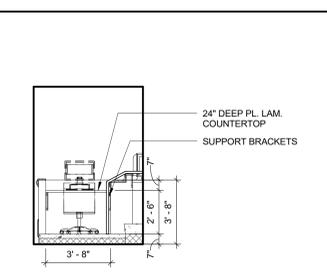


4 F.C. CLERK OF COURTS
A504 1/4" = 1'-0"

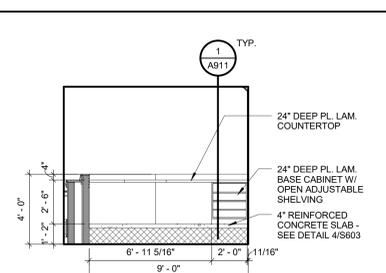


5 F.C. JUDGES BENCH
A504 1/4" = 1'-0"

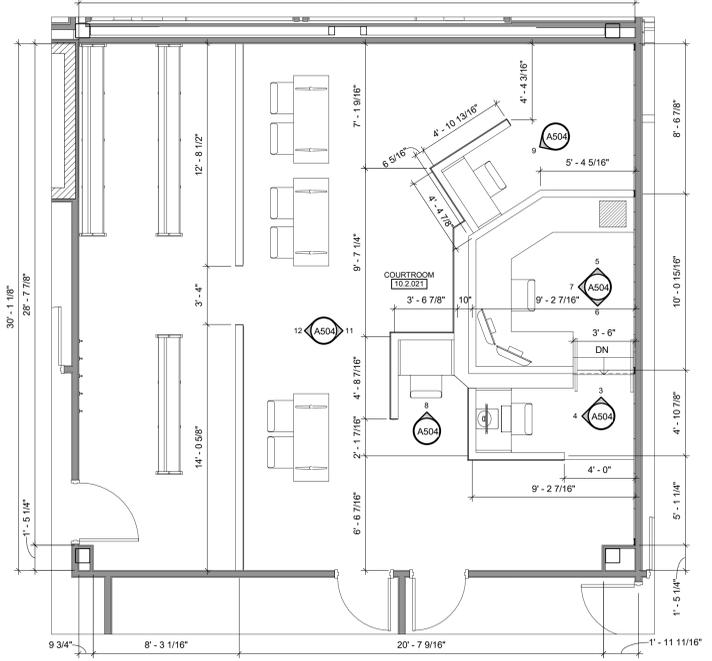


10 OCAC TYPICAL COURTROOM
A504 1/4" = 1'-0"

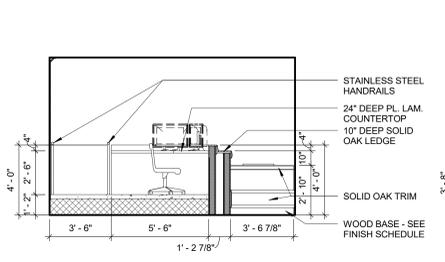


6 F.C. JUDGES BENCH
A504 1/4" = 1'-0"

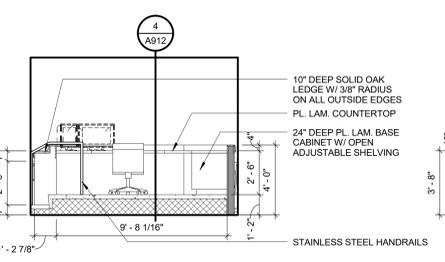


7 F.C. JUDGES BENCH
A504 1/4" = 1'-0"

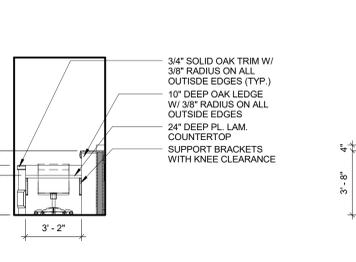


8 F.C. REPORTER
A504 1/4" = 1'-0"

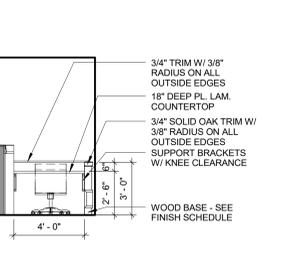


9 F.C. WITNESS
A504 1/4" = 1'-0"

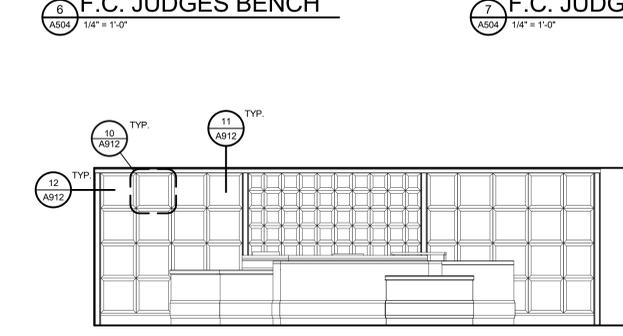


11 F.C. COURTROOM - FRONT ELEVATION
A504 1/4" = 1'-0"

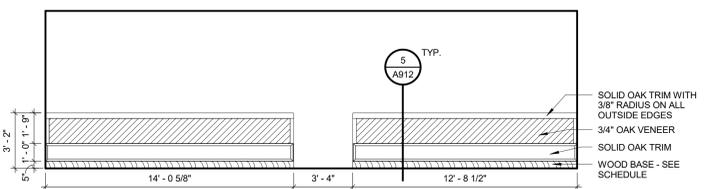


12 TYPICAL COURTROOM RAIL ELEVATION
A504 1/4" = 1'-0"

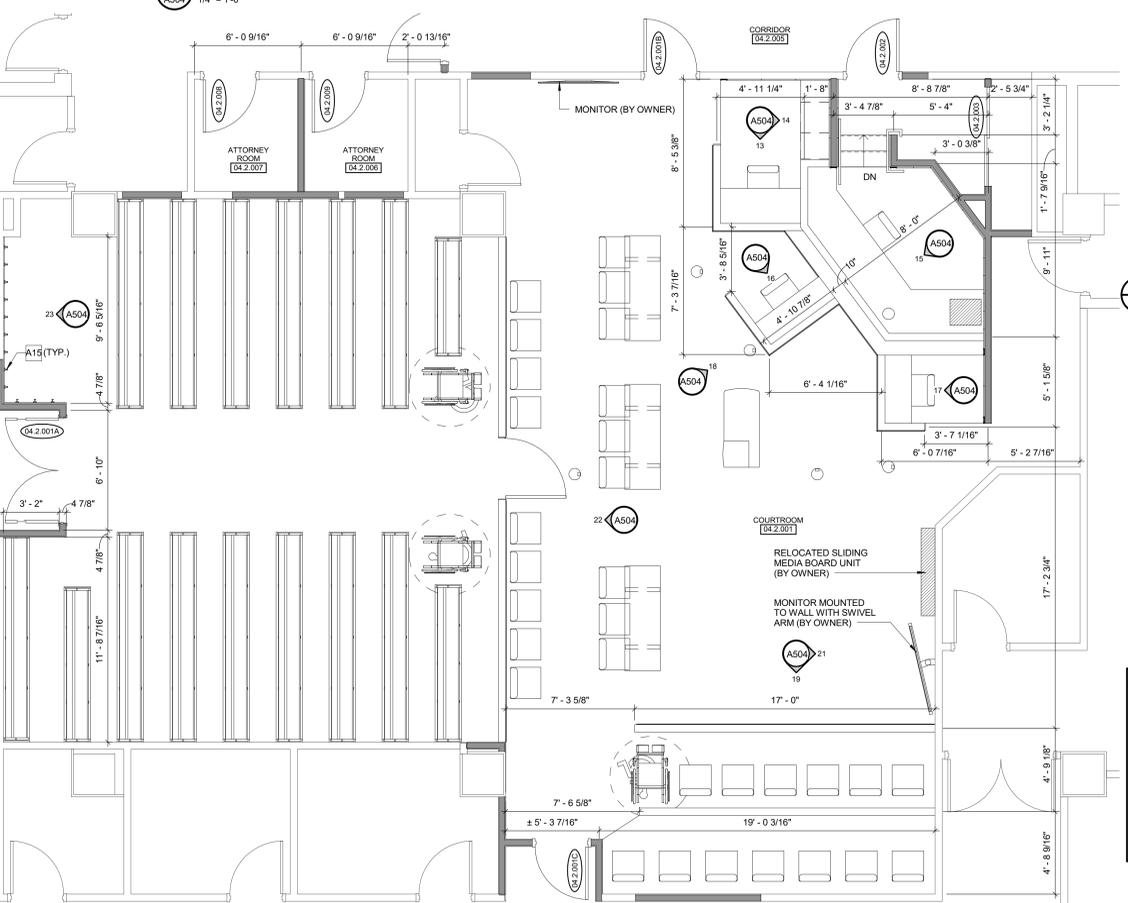


20 JUSTICE CENTER ENLARGED COURTROOM
A504 1/4" = 1'-0"

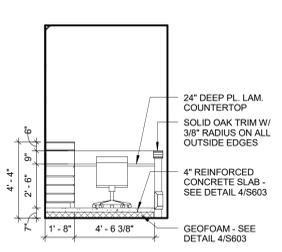


13 J.C. CLERK OF COURTS
A504 1/4" = 1'-0"

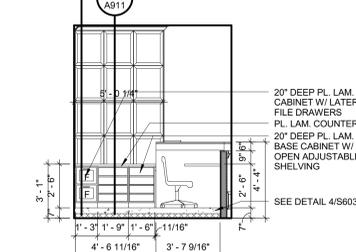


14 J.C. CLERK OF COURTS
A504 1/4" = 1'-0"

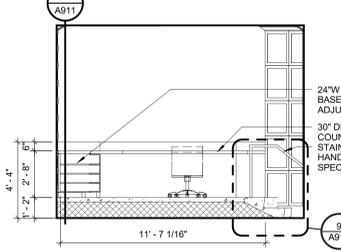


15 J.C. JUDGES BENCH
A504 1/4" = 1'-0"

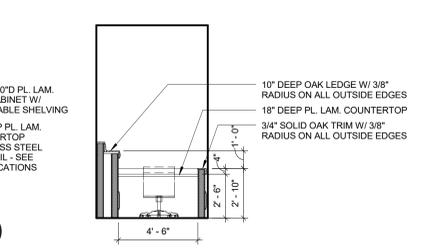


16 J.C. COURT REPORTER
A504 1/4" = 1'-0"

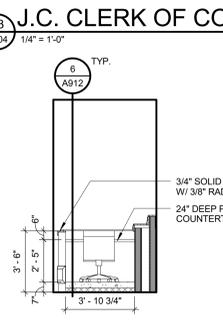


17 J.C. WITNESS
A504 1/4" = 1'-0"

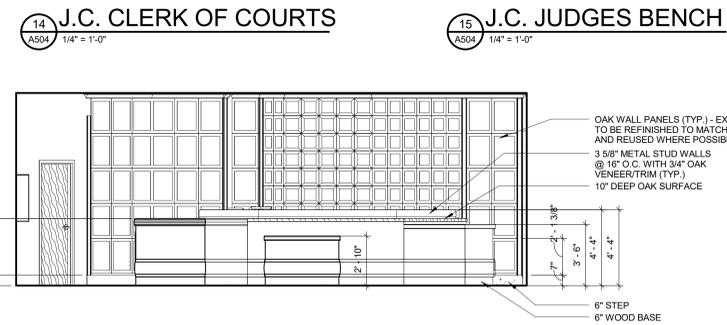


18 COURTROOM 04.2.001
A504 1/4" = 1'-0"

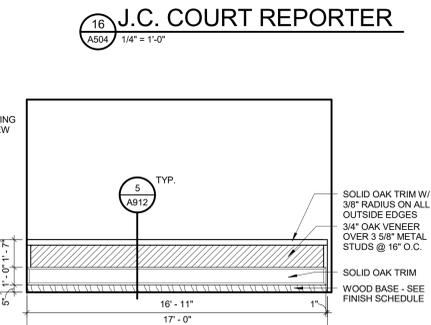


19 COURTROOM JURY STAND
A504 1/4" = 1'-0"

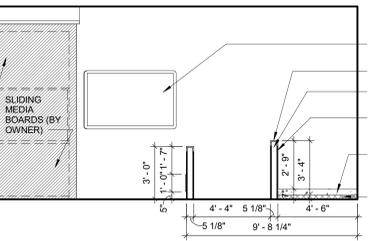



21 JURY STAND - EAST
A504 1/4" = 1'-0"

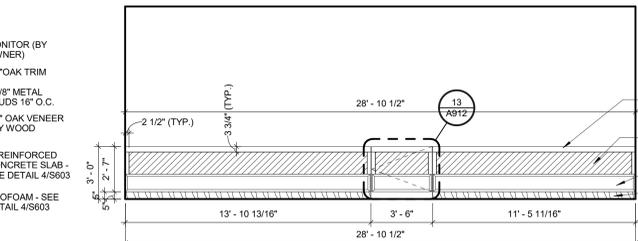


22 J.C. RAIL ELEVATION
A504 1/4" = 1'-0"

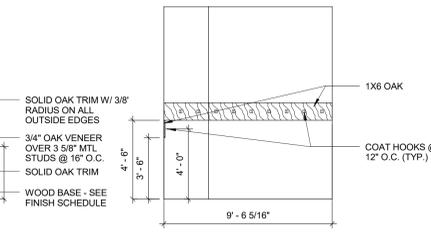

23 COAT HOOKS
A504 1/4" = 1'-0"

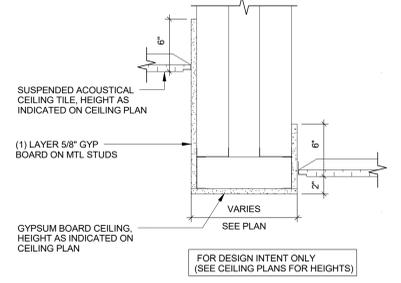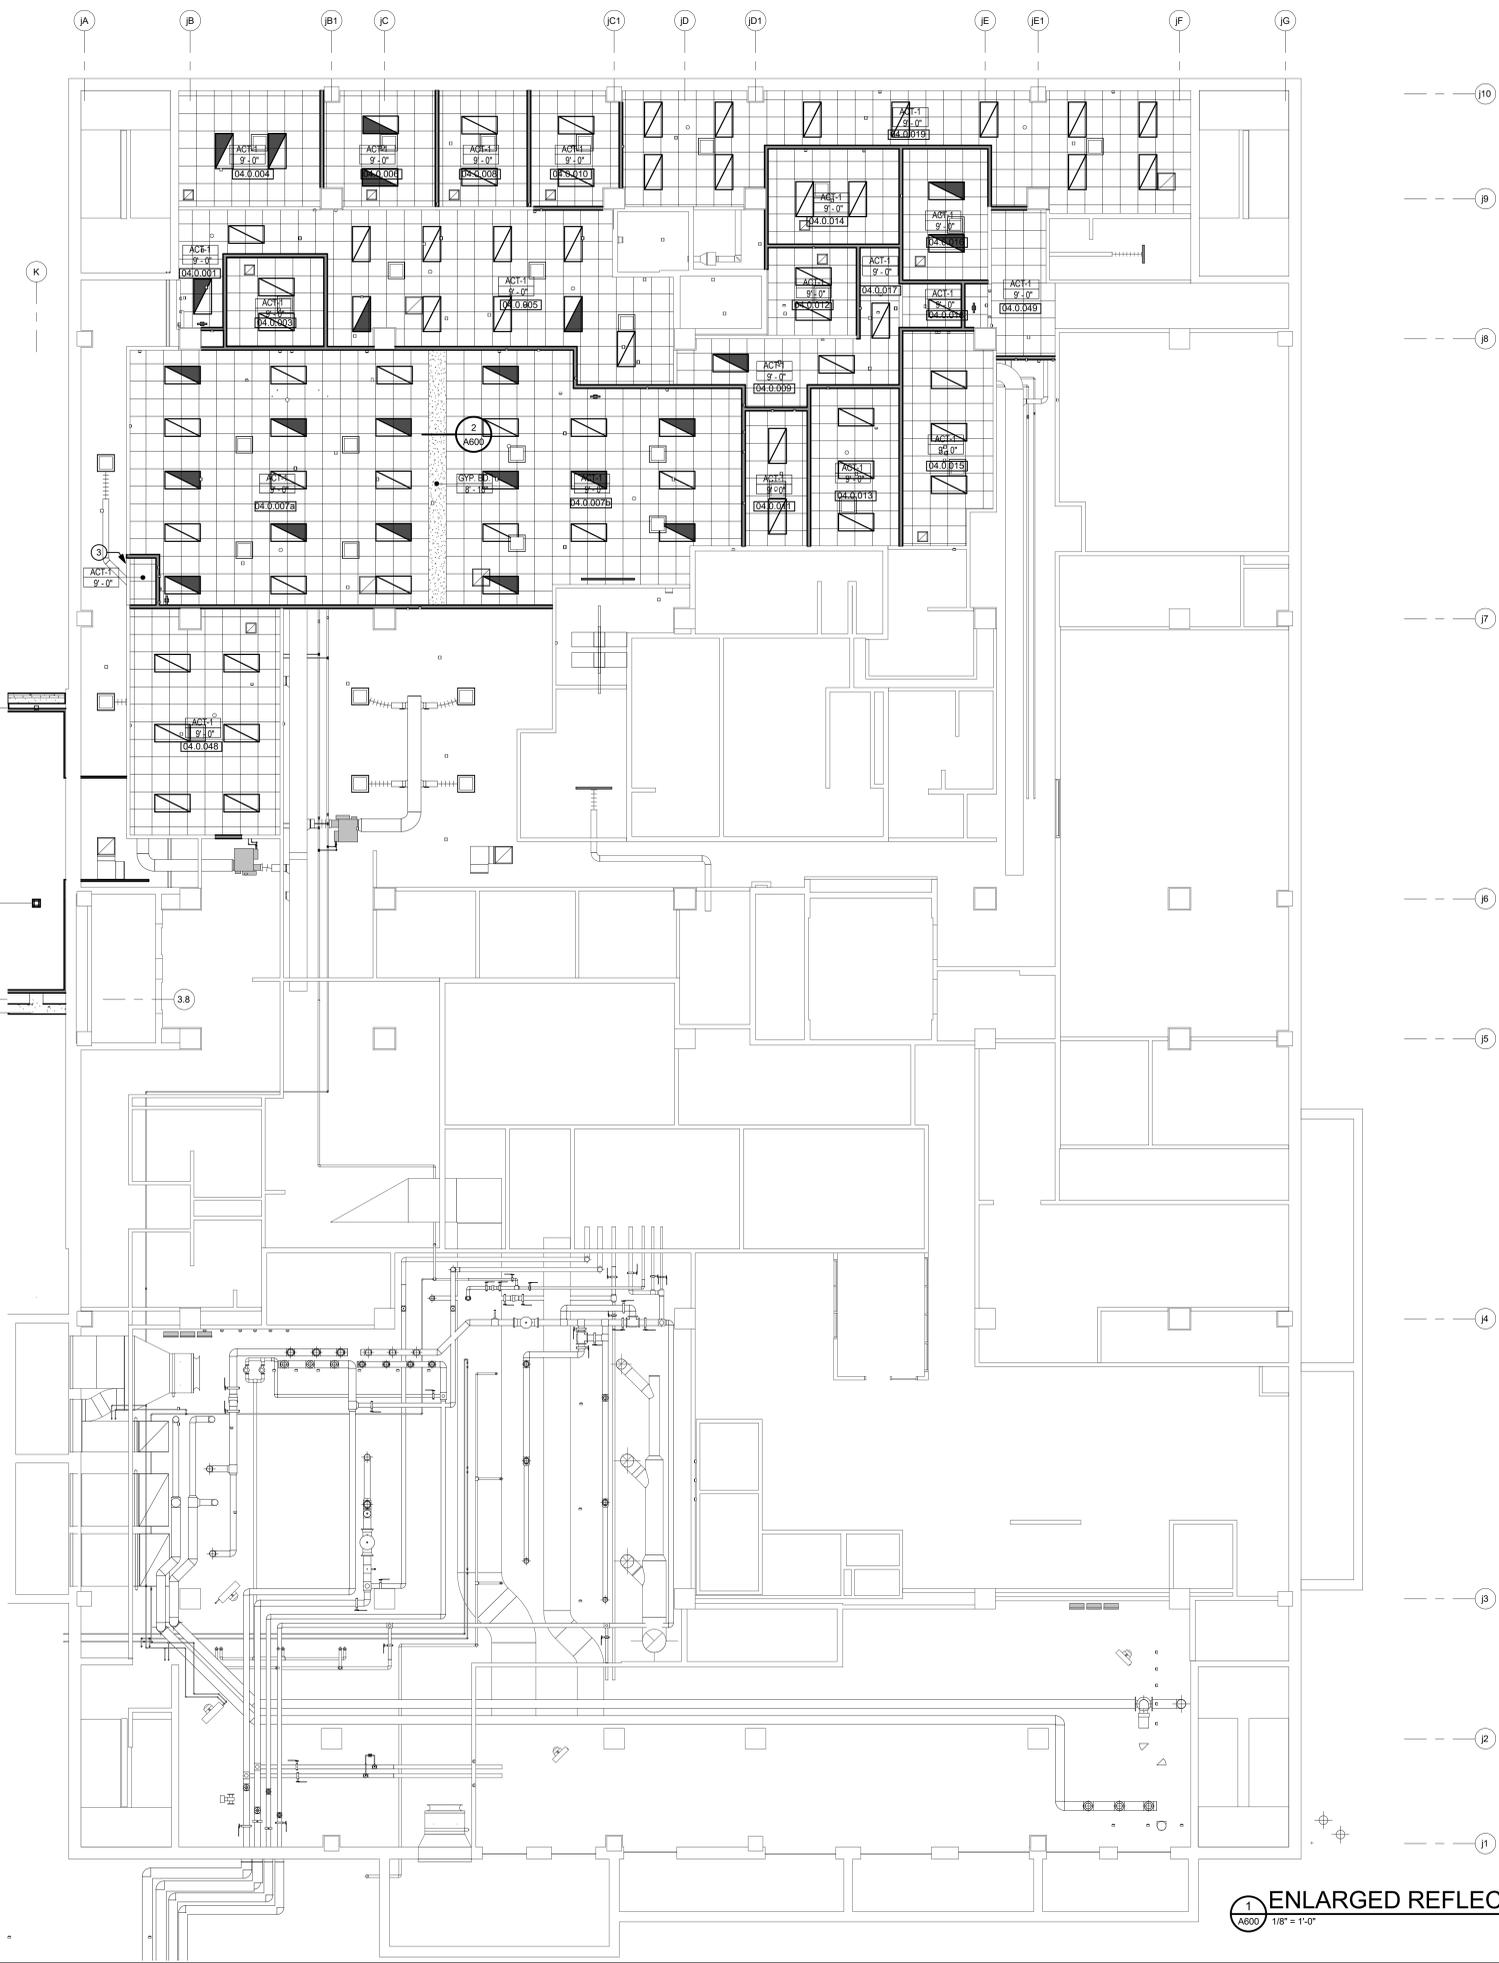

2 TYPICAL SOFFIT
 A600 1/12" = 1'-0"

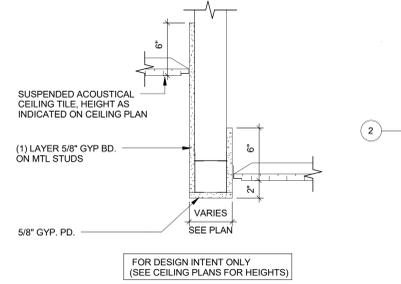

3 TYPICAL BULKHEAD
 A600 1/12" = 1'-0"

1 ENLARGED REFLECTED CEILING PLAN
 A600 1/8" = 1'-0"


- GENERAL CEILING PLAN NOTES**
- SEE MECHANICAL AND ELECTRICAL DRAWINGS FOR DEVICE/FIXTURE TYPES SIZES, INSTALLATION AND SPECIFICATIONS.
 - VERIFY ALL CONDITIONS AND DIMENSIONS PRIOR TO CEILING INSTALLATION.
 - CEILING PLAN SHOWS DESIGN INTENT ONLY. REFER TO SPECIFICATIONS AS WELL AS MECHANICAL AND ELECTRICAL DRAWINGS FOR DEVICES, TYPES AND INSTALLATION. DEVICES SHOWN ON ARCHITECTURAL PLAN AND NOT ON THE ENGINEERING DRAWINGS OR SPECIFICATIONS SHOULD BE BROUGHT TO ARCHITECTS ATTENTION FOR CLARIFICATION.
 - ACOUSTICAL CEILING GRID SHALL BE CENTERED IN ROOMS UNLESS NOTED OTHERWISE.
 - CEILING HEIGHTS ARE DIMENSIONED FROM FINISH FLOOR LINE TO DESIGN ELEVATION OF FINISHED CEILING UNLESS NOTED OTHERWISE.
 - CENTER IN BOTH DIRECTIONS RECESSED LIGHTS, ELECTRICAL AND MECHANICAL DEVICES AND SPRINKLER HEADS WHEN SHOWN IN CEILING TILE.
 - MECHANICAL, PLUMBING AND ELECTRICAL CONTRACTORS SHALL COORDINATE DEVICES REQUIRING ACCESS IN NON ACCESSIBLE CEILING. PROVIDE ACCESS PANELS AS NEEDED (EXAMPLE: MECHANICAL VAV BOXES, PLUMBING CLEANOUTS, ETC.).
 - SEE ELECTRICAL LIGHTING PLANS FOR LIGHT FIXTURE LAYOUT AND LIGHT FIXTURE NOTES. LIGHT FIXTURES SHOWN ON THE REFLECTED CEILING PLANS ARE FOR REFERENCE ONLY.

CEILING HEIGHTS SHOWN ARE ESTIMATES OF WHAT CAN BE ACCOMPLISHED. MECHANICAL EQUIPMENT MAY NECESSITATE A CHANGE TO THESE HEIGHTS. VERIFY FEASIBLE CEILING HEIGHTS AND DISCUSS NECESSARY CHANGES WITH THE ARCHITECT PRIOR TO INSTALLATION OF SYSTEMS ABOVE CEILING.

- CEILING PLAN LEGEND**
- CEILING FINISH
 - CEILING HEIGHT (A.F.F.)
 - ROOM NUMBER
 - EXPOSED CEILING
 - GYP. BOARD CEILING/SOFFIT (GYP) - SEE SPECIFICATIONS FOR ADDITIONAL INFORMATION
 - ACOUSTICAL CEILING (ACT) - SEE SPECIFICATIONS FOR ADDITIONAL INFORMATION
 - HVAC GRILLS - SEE HVAC PLANS
 - 2x4 LAY-IN LIGHT FIXTURE
 - RECESSED DOWNLIGHT FIXTURE
 - SURFACE MOUNTED LINEAR LIGHT FIXTURE
 - HANGING PENDANT FIXTURE

- CEILING DESCRIPTIONS**
- ACT-1 ACT - STANDARD
 - ACT-2 VINYL COVERED GYP., ALUMINUM FRAME
 - ACT-3 FULLY ACCESSIBLE WOOD PANEL CEILING SYSTEM (1/4" HORIZONTAL REVEALS) WITH 4" WOOD SUBSTRATE TRIM
 - GYP GYPSUM BOARD (PAINT)

- PLAN KEYED NOTES**
- 3 PATCH AND RECONFIGURE CEILING AS REQUIRED FOR NEW CONSTRUCTION.

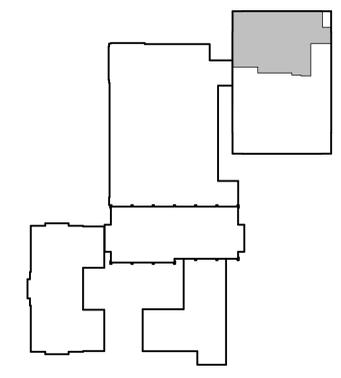


PLAN KEY
 NOT TO SCALE



A600

NO.	DATE	REVISION

DESIGNED MAG	DRAWN BLG
PROJECT NO. 0002-61600160	
DATE MARCH 3, 2017	
SHEET NO.	

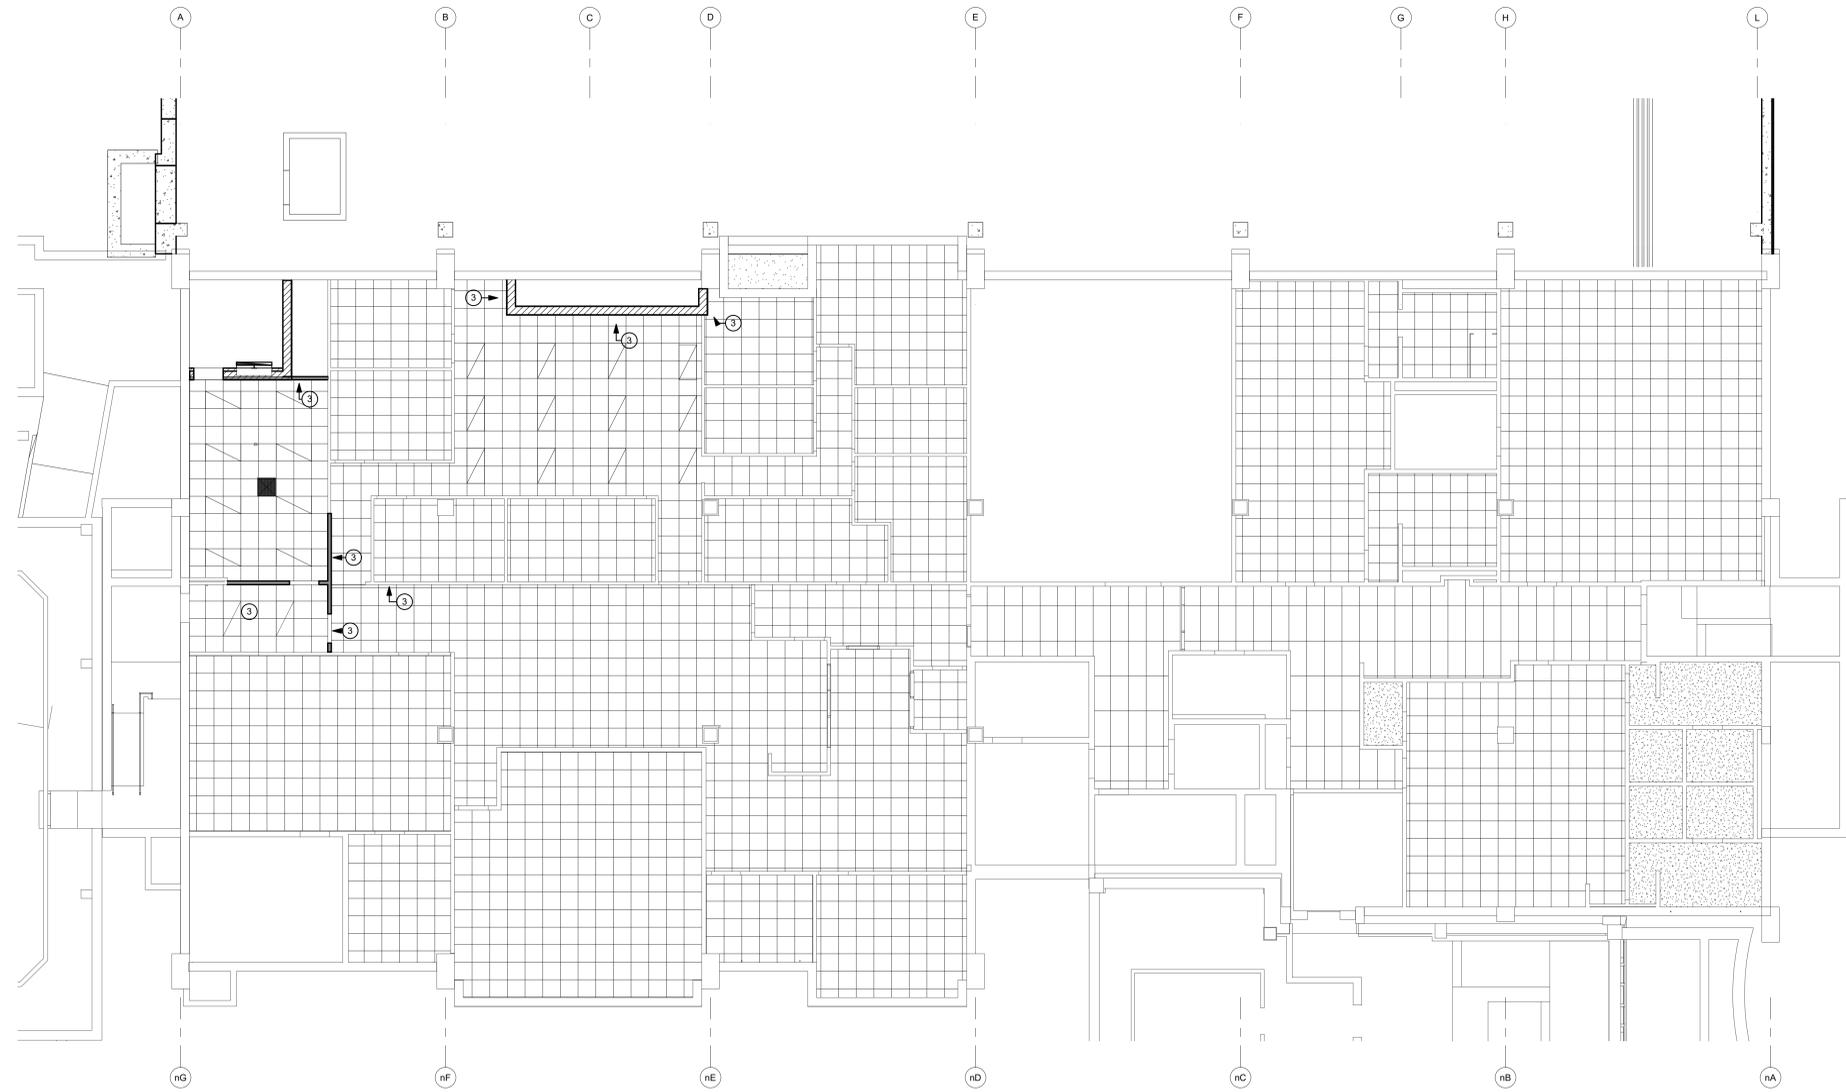

GENERAL CEILING PLAN NOTES

- SEE MECHANICAL AND ELECTRICAL DRAWINGS FOR DEVICE/FIXTURE TYPES, SIZES, INSTALLATION AND SPECIFICATIONS.
- VERIFY ALL CONDITIONS AND DIMENSIONS PRIOR TO CEILING INSTALLATION.
- CEILING PLAN SHOWS DESIGN INTENT ONLY. REFER TO SPECIFICATIONS AS WELL AS MECHANICAL AND ELECTRICAL DRAWINGS FOR DEVICES, TYPES AND INSTALLATION. DEVICES SHOWN ON ARCHITECTURAL PLAN AND NOT ON THE ENGINEERING DRAWINGS OR SPECIFICATIONS SHOULD BE BROUGHT TO ARCHITECTS ATTENTION FOR CLARIFICATION.
- ACOUSTICAL CEILING GRID SHALL BE CENTERED IN ROOMS UNLESS NOTED OTHERWISE.
- CEILING HEIGHTS ARE DIMENSIONED FROM FINISH FLOOR LINE TO DESIGN ELEVATION OF FINISHED CEILING UNLESS NOTED OTHERWISE.
- CENTER IN BOTH DIRECTIONS RECESSED LIGHTS, ELECTRICAL AND MECHANICAL DEVICES AND SPRINKLER HEADS WHEN SHOWN IN CEILING TILE.
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- SEE ELECTRICAL LIGHTING PLANS FOR LIGHT FIXTURE LAYOUT AND LIGHT FIXTURE NOTES. LIGHT FIXTURES SHOWN ON THE REFLECTED CEILING PLANS ARE FOR REFERENCE ONLY.

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CEILING PLAN LEGEND

- CEILING FINISH
- CEILING HEIGHT (A.F.F.)
- 100 ROOM NUMBER
- EXPOSED CEILING
- GYP GYPSUM BOARD CEILING/SOFFIT (GYP) - SEE SPECIFICATIONS FOR ADDITIONAL INFORMATION
- ACT ACOUSTICAL CEILING (ACT) - SEE SPECIFICATIONS FOR ADDITIONAL INFORMATION
- HVAC GRILLS - SEE HVAC PLANS
- 2x4 LAY-IN LIGHT FIXTURE
- RECESSED DOWNLIGHT FIXTURE
- SURFACE MOUNTED LINEAR LIGHT FIXTURE
- HANGING PENDANT FIXTURE


CEILING DESCRIPTIONS

- ACT-1 ACT - STANDARD
- ACT-2 VINYL COVERED GYP, ALUMINUM FRAME
- ACT-3 FULLY ACCESSIBLE WOOD PANEL CEILING SYSTEM (1/4" HORIZONTAL REVEALS) WITH 4" WOOD SUBSTRATE TRIM
- GYP GYPSUM BOARD (PAINT)

PLAN KEYED NOTES

- 3 PATCH AND RECONFIGURE CEILING AS REQUIRED FOR NEW CONSTRUCTION.

1 ENLARGED REFLECTED CEILING PLAN
 A601 1/8" = 1'-0"

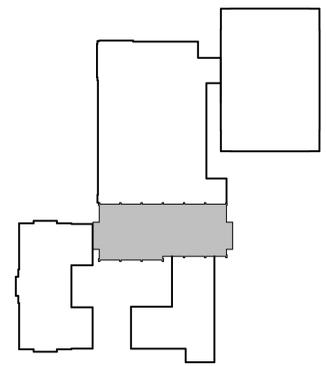

PLAN KEY
 NOT TO SCALE

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NO.	DATE	REVISION

GENERAL CEILING PLAN NOTES

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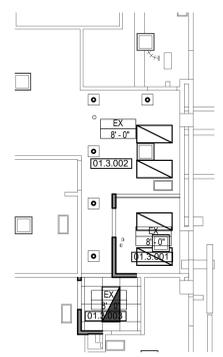
CEILING PLAN LEGEND

- CEILING FINISH
- CEILING HEIGHT (A.F.F.)
- ROOM NUMBER
- EXPOSED CEILING
- GYPSUM BOARD CEILING/SOFFIT (GYP) - SEE SPECIFICATIONS FOR ADDITIONAL INFORMATION
- ACOUSTICAL CEILING (ACT) - SEE SPECIFICATIONS FOR ADDITIONAL INFORMATION
- HVAC GRILLS - SEE HVAC PLANS
- 2x4 LAY-IN LIGHT FIXTURE
- RECESSED DOWNLIGHT FIXTURE
- SURFACE MOUNTED LINEAR LIGHT FIXTURE
- HANGING PENDANT FIXTURE

CEILING DESCRIPTIONS

- ACT-1 ACT - STANDARD
- ACT-2 VINYL COVERED GYP., ALUMINUM FRAME
- ACT-3 FULLY ACCESSIBLE WOOD PANEL CEILING SYSTEM (1/4" HORIZONTAL REVEALS) WITH 4" WOOD SUBSTRATE TRIM
- GYP GYPSUM BOARD (PAINT)


(X) PLAN KEYED NOTES




PLAN KEY
NOT TO SCALE



2 ENLARGED REFLECTED CEILING PLAN
A602 1/8" = 1'-0"

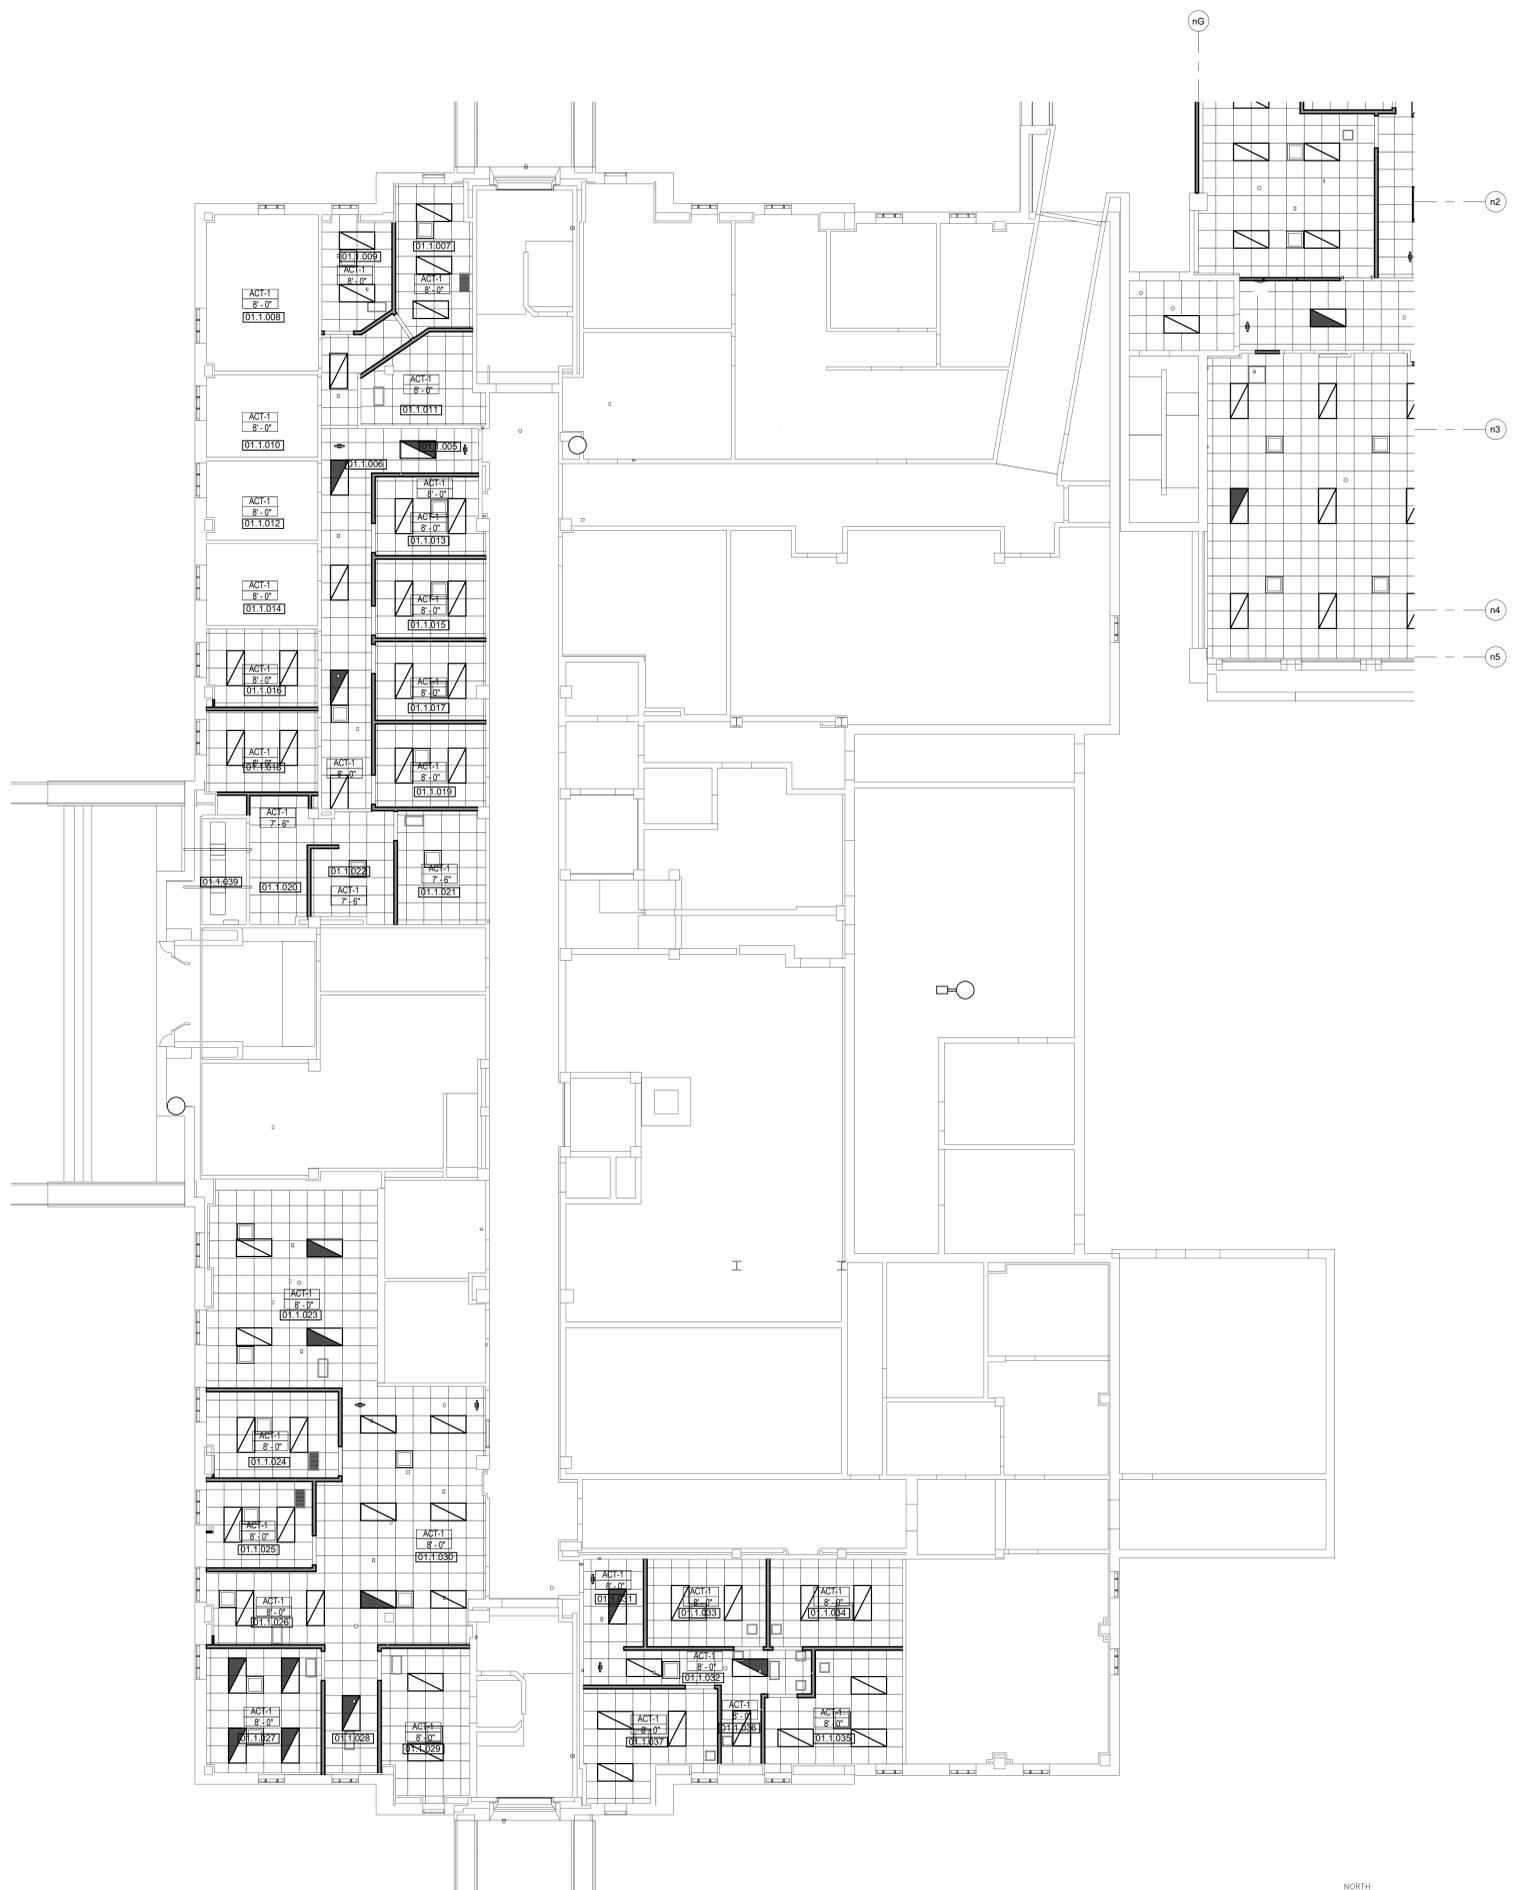

1 ENLARGED REFLECTED CEILING PLAN
A602 1/8" = 1'-0"

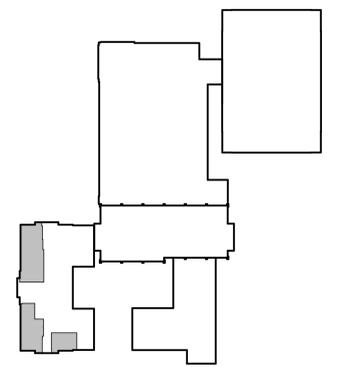


PLAN KEY
NOT TO SCALE

NO.	DATE	REVISION

ALTERATION / ADDITION
OUTAGAME COUNTY ADMINISTRATION CENTER
S. WALNUT & W. 8TH, APPLETON WI 54911
LEVEL 790.00 ENLARGED REFLECTED CEILING PLAN - CAB

DESIGNED MAG	DRAWN BLG
PROJECT NO. 0002-61600160	
DATE MARCH 3, 2017	
SHEET NO. A602	

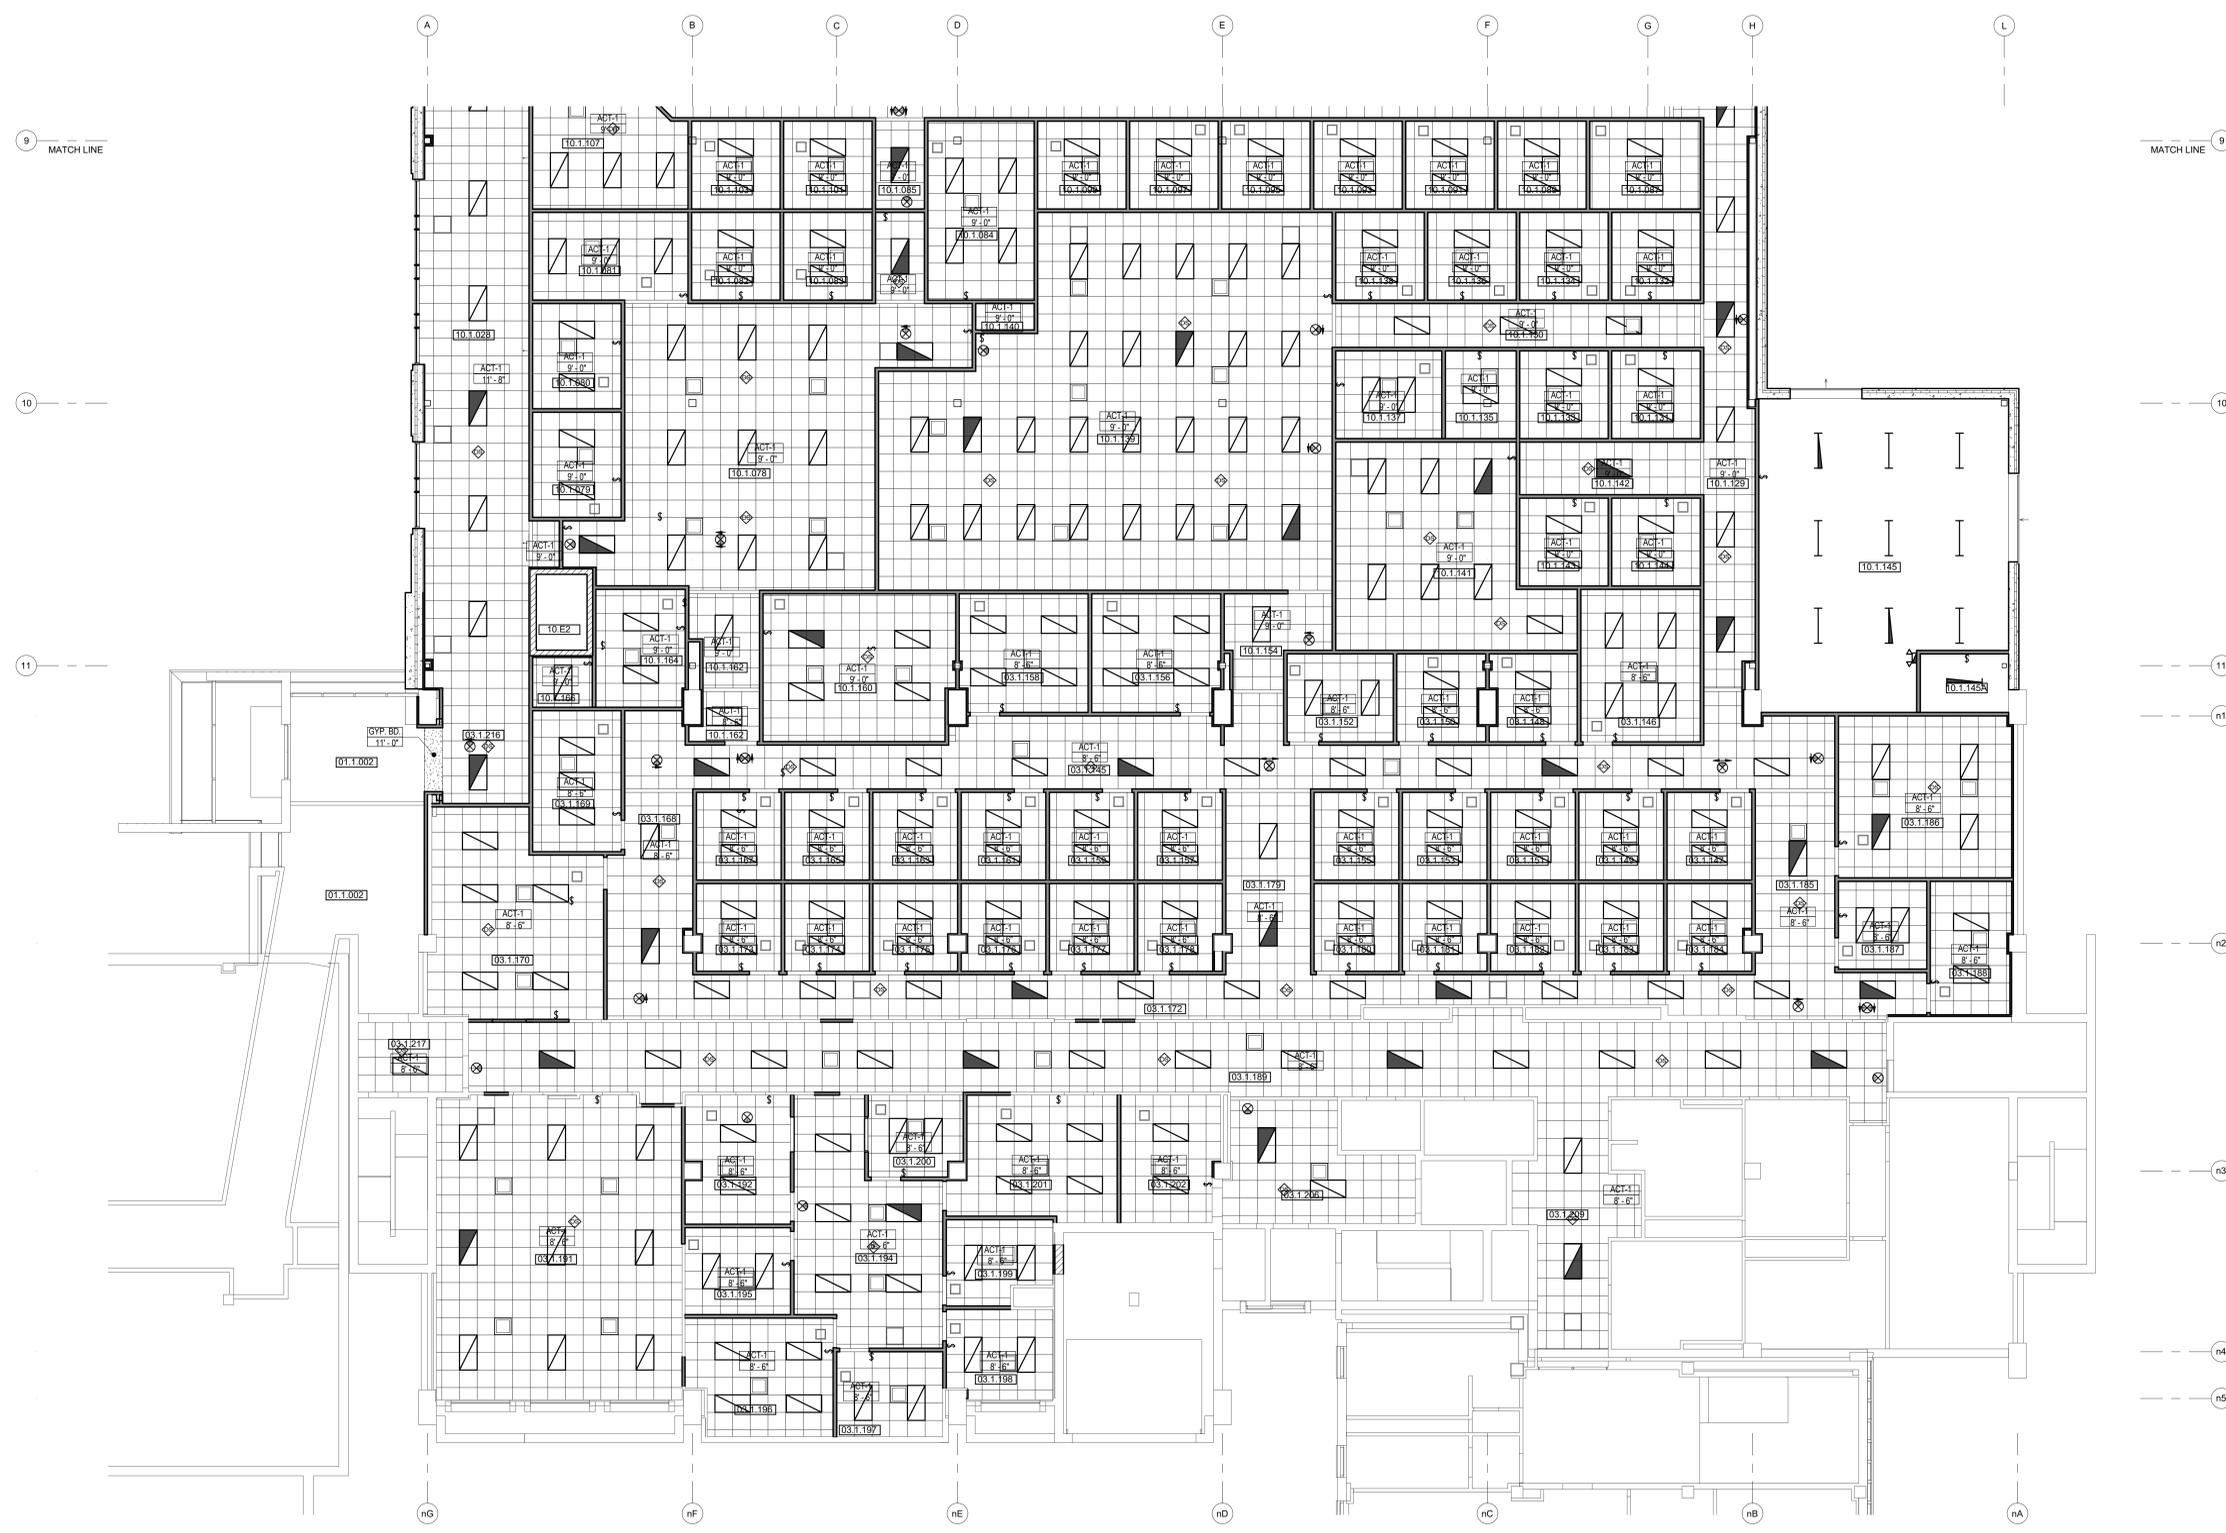

GENERAL CEILING PLAN NOTES

- SEE MECHANICAL AND ELECTRICAL DRAWINGS FOR DEVICE/FIXTURE TYPES, SIZES, INSTALLATION AND SPECIFICATIONS.
- VERIFY ALL CONDITIONS AND DIMENSIONS PRIOR TO CEILING INSTALLATION.
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CEILING PLAN LEGEND


- CEILING FINISH
- CEILING HEIGHT (A.F.F.)
- 100 ROOM NUMBER
- EXPOSED CEILING
- GYPSUM BOARD CEILING(S/OFFIT) (GYP) - SEE SPECIFICATIONS FOR ADDITIONAL INFORMATION
- ACOUSTICAL CEILING (ACT) - SEE SPECIFICATIONS FOR ADDITIONAL INFORMATION
- HVAC GRILLS - SEE HVAC PLANS
- 2x4 LAY-IN LIGHT FIXTURE
- RECESSED DOWNLIGHT FIXTURE
- SURFACE MOUNTED LINEAR LIGHT FIXTURE
- HANGING PENDANT FIXTURE

CEILING DESCRIPTIONS

- ACT-1 ACT - STANDARD
- ACT-2 VINYL COVERED GYP, ALUMINUM FRAME
- ACT-3 FULLY ACCESSIBLE WOOD PANEL CEILING SYSTEM (1/4" HORIZONTAL REVEALS) WITH 4" WOOD SUBSTRATE TRIM
- GYP GYPSUM BOARD (PAINT)

PLAN KEYED NOTES

1 ENLARGED REFLECTED CEILING PLAN
A603 1/8" = 1'-0"

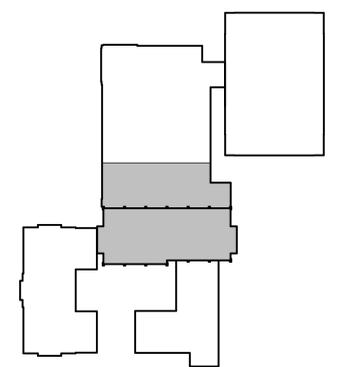

PLAN KEY
NOT TO SCALE

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NO.	DATE	REVISION



GENERAL CEILING PLAN NOTES

- SEE MECHANICAL AND ELECTRICAL DRAWINGS FOR DEVICE/FIXTURE TYPES SIZES, INSTALLATION AND SPECIFICATIONS.
- VERIFY ALL CONDITIONS AND DIMENSIONS PRIOR TO CEILING INSTALLATION.
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- CENTER IN BOTH DIRECTIONS RECESSED LIGHTS, ELECTRICAL AND MECHANICAL DEVICES AND SPRINKLER HEADS WHEN SHOWN IN CEILING TILE.
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- SEE ELECTRICAL LIGHTING PLANS FOR LIGHT FIXTURE LAYOUT AND LIGHT FIXTURE NOTES. LIGHT FIXTURES SHOWN ON THE REFLECTED CEILING PLANS ARE FOR REFERENCE ONLY.

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CEILING PLAN LEGEND


- CEILING FINISH
- CEILING HEIGHT (A.F.F.)
- ROOM NUMBER
- EXPOSED CEILING
- GYPSUM BOARD CEILING(SOFFIT) (GYP) - SEE SPECIFICATIONS FOR ADDITIONAL INFORMATION
- ACOUSTICAL CEILING (ACT) - SEE SPECIFICATIONS FOR ADDITIONAL INFORMATION
- HVAC GRILLS - SEE HVAC PLANS
- 2X4 LAY-IN LIGHT FIXTURE
- RECESSED DOWNLIGHT FIXTURE
- SURFACE MOUNTED LINEAR LIGHT FIXTURE
- HANGING PENDANT FIXTURE

CEILING DESCRIPTIONS

- ACT-1 ACT - STANDARD
- ACT-2 VINYL COVERED GYP. ALUMINUM FRAME
- ACT-3 FULLY ACCESSIBLE WOOD PANEL CEILING SYSTEM (114" HORIZONTAL REVEALS) WITH 4" WOOD SUBSTRATE TRIM
- GYP GYPSUM BOARD (PAINT)

PLAN KEYED NOTES

(X) PLAN KEYED NOTES

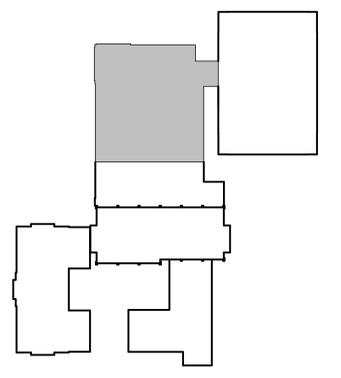

ENLARGED REFLECTED CEILING PLAN
 1/8" = 1'-0"
 NORTH


PLAN KEY
 NOT TO SCALE
 NORTH

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NO.	DATE	REVISION

ALTERATION / ADDITION
OUTAGAME COUNTY ADMINISTRATION CENTER
S. WALNUT & W. 8TH, APPLETON WI 54911
LEVEL 790.00 ENLARGED REFLECTED CEILING PLAN - OCAC NORTH

DESIGNED	DRAWN
MAG	BLG
PROJECT NO. 0002-61600160	
DATE MARCH 3, 2017	
SHEET NO. A604	

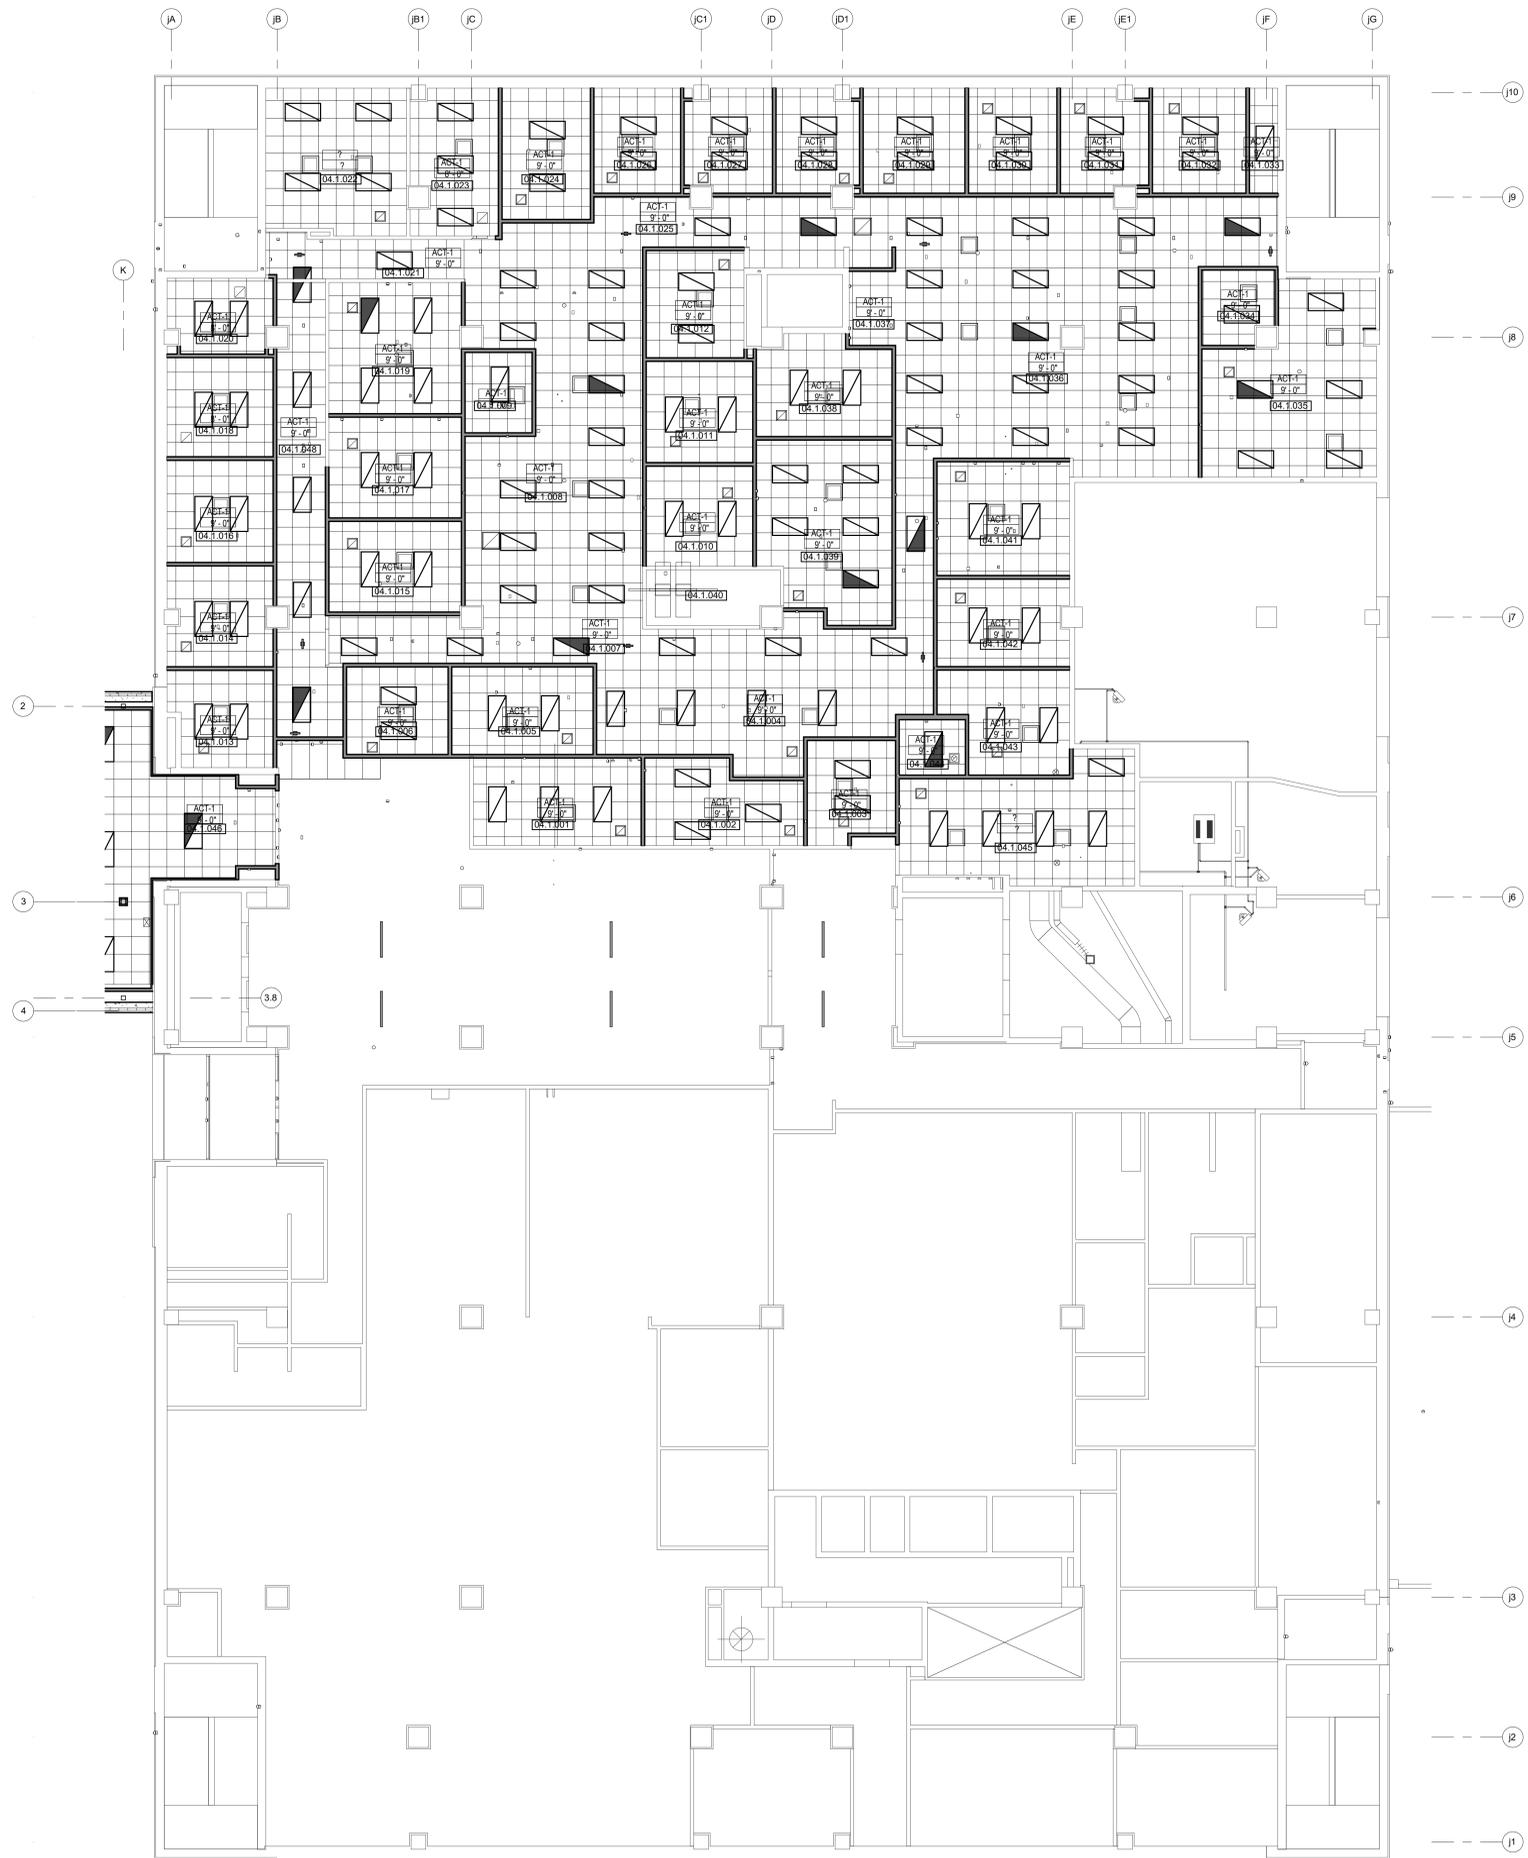

GENERAL CEILING PLAN NOTES

- SEE MECHANICAL AND ELECTRICAL DRAWINGS FOR DEVICE/FIXTURE TYPES, SIZES, INSTALLATION AND SPECIFICATIONS.
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CEILING PLAN LEGEND


- CEILING FINISH
- CEILING HEIGHT (A.F.F.)
- 100 ROOM NUMBER
- EXPOSED CEILING
- GYP. BOARD CEILING(SOFT) (GYF) - SEE SPECIFICATIONS FOR ADDITIONAL INFORMATION
- ACOUSTICAL CEILING (ACT) - SEE SPECIFICATIONS FOR ADDITIONAL INFORMATION
- HVAC GRILLS - SEE HVAC PLANS
- 2x4 LAY-IN LIGHT FIXTURE
- RECESSED DOWNLIGHT FIXTURE
- SURFACE MOUNTED LINEAR LIGHT FIXTURE
- HANGING PENDANT FIXTURE

CEILING DESCRIPTIONS

- ACT-1 ACT - STANDARD
- ACT-2 VINYL COVERED GYP., ALUMINUM FRAME
- ACT-3 FULLY ACCESSIBLE WOOD PANEL CEILING SYSTEM (1/4" HORIZONTAL REVEALS) WITH 4" WOOD SUBSTRATE TRIM
- GYP GYPSUM BOARD (PAINT)

PLAN KEYED NOTES

(X)

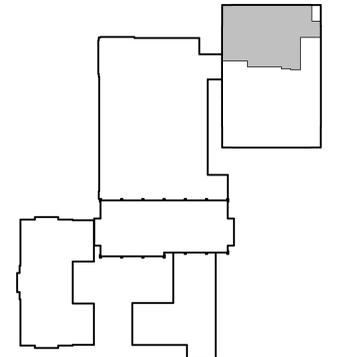

1 ENLARGED REFLECTED CEILING PLAN
A605 1/8" = 1'-0"



PLAN KEY
NOT TO SCALE



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NO.	DATE	REVISION

ALTERATION / ADDITION
OUTAGAME COUNTY ADMINISTRATION CENTER
S. WALNUT & W. 8TH, APPLETON WI 54911
LEVEL 790.00 ENLARGED REFLECTED CEILING PLAN - JUSTICE CENTER

DESIGNED MAG	DRAWN BLG
PROJECT NO. 0002-61600160	
DATE MARCH 3, 2017	
SHEET NO.	



GENERAL CEILING PLAN NOTES

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CEILING PLAN LEGEND

- CEILING FINISH
- CEILING HEIGHT (A.F.F.)
- 100 ROOM NUMBER
- EXPOSED CEILING
- GYPSUM BOARD CEILING/SOFFIT (GYP) - SEE SPECIFICATIONS FOR ADDITIONAL INFORMATION
- ACOUSTICAL CEILING (ACT) - SEE SPECIFICATIONS FOR ADDITIONAL INFORMATION
- ⊠ HVAC GRILLS - SEE HVAC PLANS
- 2x4 LAY-IN LIGHT FIXTURE
- RECESSED DOWNLIGHT FIXTURE
- SURFACE MOUNTED LINEAR LIGHT FIXTURE
- HANGING PENDANT FIXTURE


CEILING DESCRIPTIONS

- ACT-1 ACT - STANDARD
- ACT-2 VINYL COVERED GYP, ALUMINUM FRAME
- ACT-3 FULLY ACCESSIBLE WOOD PANEL CEILING SYSTEM (1/4" HORIZONTAL REVEALS) WITH 4" WOOD SUBSTRATE TRIM
- GYP GYPSUM BOARD (PAINT)

PLAN KEYED NOTES

1 ENLARGED REFLECTED CEILING PLAN

A606 1/8" = 1'-0"

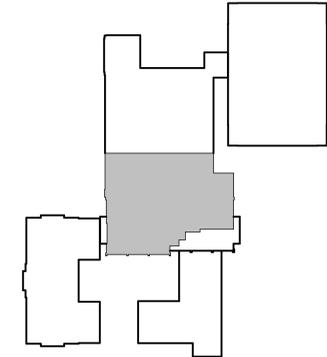

PLAN KEY
NOT TO SCALE




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NO.	DATE	REVISION

ALTERATION / ADDITION
OUTAGAME COUNTY ADMINISTRATION CENTER
S. WALNUT & W. 8TH, APPLETON WI 54911
LEVEL 805.00 ENLARGED REFLECTED CEILING PLAN - HHS NORTH/OCAC SOUTH

DESIGNED MAG	DRAWN BLG
PROJECT NO. 0002-61600160	
DATE MARCH 3, 2017	
SHEET NO. A606	

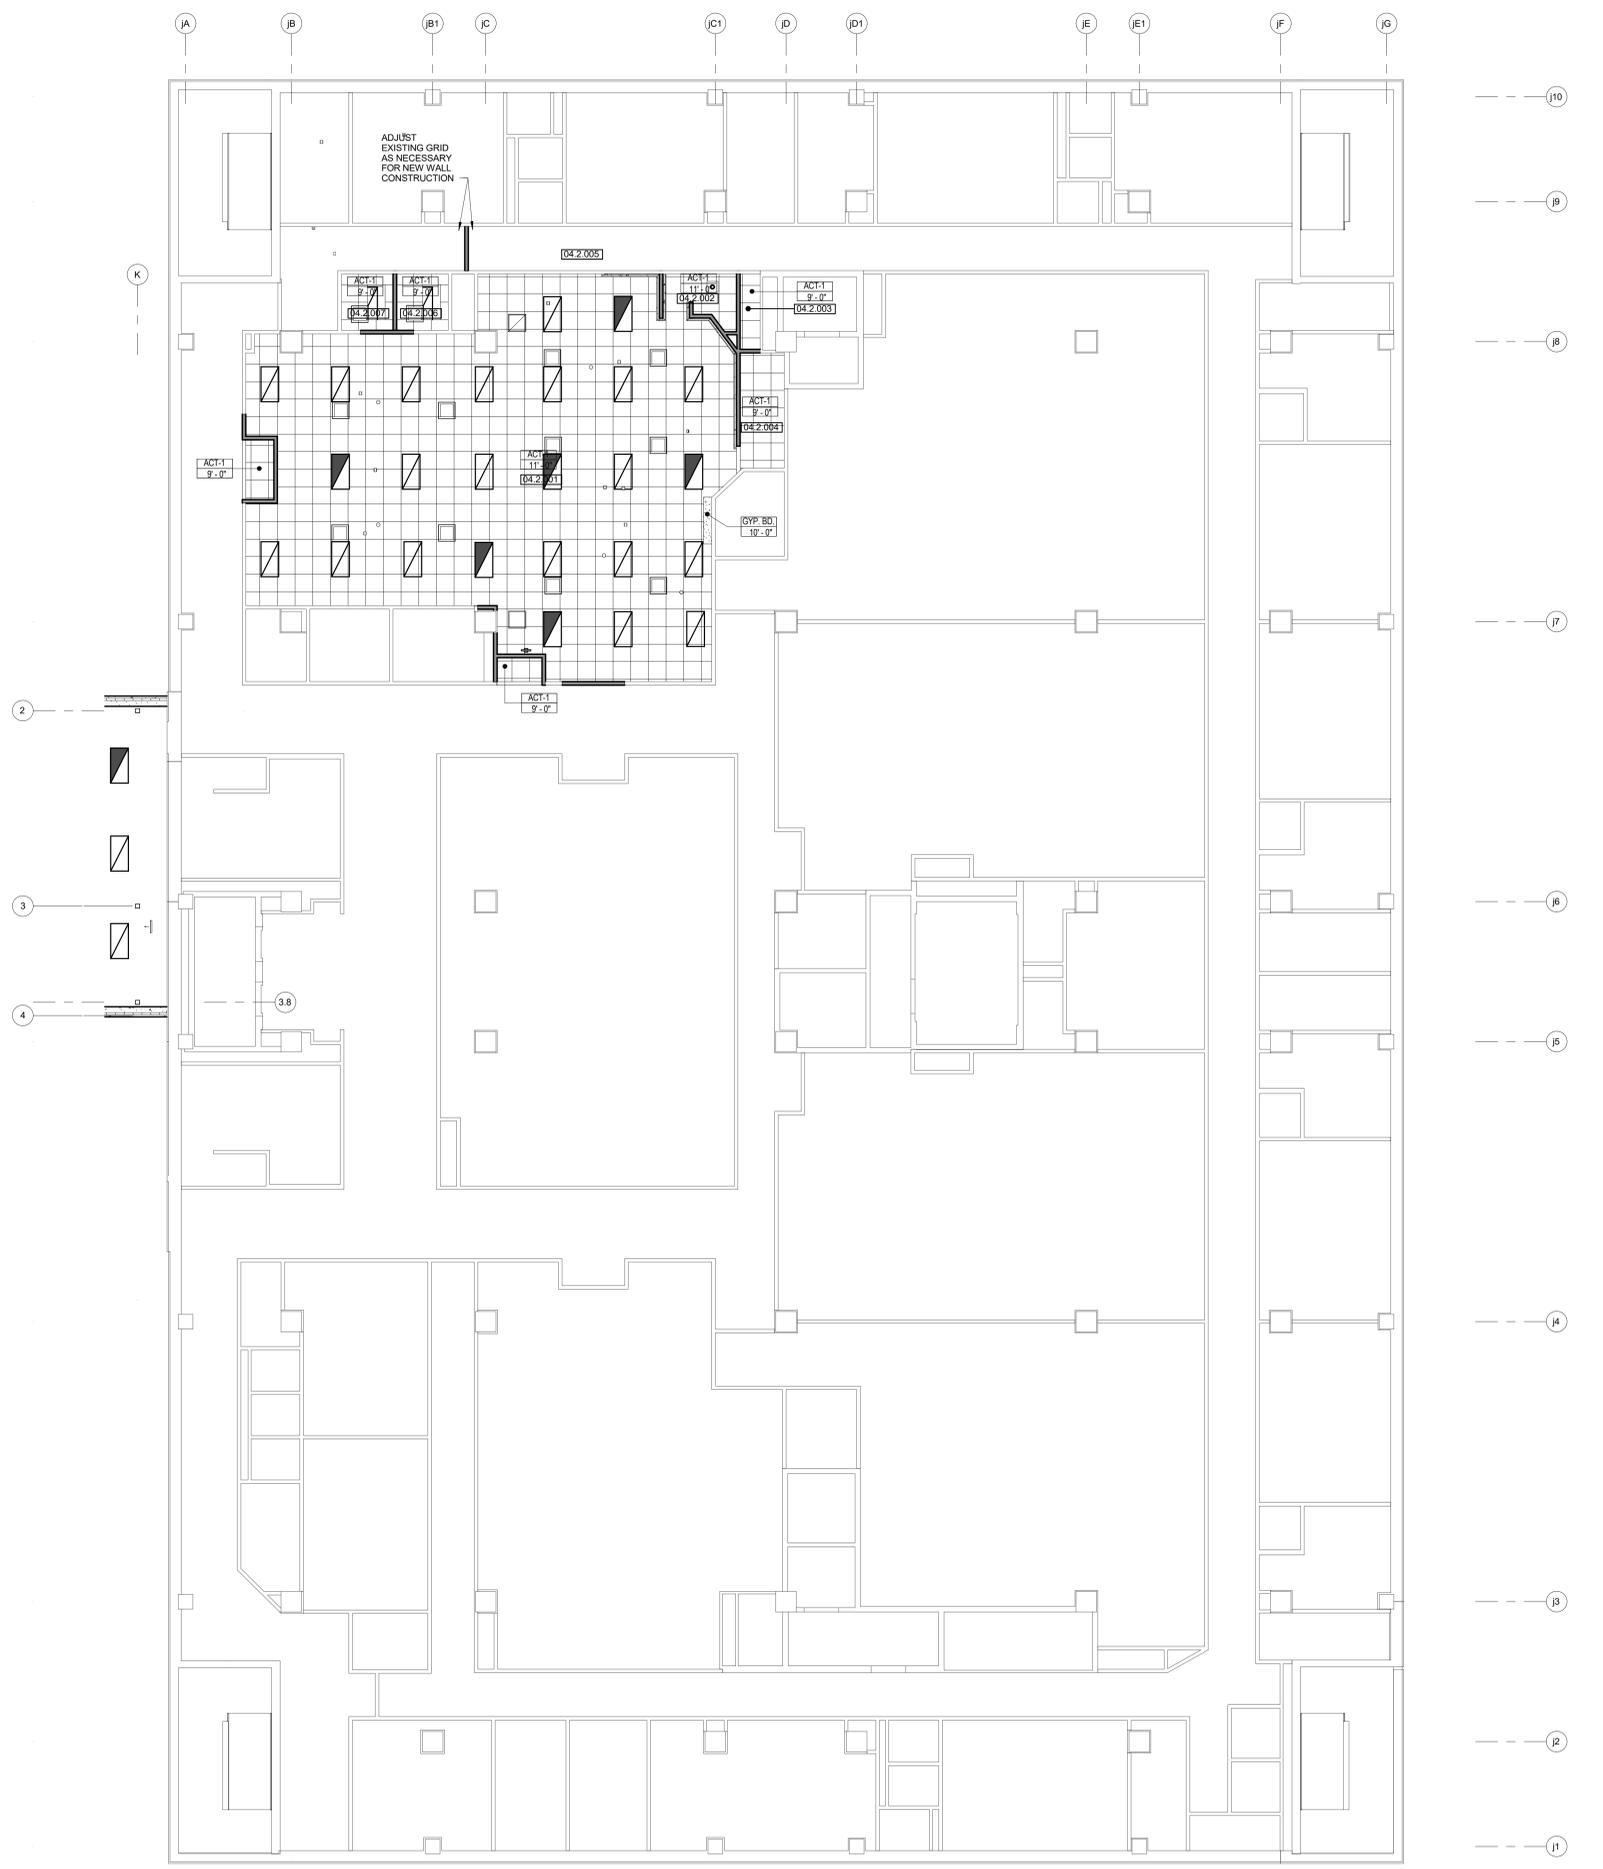

GENERAL CEILING PLAN NOTES

- SEE MECHANICAL AND ELECTRICAL DRAWINGS FOR DEVICE/FIXTURE TYPES SIZES, INSTALLATION AND SPECIFICATIONS.
- VERIFY ALL CONDITIONS AND DIMENSIONS PRIOR TO CEILING INSTALLATION.
- CEILING PLAN SHOWS DESIGN INTENT ONLY. REFER TO SPECIFICATIONS AS WELL AS MECHANICAL AND ELECTRICAL DRAWINGS FOR DEVICES, TYPES AND INSTALLATION. DEVICES SHOWN ON ARCHITECTURAL PLAN AND NOT ON THE ENGINEERING DRAWINGS OR SPECIFICATIONS SHOULD BE BROUGHT TO ARCHITECTS ATTENTION FOR CLARIFICATION.
- ACOUSTICAL CEILING GRID SHALL BE CENTERED IN ROOMS UNLESS NOTED OTHERWISE.
- CEILING HEIGHTS ARE DIMENSIONED FROM FINISH FLOOR LINE TO DESIGN ELEVATION OF FINISHED CEILING UNLESS NOTED OTHERWISE.
- CENTER IN BOTH DIRECTIONS RECESSED LIGHTS, ELECTRICAL AND MECHANICAL DEVICES AND SPRINKLER HEADS WHEN SHOWN IN CEILING TILE.
- MECHANICAL PLUMBING AND ELECTRICAL CONTRACTORS SHALL COORDINATE DEVICES REQUIRING ACCESS IN NON ACCESSIBLE CEILING. PROVIDE ACCESS PANELS AS NEEDED (EXAMPLE: MECHANICAL VAV BOXES, PLUMBING CLEANOUTS, ETC.).
- SEE ELECTRICAL LIGHTING PLANS FOR LIGHT FIXTURE LAYOUT AND LIGHT FIXTURE NOTES. LIGHT FIXTURES SHOWN ON THE REFLECTED CEILING PLANS ARE FOR REFERENCE ONLY.

CEILING HEIGHTS SHOWN ARE ESTIMATES OF WHAT CAN BE ACCOMPLISHED. MECHANICAL EQUIPMENT MAY NECESSITATE A CHANGE TO THESE HEIGHTS. VERIFY FEASIBLE CEILING HEIGHTS AND DISCUSS NECESSARY CHANGES WITH THE ARCHITECT PRIOR TO INSTALLATION OF SYSTEMS ABOVE CEILING.

CEILING PLAN LEGEND


- CEILING FINISH
- CEILING HEIGHT (A.F.F.)
- ROOM NUMBER
- EXPOSED CEILING
- GYPSUM BOARD CEILING/SOFFIT (GYP) - SEE SPECIFICATIONS FOR ADDITIONAL INFORMATION
- ACOUSTICAL CEILING (ACT) - SEE SPECIFICATIONS FOR ADDITIONAL INFORMATION
- HVAC GRILLS - SEE HVAC PLANS
- 2x4 LAY-IN LIGHT FIXTURE
- RECESSED DOWNLIGHT FIXTURE
- SURFACE MOUNTED LINEAR LIGHT FIXTURE
- HANGING PENDANT FIXTURE

CEILING DESCRIPTIONS

- ACT-1 ACT - STANDARD
- ACT-2 VINYL COVERED GYP., ALUMINUM FRAME
- ACT-3 FULLY ACCESSIBLE WOOD PANEL CEILING SYSTEM (11/4" HORIZONTAL REVEALS) WITH 4" WOOD SUBSTRATE TRIM
- GYP GYPSUM BOARD (PAINT)

PLAN KEYED NOTES

(X)

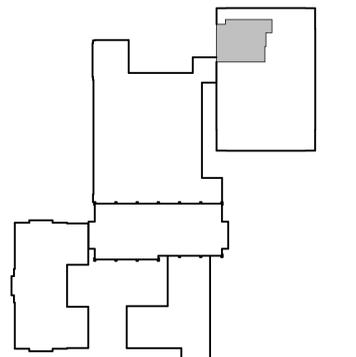

1
A608 1/8" = 1'-0" ENLARGED REFLECTED CEILING PLAN

PLAN KEY
NOT TO SCALE

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NO.	DATE	REVISION

GENERAL CEILING PLAN NOTES

- SEE MECHANICAL AND ELECTRICAL DRAWINGS FOR DEVICE/FIXTURE TYPES, SIZES, INSTALLATION AND SPECIFICATIONS.
- VERIFY ALL CONDITIONS AND DIMENSIONS PRIOR TO CEILING INSTALLATION.
- CEILING PLAN SHOWS DESIGN INTENT ONLY, REFER TO SPECIFICATIONS AS WELL AS MECHANICAL AND ELECTRICAL DRAWINGS FOR DEVICES, TYPES AND INSTALLATION. DEVICES SHOWN ON ARCHITECTURAL PLAN AND NOT ON THE ENGINEERING DRAWINGS OR SPECIFICATIONS SHOULD BE BROUGHT TO ARCHITECTS ATTENTION FOR CLARIFICATION.
- ACOUSTICAL CEILING GRID SHALL BE CENTERED IN ROOMS UNLESS NOTED OTHERWISE.
- CEILING HEIGHTS ARE DIMENSIONED FROM FINISH FLOOR LINE TO DESIGN ELEVATION OF FINISHED CEILING UNLESS NOTED OTHERWISE.
- CENTER IN BOTH DIRECTIONS RECESSED LIGHTS, ELECTRICAL AND MECHANICAL DEVICES AND SPRINKLER HEADS WHEN SHOWN IN CEILING TILE.
- MECHANICAL, PLUMBING AND ELECTRICAL CONTRACTORS SHALL COORDINATE DEVICES REQUIRING ACCESS IN NON ACCESSIBLE CEILING. PROVIDE ACCESS PANELS AS NEEDED (EXAMPLE: MECHANICAL VAV BOXES, PLUMBING CLEANOUTS, ETC.).
- SEE ELECTRICAL LIGHTING PLANS FOR LIGHT FIXTURE LAYOUT AND LIGHT FIXTURE NOTES. LIGHT FIXTURES SHOWN ON THE REFLECTED CEILING PLANS ARE FOR REFERENCE ONLY.

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CEILING PLAN LEGEND

- CEILING FINISH
- CEILING HEIGHT (A.F.F.)
- 100 ROOM NUMBER
- EXPOSED CEILING
- GYPSUM BOARD CEILING/SOFFIT (GYP) - SEE SPECIFICATIONS FOR ADDITIONAL INFORMATION
- ACOUSTICAL CEILING (ACT) - SEE SPECIFICATIONS FOR ADDITIONAL INFORMATION
- ⊠ HVAC GRILLS - SEE HVAC PLANS
- 2x4 LAY-IN LIGHT FIXTURE
- RECESSED DOWNLIGHT FIXTURE
- SURFACE MOUNTED LINEAR LIGHT FIXTURE
- HANGING PENDANT FIXTURE


CEILING DESCRIPTIONS

- ACT-1 ACT - STANDARD
- ACT-2 VINYL COVERED GYP., ALUMINUM FRAME
- ACT-3 FULLY ACCESSIBLE WOOD PANEL CEILING SYSTEM (1/4" HORIZONTAL REVEALS) WITH 4" WOOD SUBSTRATE TRIM
- GYP GYPSUM BOARD (PAINT)

PLAN KEYED NOTES



ENLARGED REFLECTED CEILING PLAN
A609 1/8" = 1'-0"

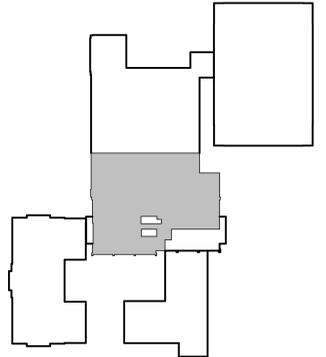


PLAN KEY
NOT TO SCALE



NO.	DATE	REVISION

ALTERATION / ADDITION
OUTAGAME COUNTY ADMINISTRATION CENTER
 S. WALNUT & W. 8TH, APPLETON WI 54911
 LEVEL 820.00 ENLARGED REFLECTED CEILING PLAN - HHS NORTH/OCAC SOUTH

DESIGNED MAG	DRAWN BLG
PROJECT NO. 0002-61600160	
DATE MARCH 3, 2017	
SHEET NO. A609	

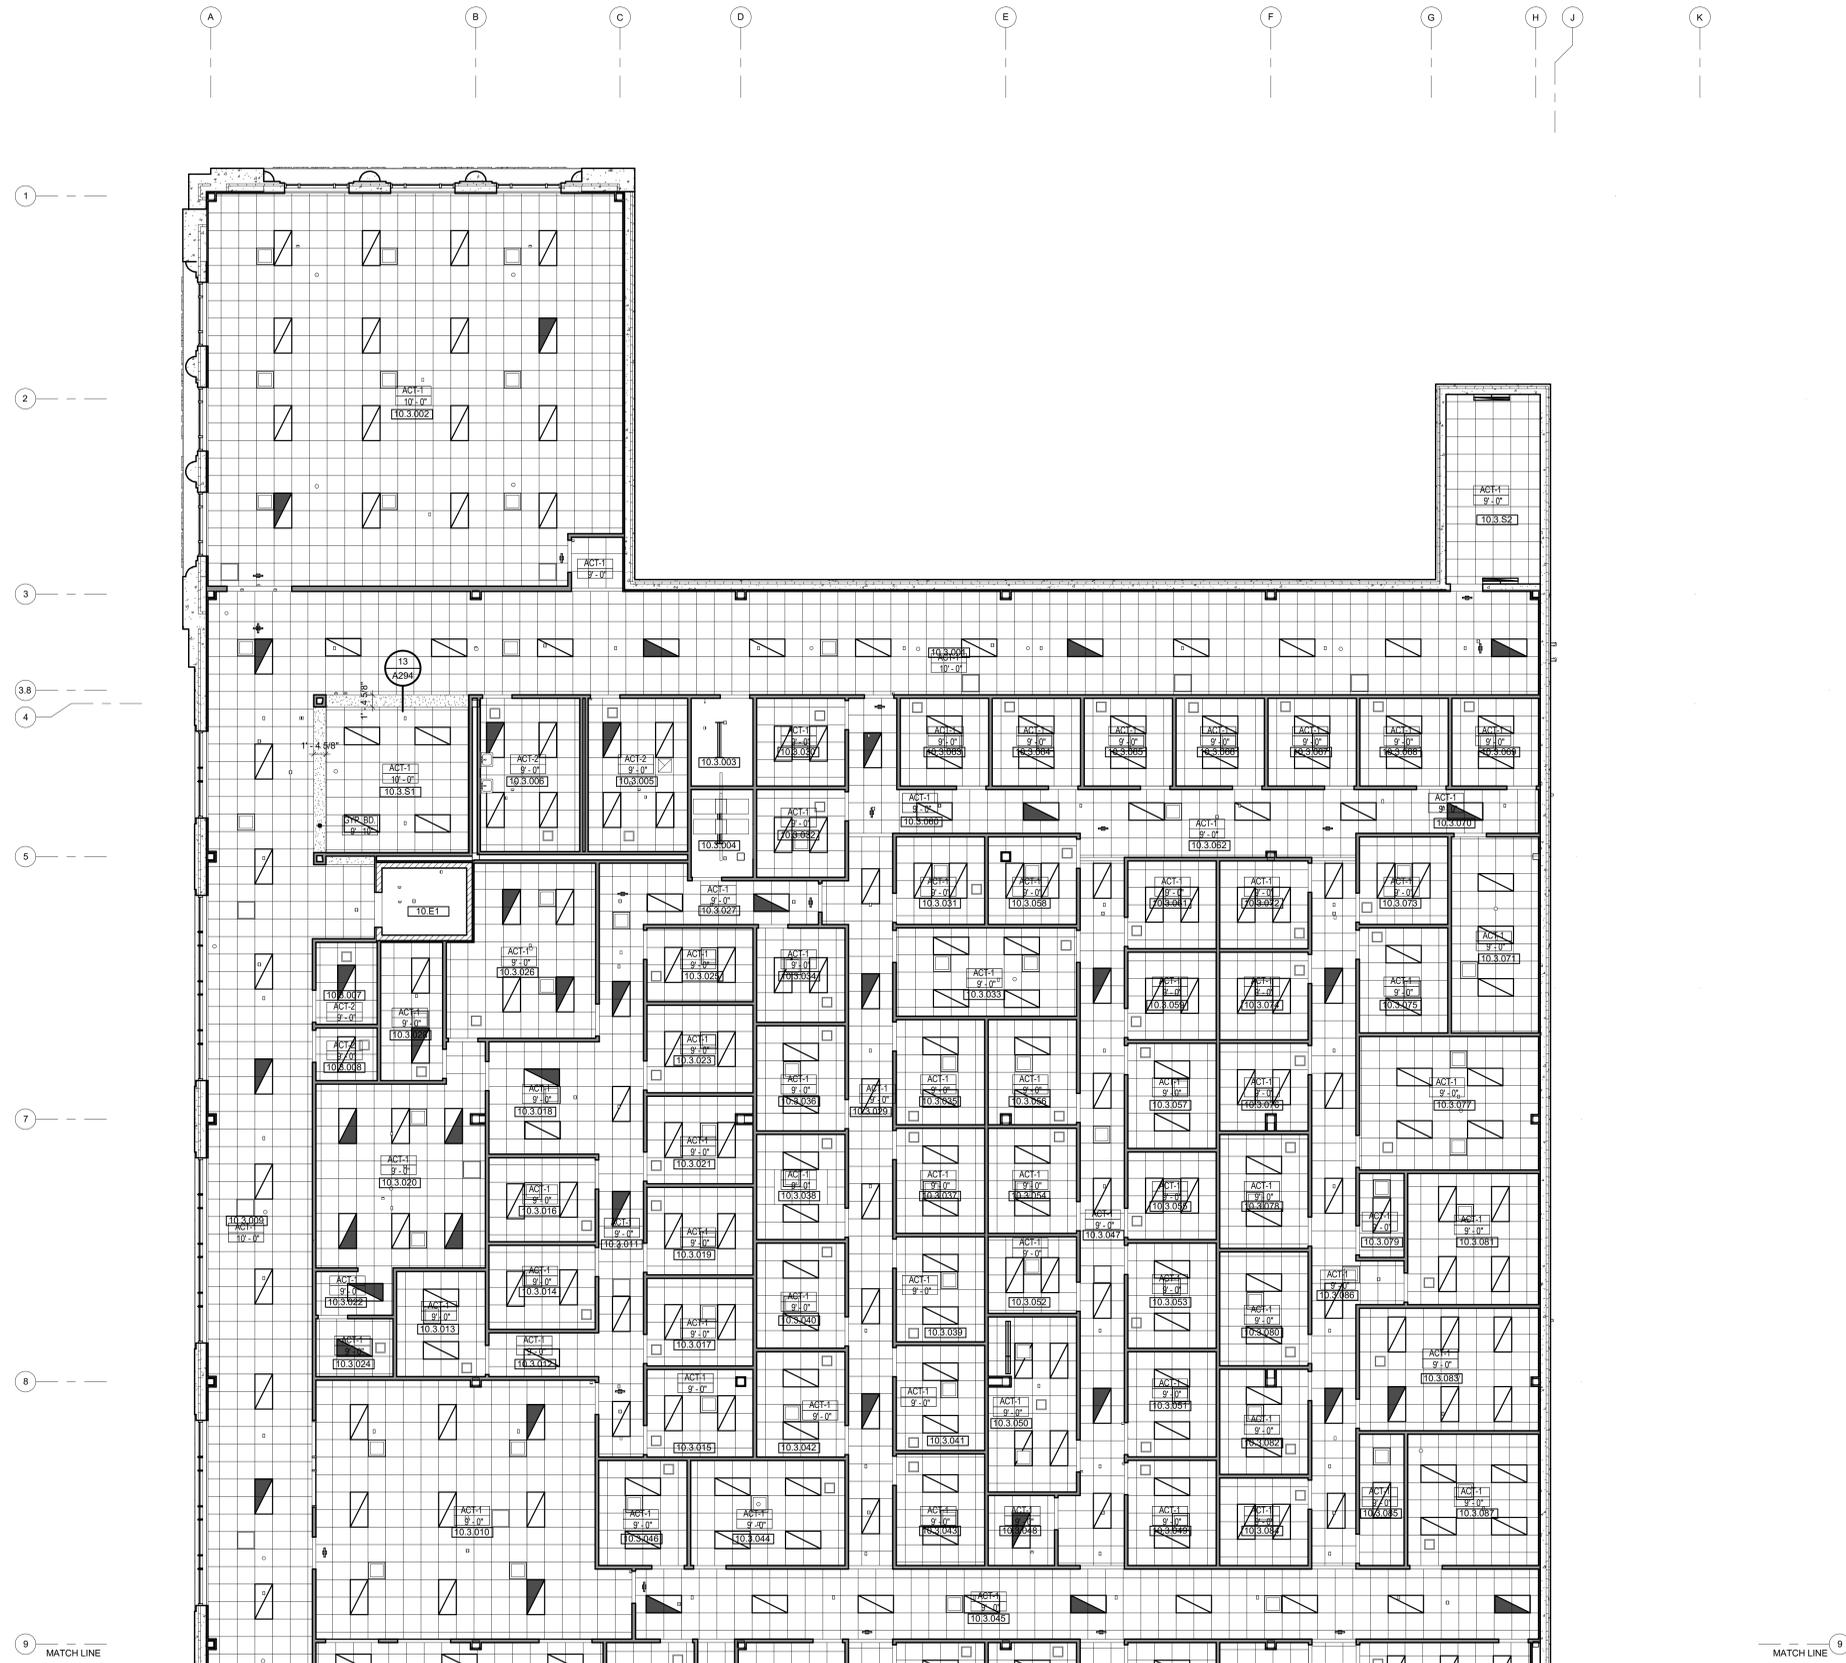

GENERAL CEILING PLAN NOTES

- SEE MECHANICAL AND ELECTRICAL DRAWINGS FOR DEVICE/FIXTURE TYPES, SIZES, INSTALLATION AND SPECIFICATIONS.
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CEILING PLAN LEGEND


- CEILING FINISH
- CEILING HEIGHT (A.F.F.)
- ROOM NUMBER
- EXPOSED CEILING
- GYPSUM BOARD CEILING/SOFFIT (GYP) - SEE SPECIFICATIONS FOR ADDITIONAL INFORMATION
- ACOUSTICAL CEILING (ACT) - SEE SPECIFICATIONS FOR ADDITIONAL INFORMATION
- HVAC GRILLS - SEE HVAC PLANS
- 2x4 LAY-IN LIGHT FIXTURE
- RECESSED DOWNLIGHT FIXTURE
- SURFACE MOUNTED LINEAR LIGHT FIXTURE
- HANGING PENDANT FIXTURE

CEILING DESCRIPTIONS

- ACT-1 ACT - STANDARD
- ACT-2 VINYL COVERED GYP, ALUMINUM FRAME
- ACT-3 FULLY ACCESSIBLE WOOD PANEL CEILING SYSTEM (1/4" HORIZONTAL REVEALS) WITH 4" WOOD SUBSTRATE TRIM
- GYP GYPSUM BOARD (PAINT)

PLAN KEYED NOTES


(X) PLAN KEYED NOTES

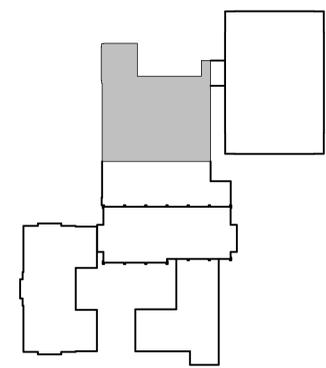


ENLARGED REFLECTED CEILING PLAN
1/8" = 1'-0"

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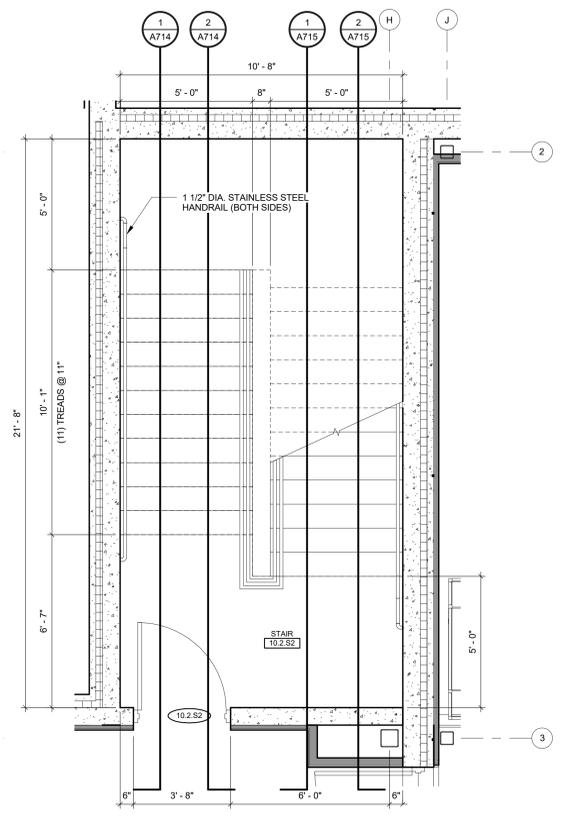
NO.	DATE	REVISION

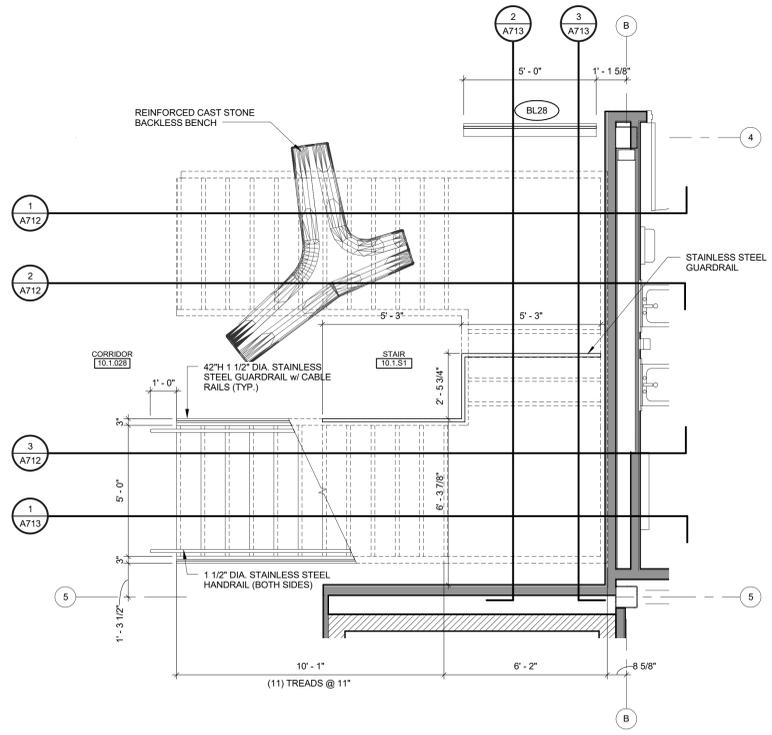


1 STAIR PLAN - 10.1.S1
A711 3/8" = 1'-0"

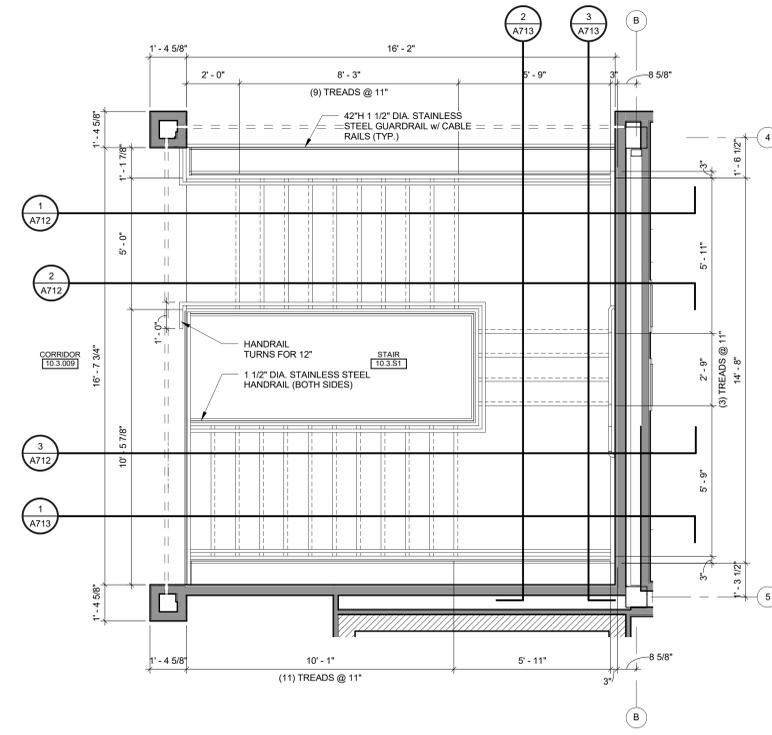


3 STAIR PLAN - 10.3.S1
A711 3/8" = 1'-0"




5 STAIR PLAN - 10.2.S2
A711 3/8" = 1'-0"

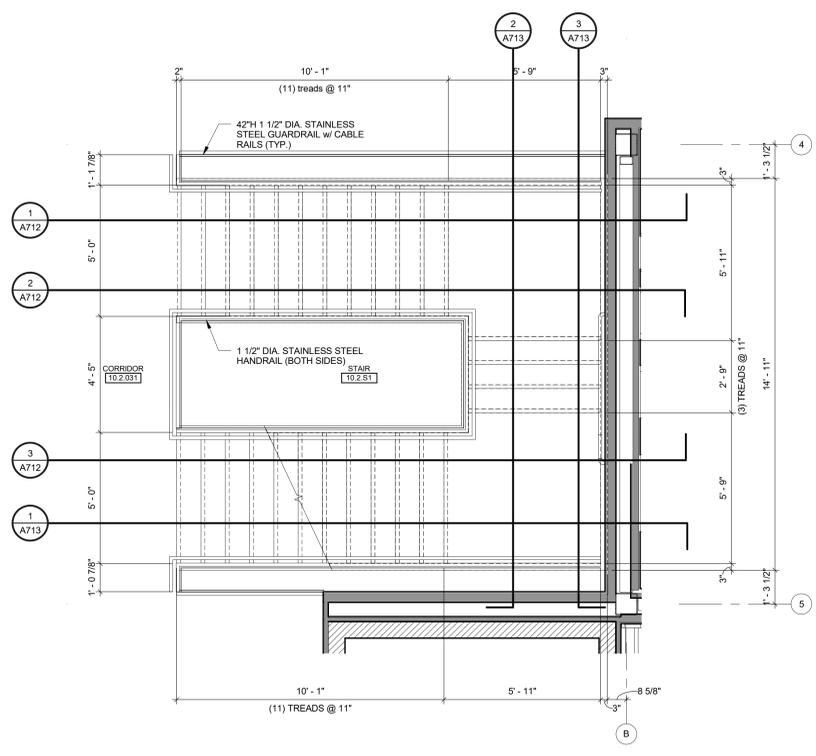

2 STAIR PLAN - 10.2.S1
A711 3/8" = 1'-0"

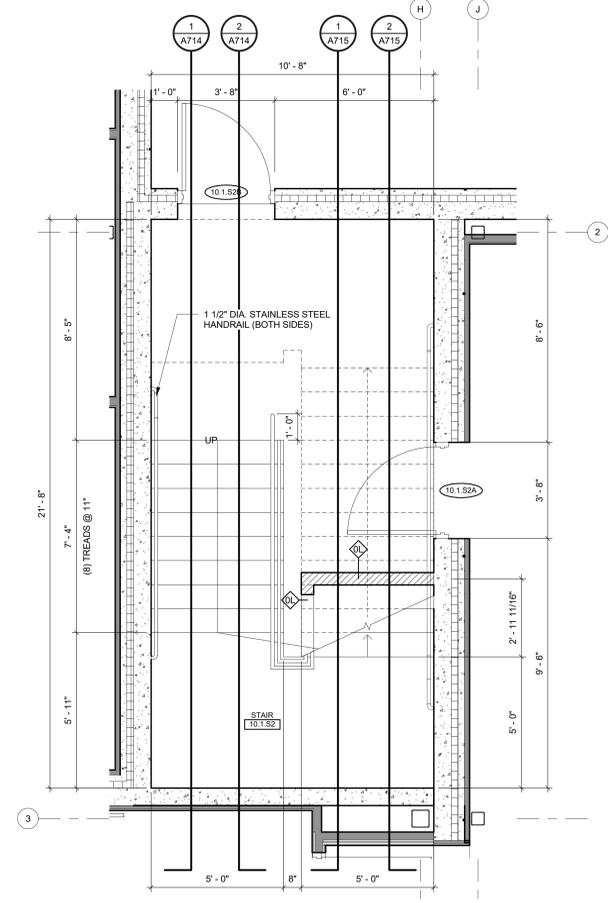

4 STAIR PLAN - 10.1.S2
A711 3/8" = 1'-0"

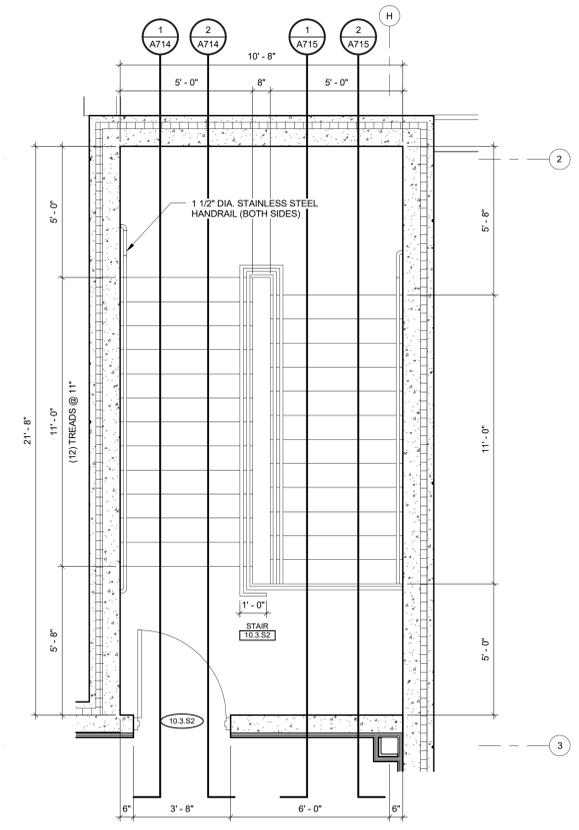


6 STAIR PLAN - 10.3.S2
A711 3/8" = 1'-0"

McMAHON
ENGINEERS ARCHITECTS
McMAHON ARCHITECTS
1025 NEENAH, WI 54957-0025
TEL: (920) 751-4200 FAX: (920) 751-4284
WWW.MCMGIP.COM


NO.	DATE	REVISION

DESIGNED BY: ASF
DRAWN BY: BLG
PROJECT NO.: 0002-61600160
DATE: MARCH 3, 2017
SHEET NO.: A711


ALTERATION / ADDITION
OUTAGAME COUNTY ADMINISTRATION CENTER
S. WALNUT & W. 8TH, APPLETON WI 54911
STAIR PLANS

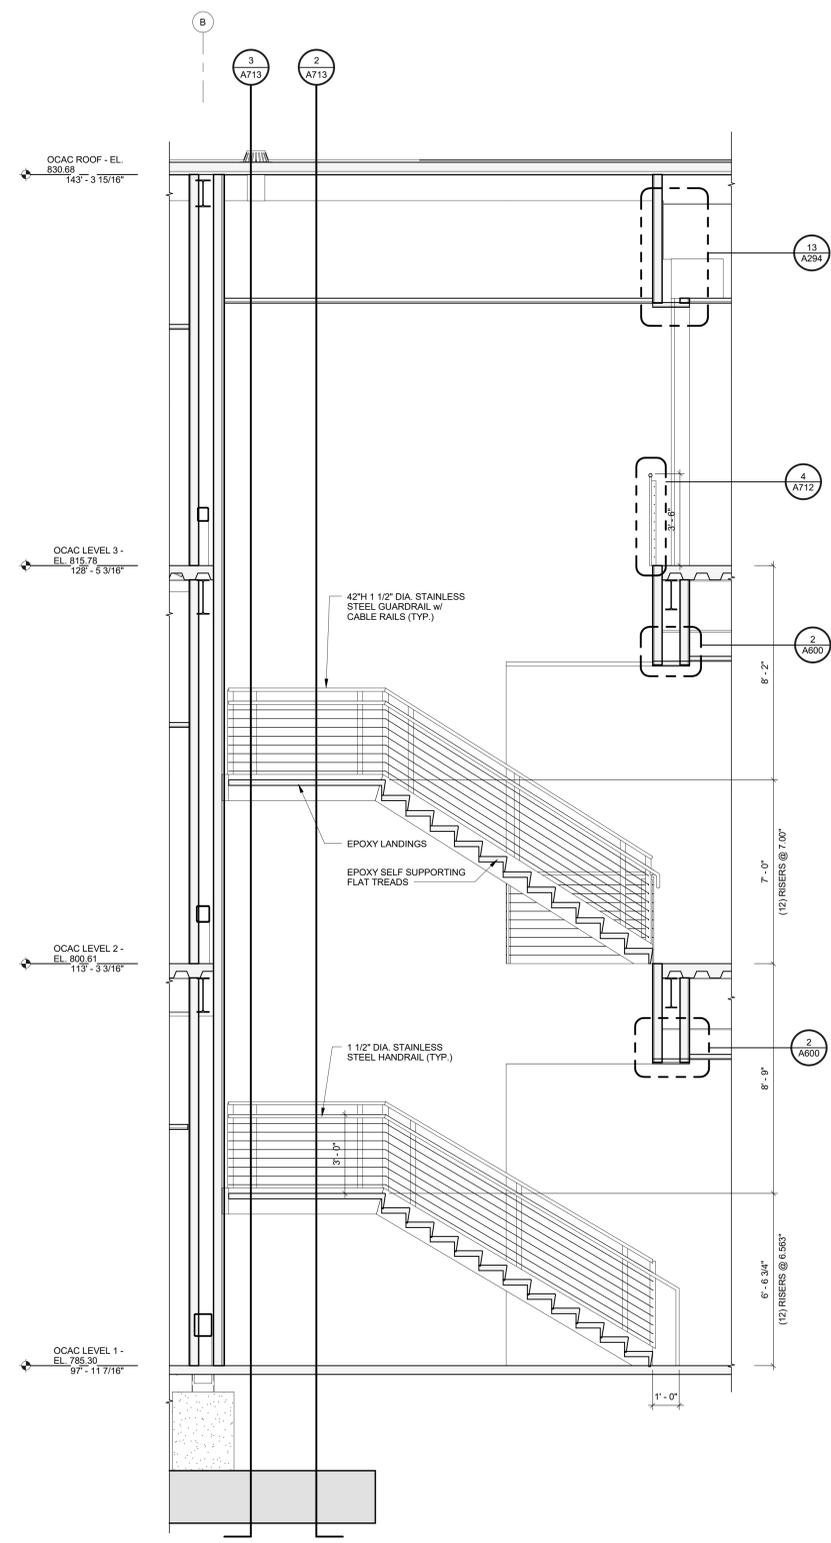

1 STAIR SECTION - 10.S1
A713 3/8" = 1'-0"

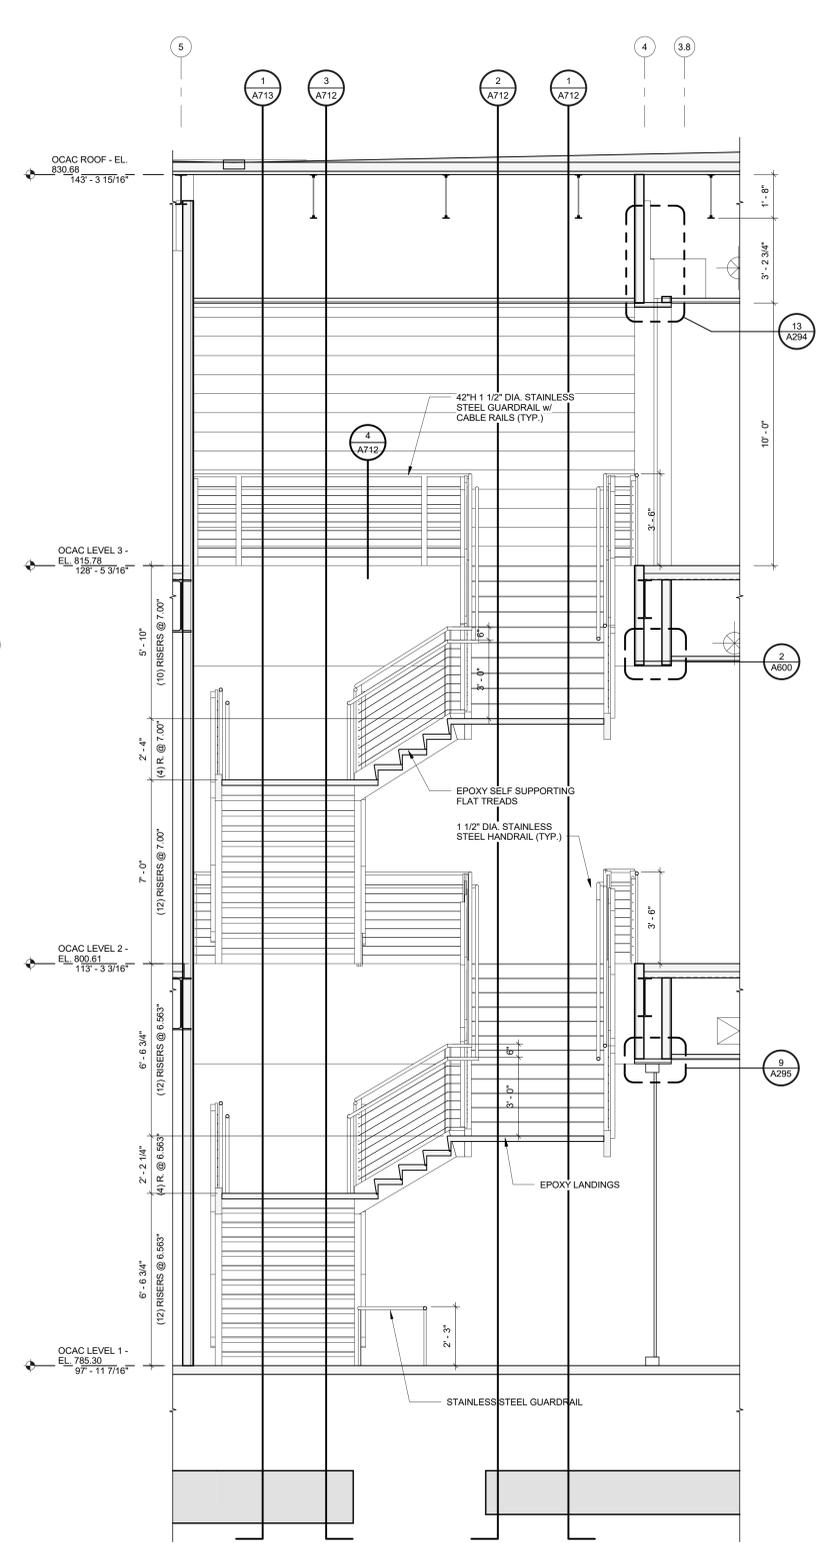

2 STAIR SECTION - 10.S1
A713 3/8" = 1'-0"

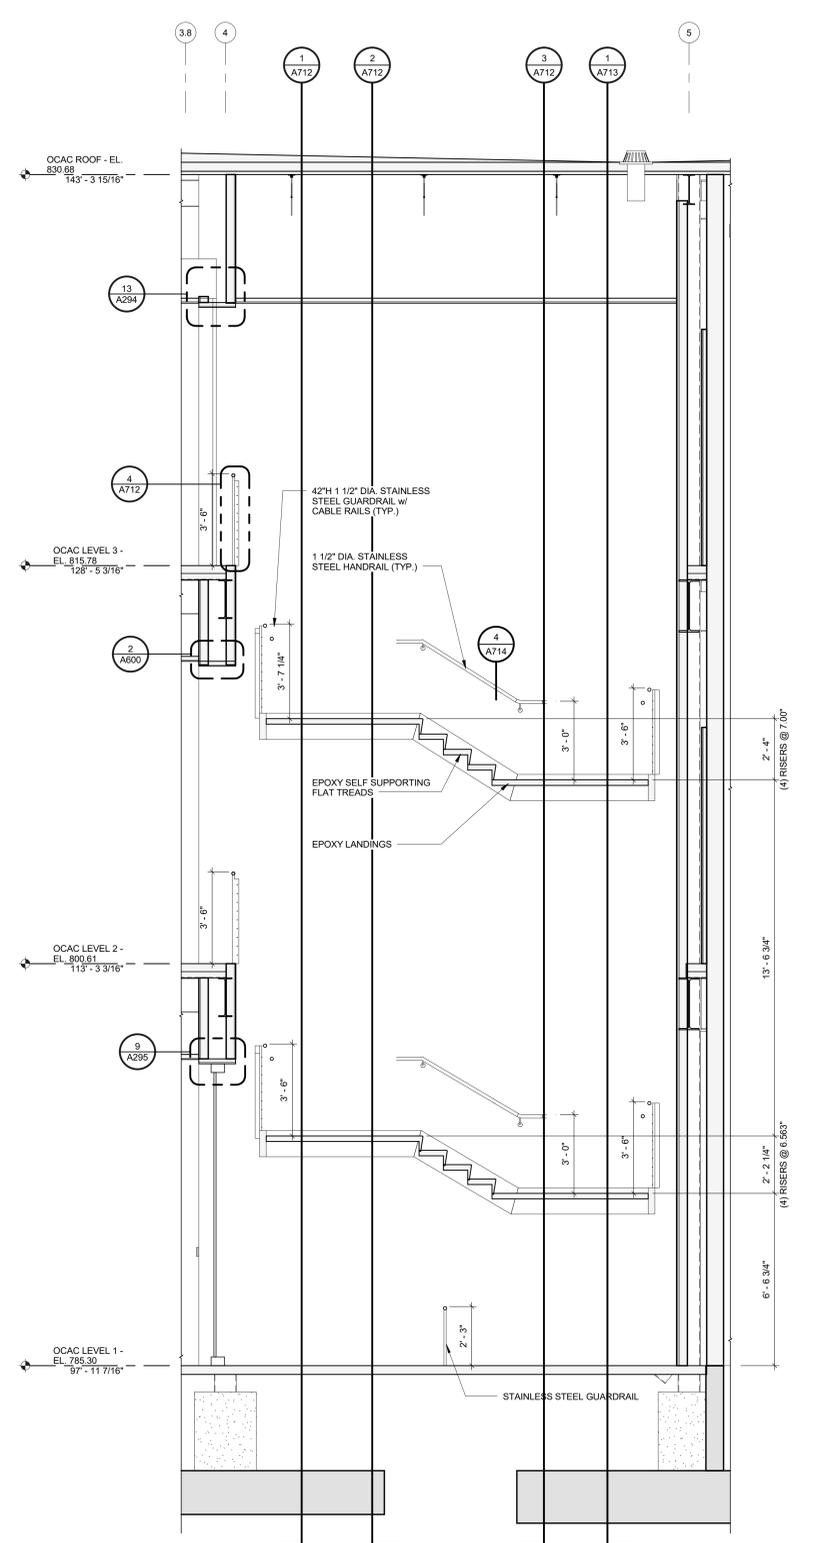

3 STAIR SECTION - 10.S1
A713 3/8" = 1'-0"


ALL EXPOSED STEEL THAT IS PART OF THE OPEN STAIR ASSEMBLY TO BE ARCHITECTURALLY FINISHED PER SPECIFICATION SECTION 05 12 13.00 PAINT PER INTERIOR PAINT SPECIFICATION.

McMahon provides this drawing as a representation of service. All drawings are the property of McMahon. The client agrees to indemnify McMahon for any and all claims, damages, costs, and expenses, including reasonable attorneys' fees, arising out of or from the use of this drawing, whether or not such claims, damages, costs, and expenses are caused in whole or in part by the negligence of McMahon.


NO.	DATE	REVISION

ALTERATION / ADDITION
OUTAGAME COUNTY ADMINISTRATION CENTER
S. WALNUT & W. 8TH, APPLETON WI 54911
STAIR SECTIONS


DESIGNED ASF	DRAWN BLG
PROJECT NO. 0002-61600160	
DATE MARCH 3, 2017	
SHEET NO. A713	

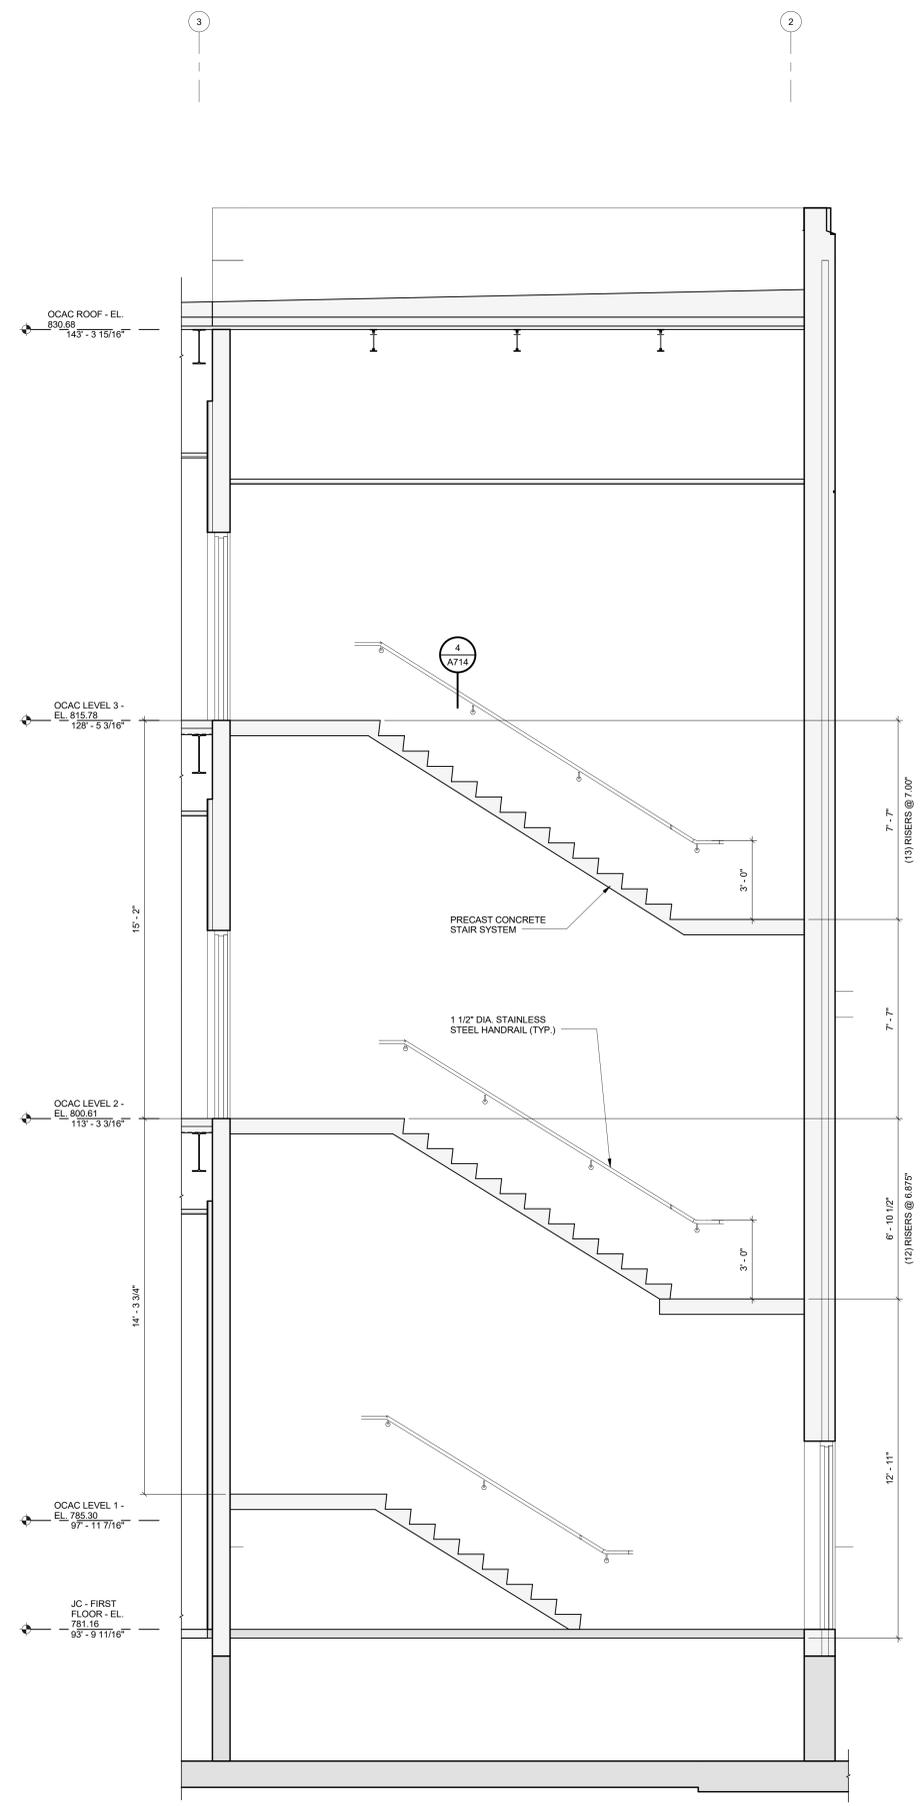


1 STAIR SECTION - 10.S2
A714 3/8" = 1'-0"

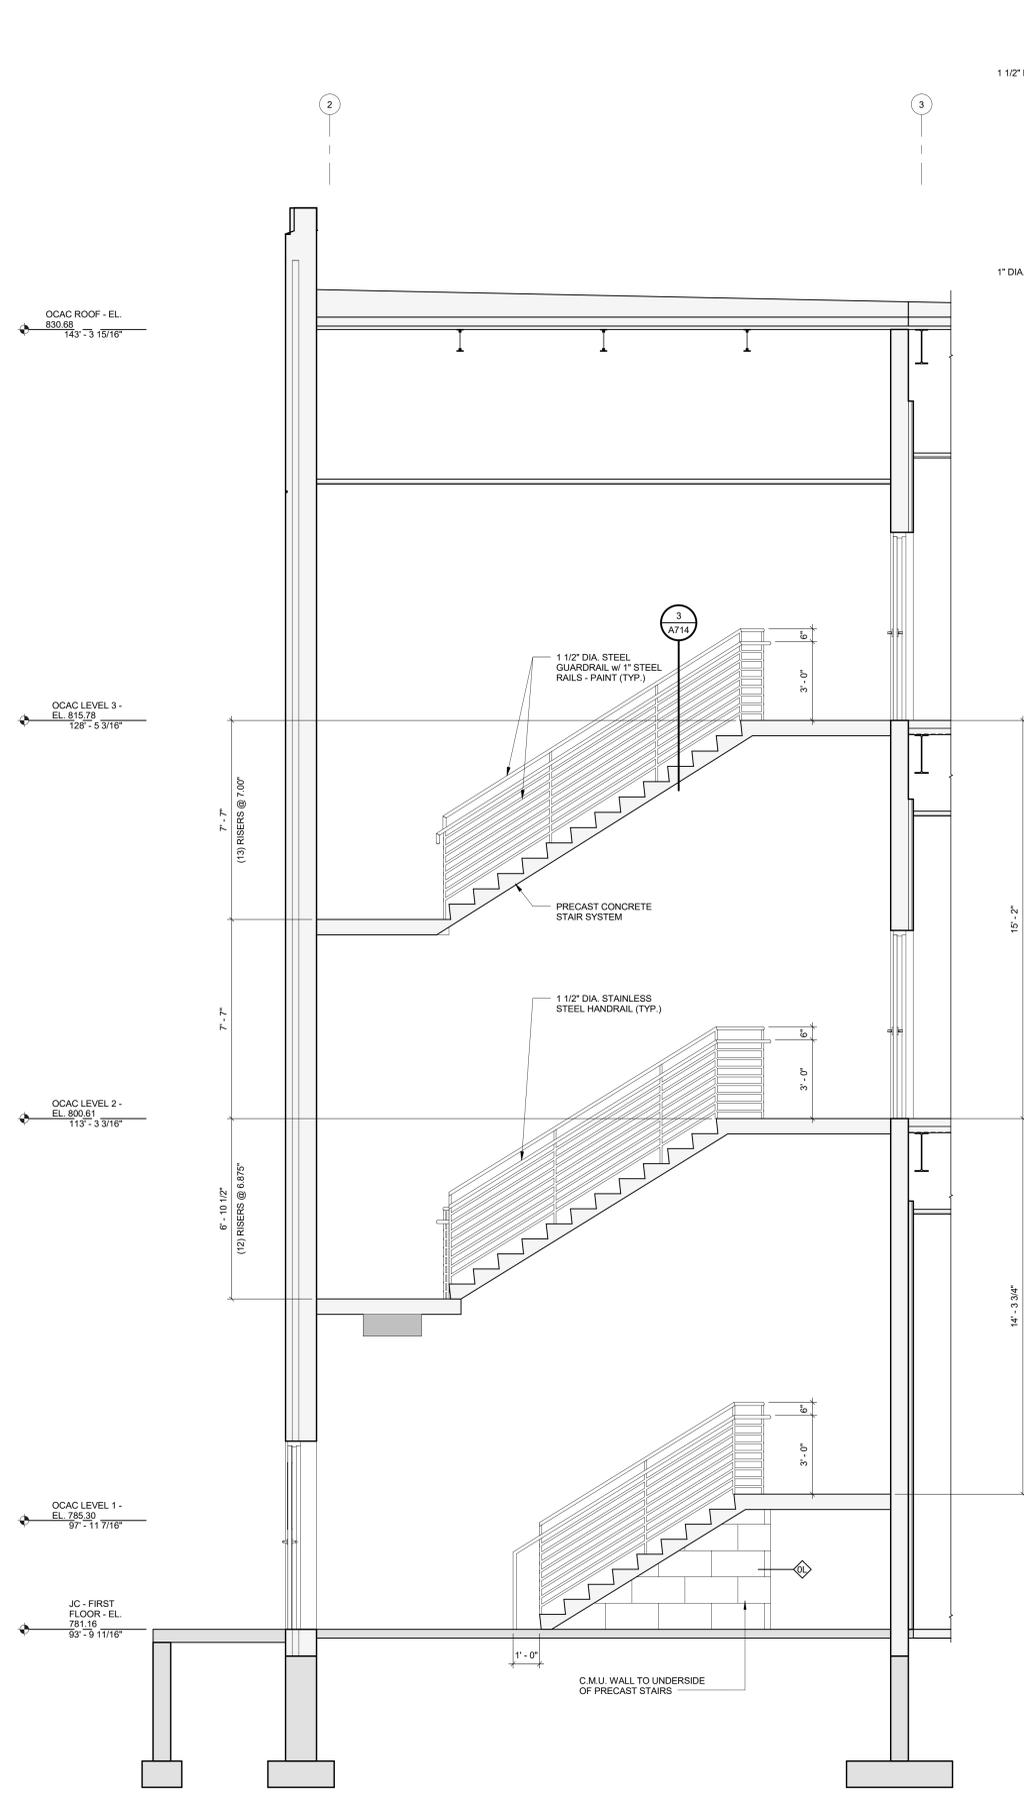

2 STAIR SECTION - 10.S2
A714 3/8" = 1'-0"

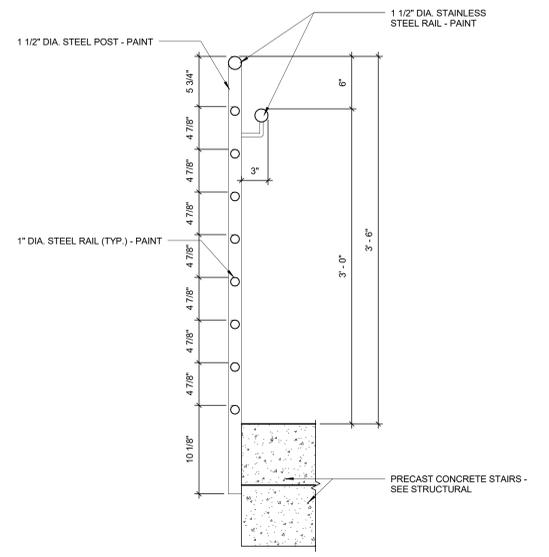

3 GUARDRAIL DETAIL
A714 1 1/2" = 1'-0"

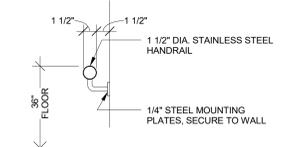


4 HANDRAIL DETAIL
A714 1 1/2" = 1'-0"


DESIGNED: ASF
DRAWN: BLG
PROJECT NO.: 00002-61600160
DATE: MARCH 3, 2017
SHEET NO.:

NO.	DATE	REVISION

NO.	DATE	REVISION

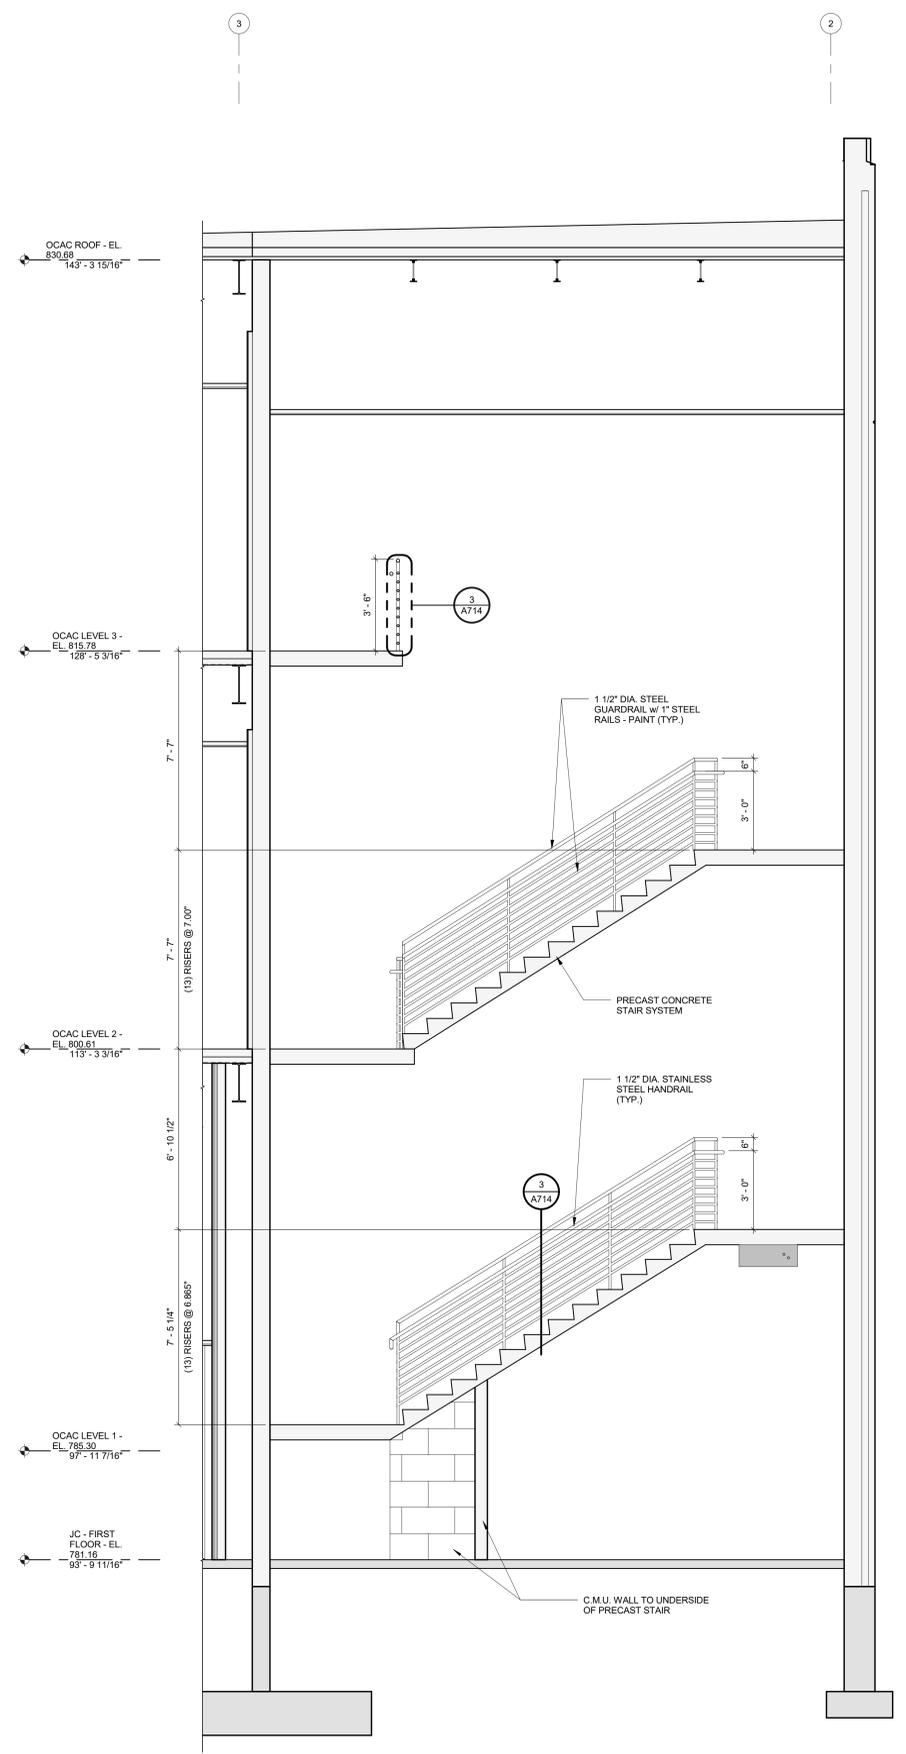

1 STAIR SECTION - 10.S2
A715 3/8" = 1'-0"

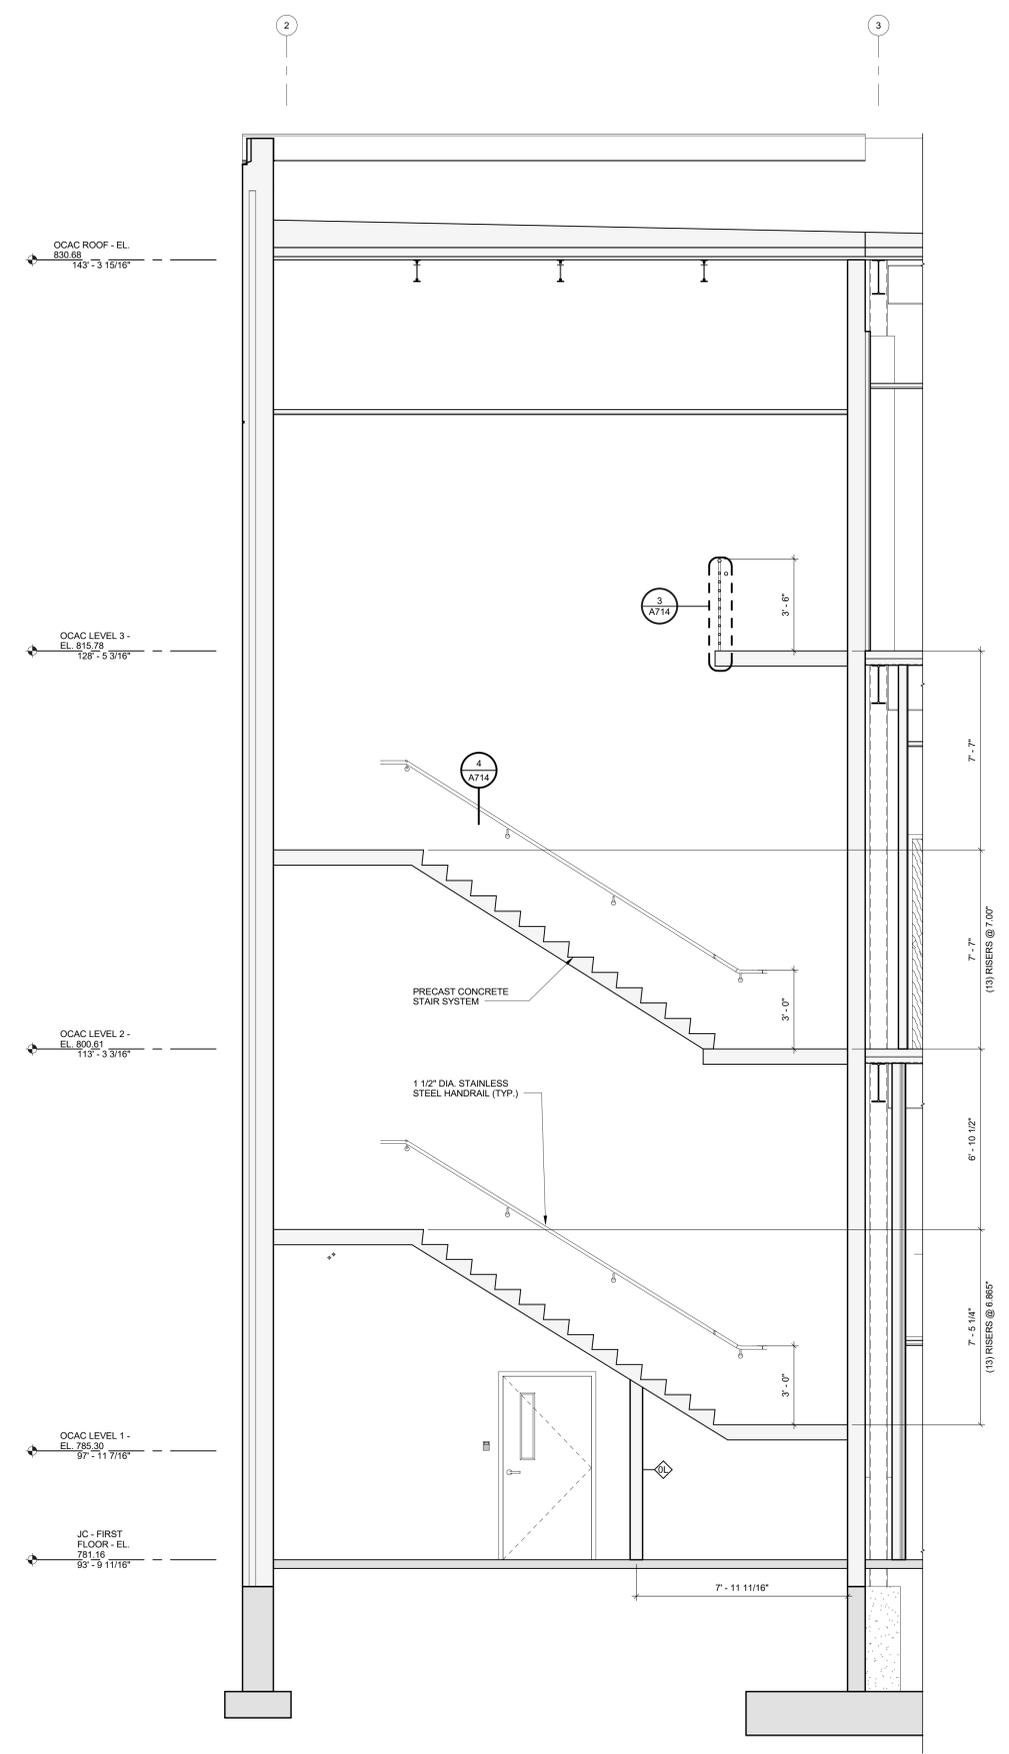


2 STAIR SECTION - 10.S2
A715 3/8" = 1'-0"

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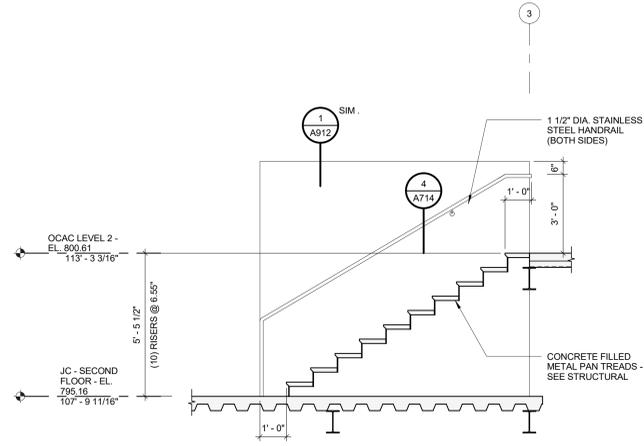
NO.	DATE	REVISION

ALTERATION / ADDITION
OUTAGAME COUNTY ADMINISTRATION CENTER
 S. WALNUT & W. 8TH, APPLETON WI 54911
 STAIR SECTIONS


DESIGNED	DRAWN
ASF	BLG
PROJECT NO. 0002-61600160	
DATE MARCH 3, 2017	
SHEET NO. A715	

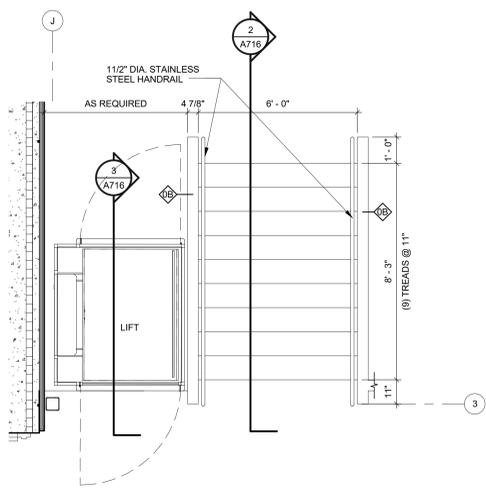


1 STAIR PLAN - 10.2.002
A716 3/8" = 1'-0"




2 STAIR SECTION - 10.2.002
A716 3/8" = 1'-0"

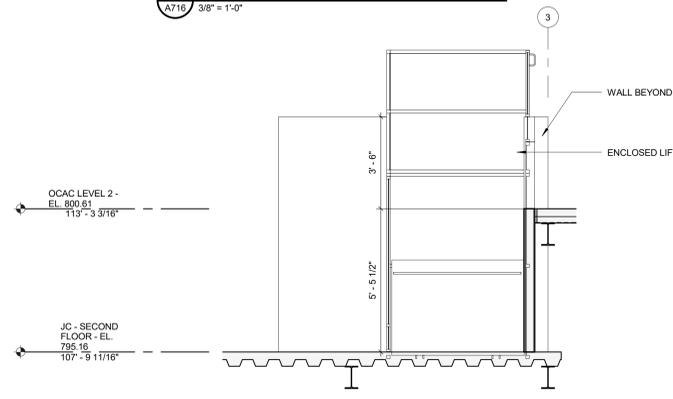


3 LIFT SECTION 10.2.002
A716 3/8" = 1'-0"

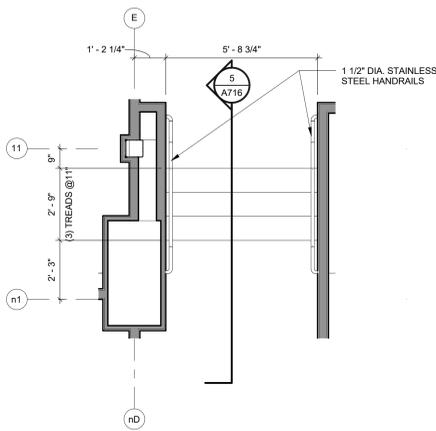


4 STAIR PLAN - 10.1.154
A716 3/8" = 1'-0"

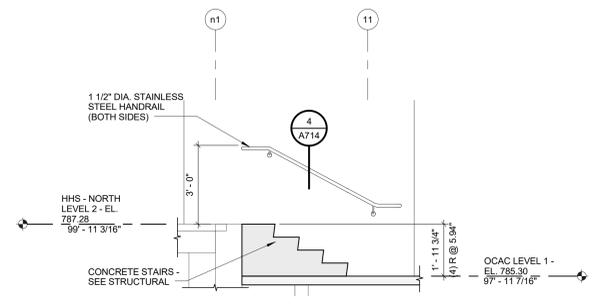


5 STAIR SECTION - 10.1.154
A716 3/8" = 1'-0"

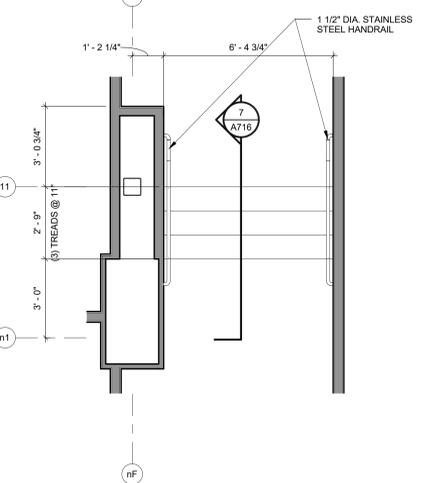


6 STAIR PLAN - 10.1.162
A716 3/8" = 1'-0"

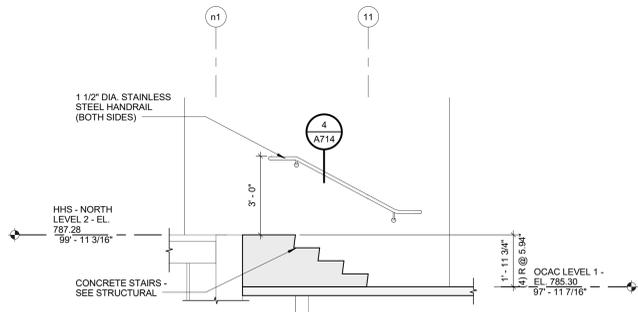


7 STAIR SECTION - 10.1.162
A716 3/8" = 1'-0"

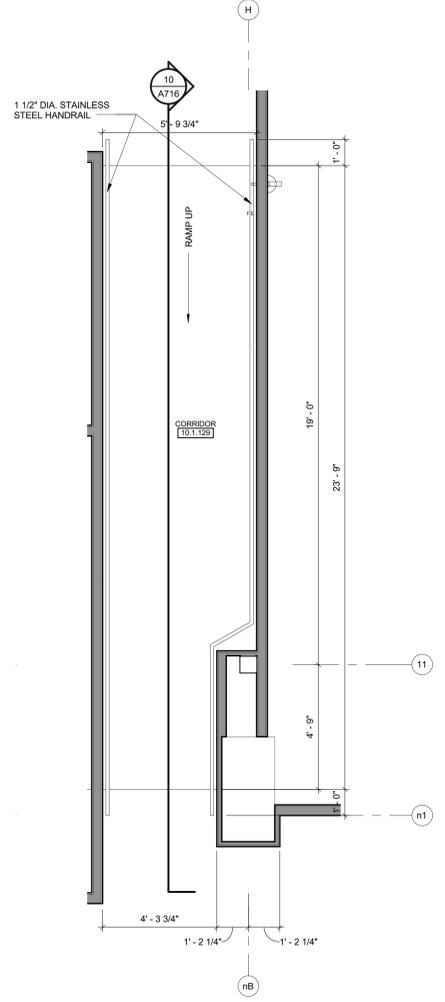


8 RAMP PLAN - 10.1.129
A716 3/8" = 1'-0"

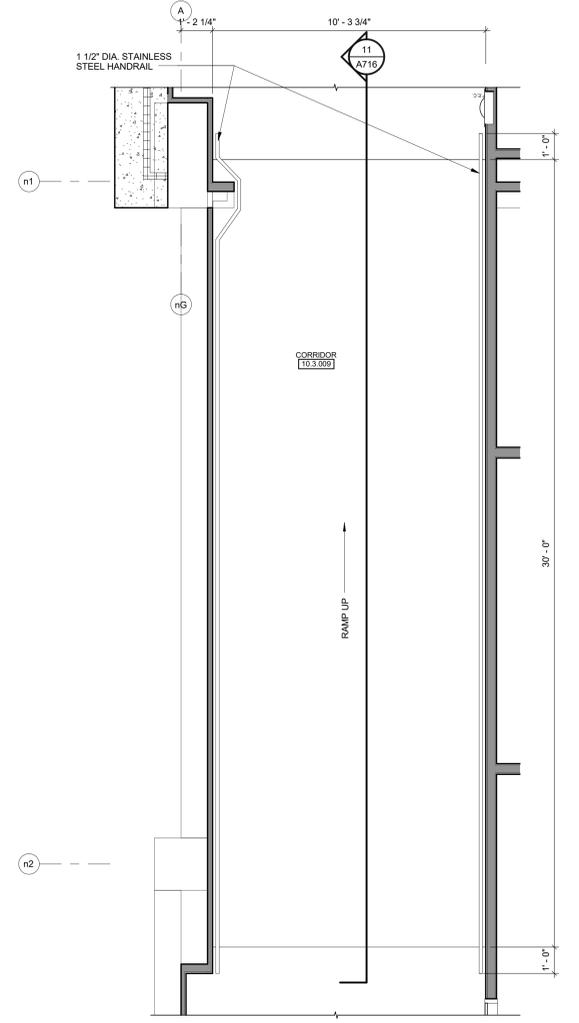

9 RAMP PLAN - 10.3.009
A716 3/8" = 1'-0"

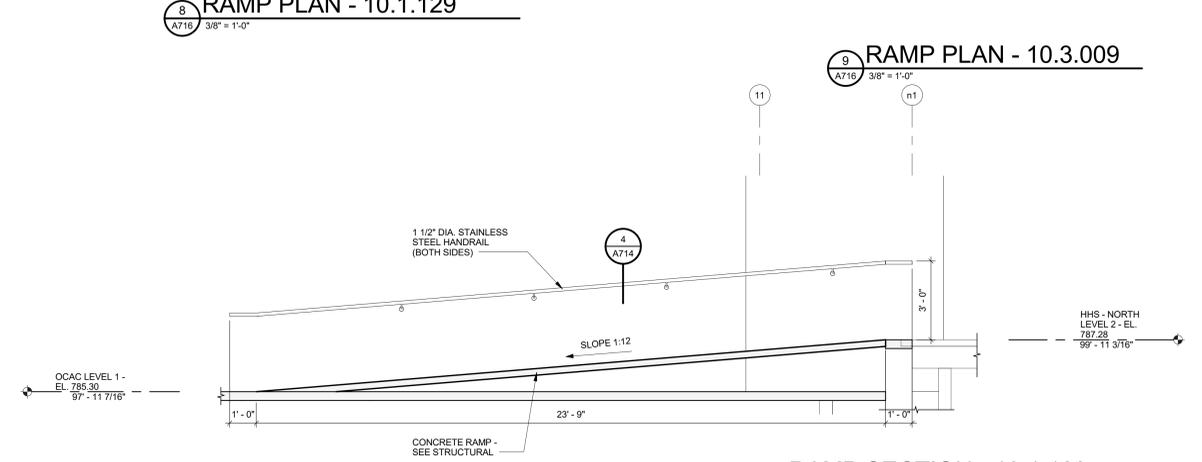


10 RAMP SECTION - 10.1.129
A716 3/8" = 1'-0"

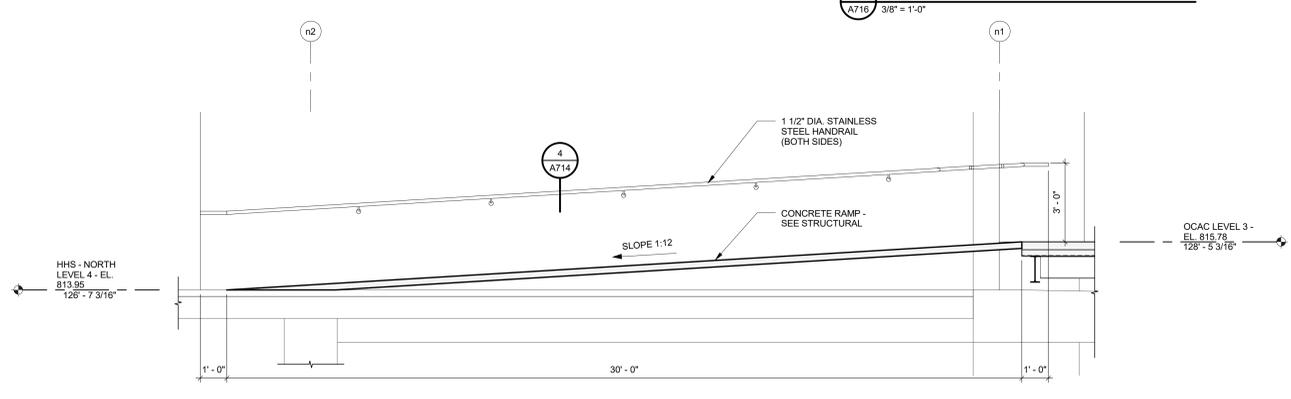


11 RAMP SECTION - 10.3.009
A716 3/8" = 1'-0"

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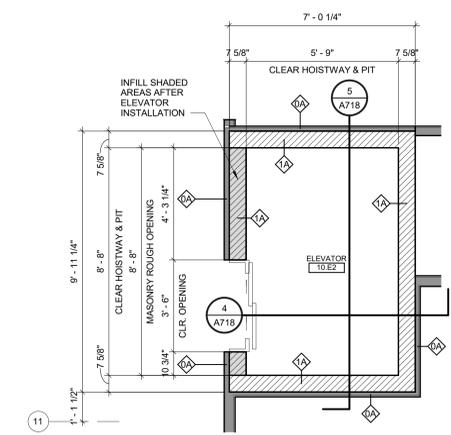
NO.	DATE	REVISION

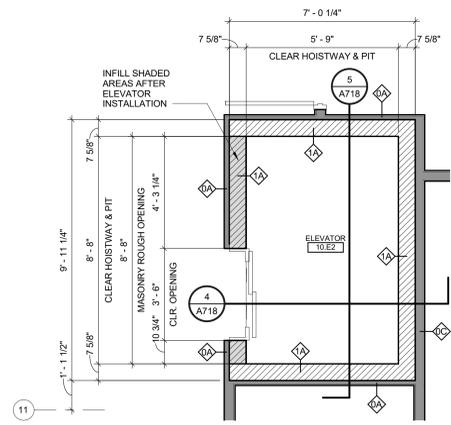


1 ELEVATOR PLAN - 10.E2

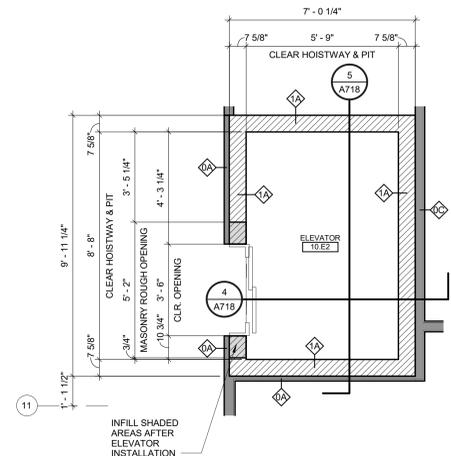


2 ELEVATOR PLAN - 10.E2



3 ELEVATOR PLAN - 10.E2

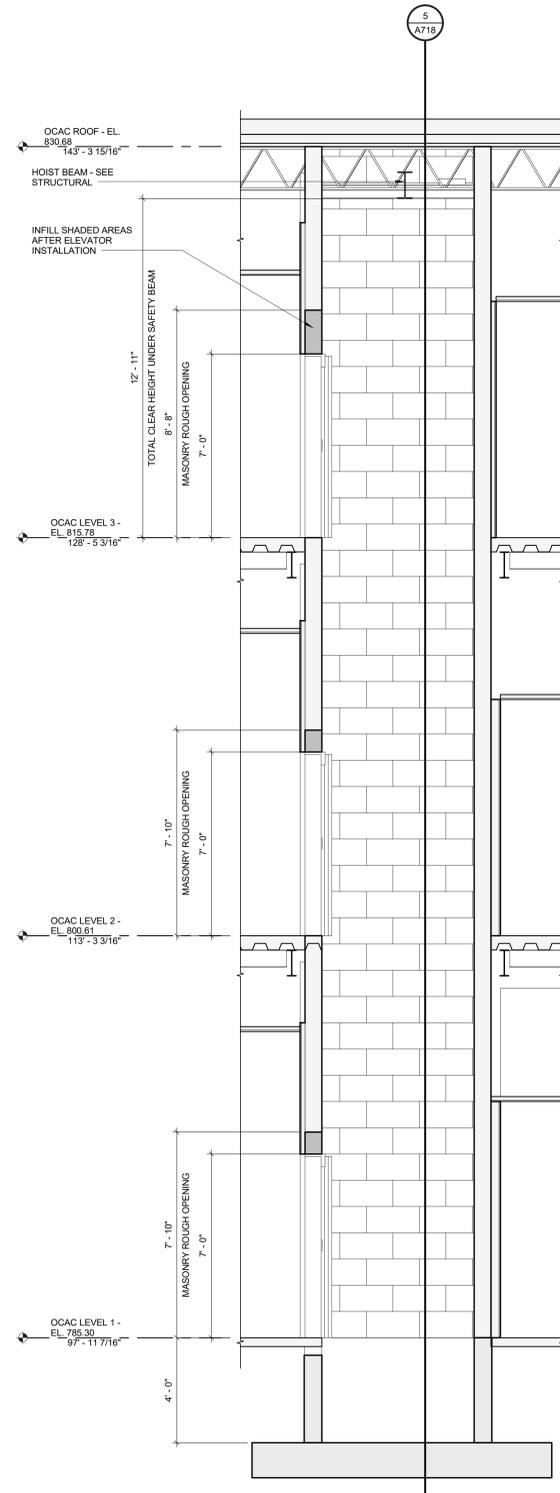

4 ELEVATOR SECTION - 10.E2

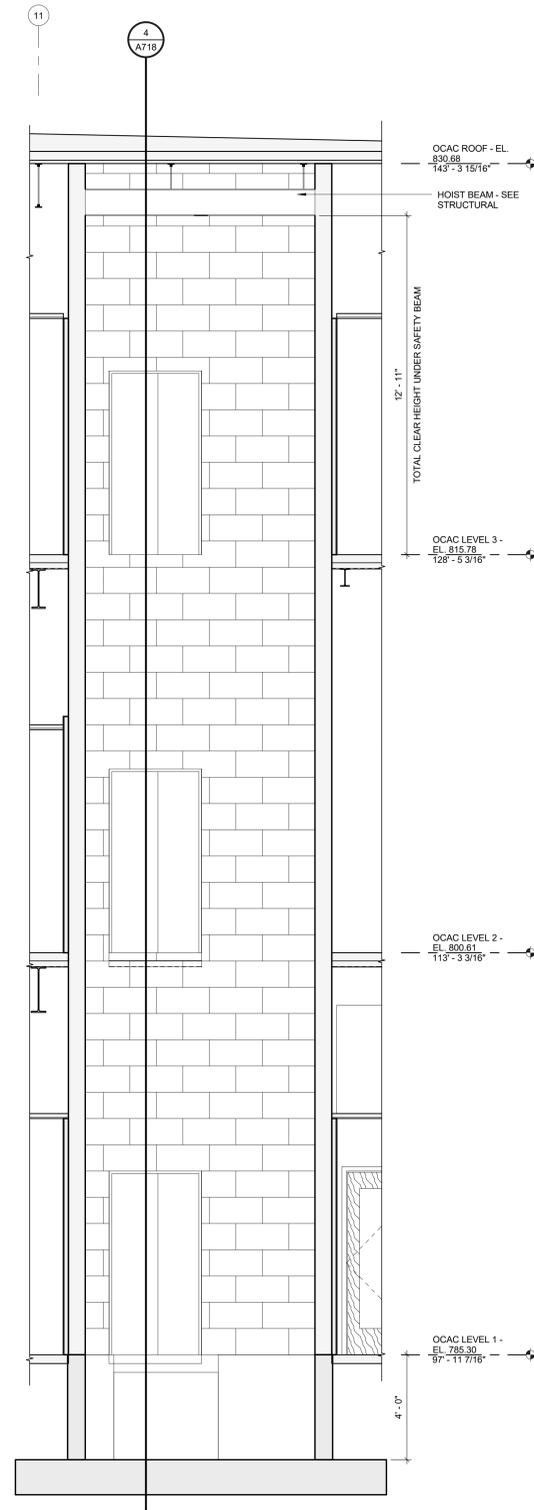

5 ELEVATOR SECTION


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NO.	DATE	REVISION

DESIGNED	DRAWN
ASF	BLG

ALTERATION / ADDITION
OUTAGAME COUNTY ADMINISTRATION CENTER
S. WALNUT & W. 8TH, APPLETON WI 54911
ELEVATOR PLANS AND SECTIONS

PROJECT NO.	0002-61600160
DATE	MARCH 3, 2017
SHEET NO.	A718

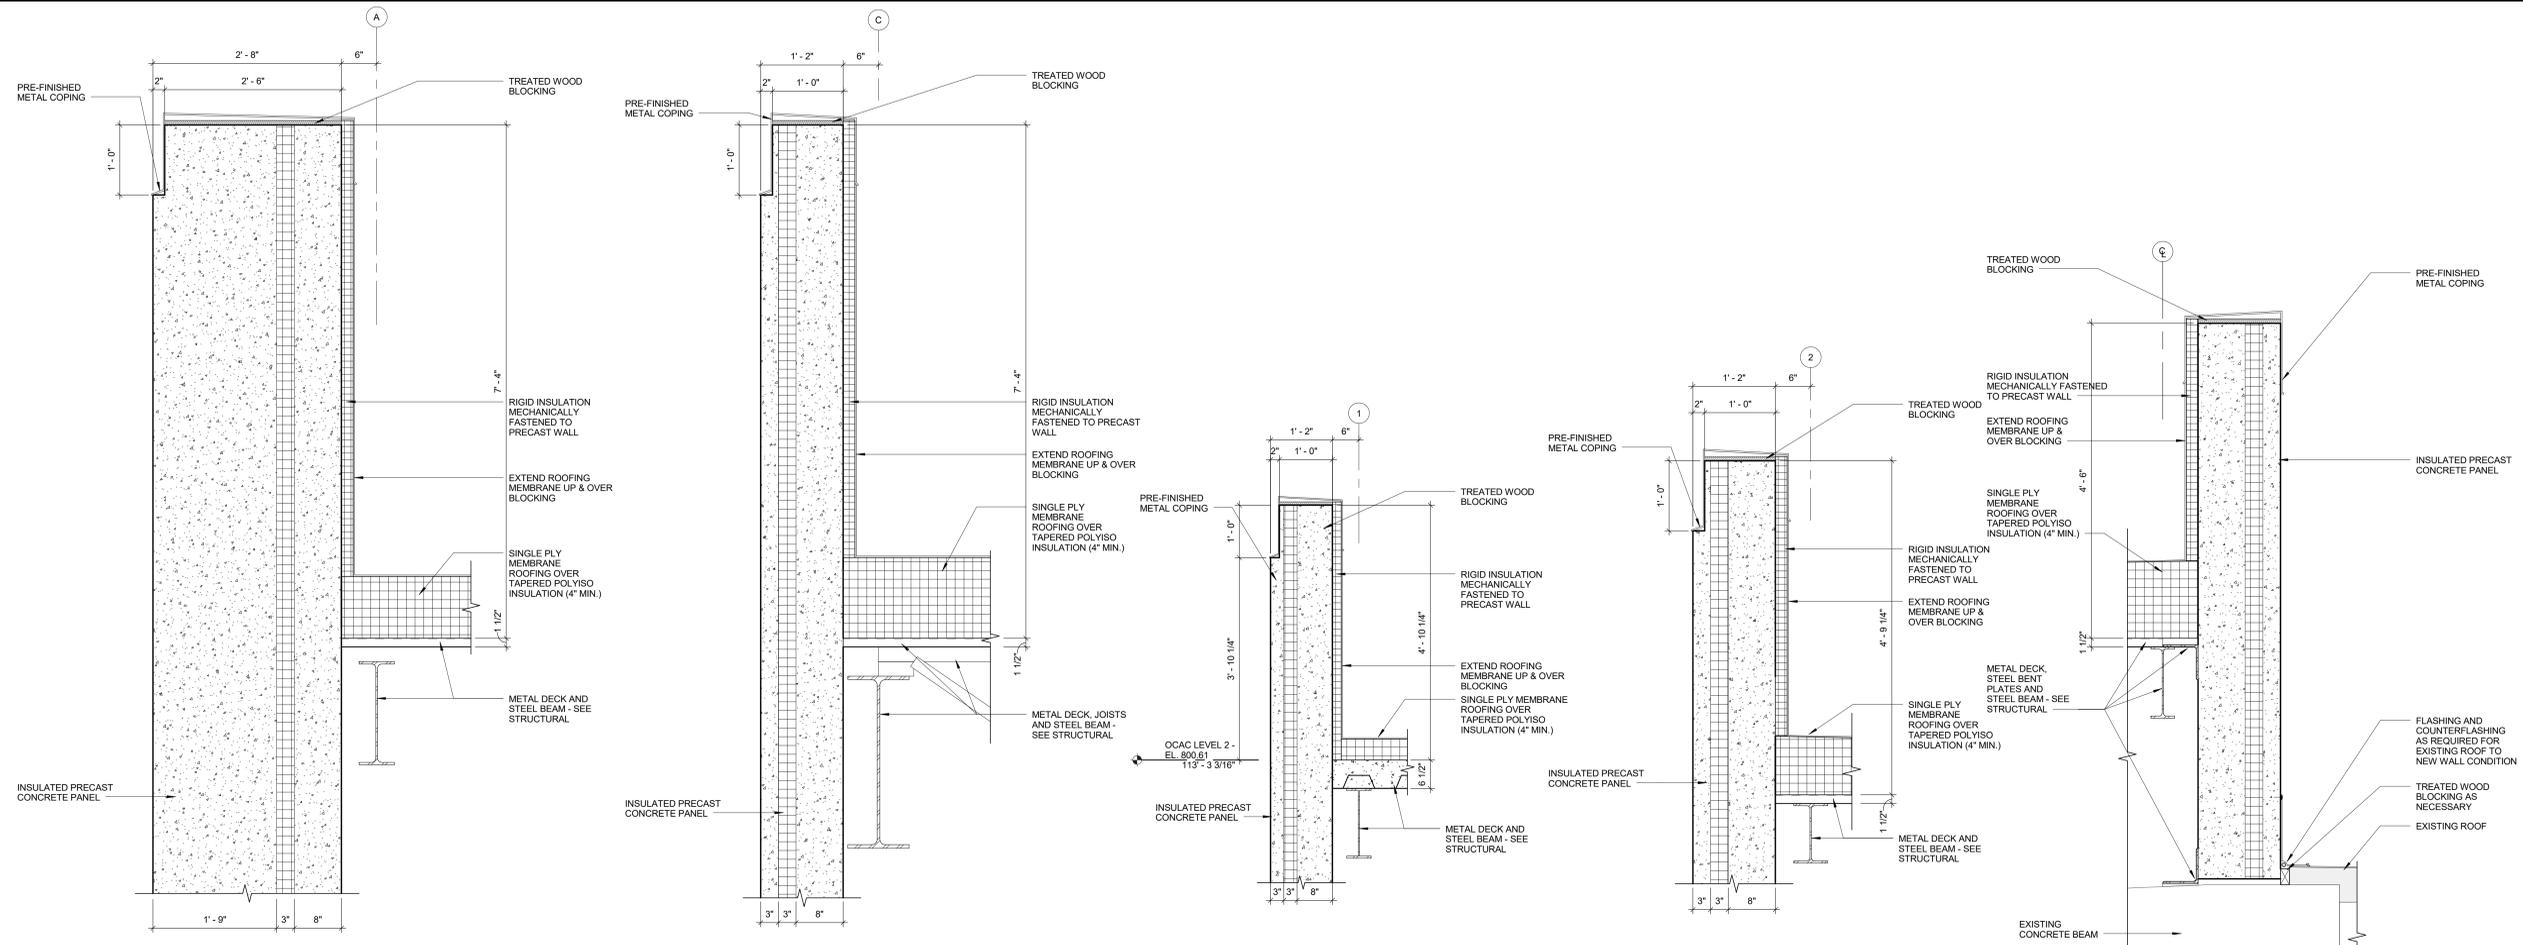


1 DETAIL
A812 1" = 1'-0"

2 DETAIL
A812 1" = 1'-0"

3 DETAIL
A812 3/4" = 1'-0"

4 DETAIL
A812 1" = 1'-0"

5 DETAIL
A812 1" = 1'-0"

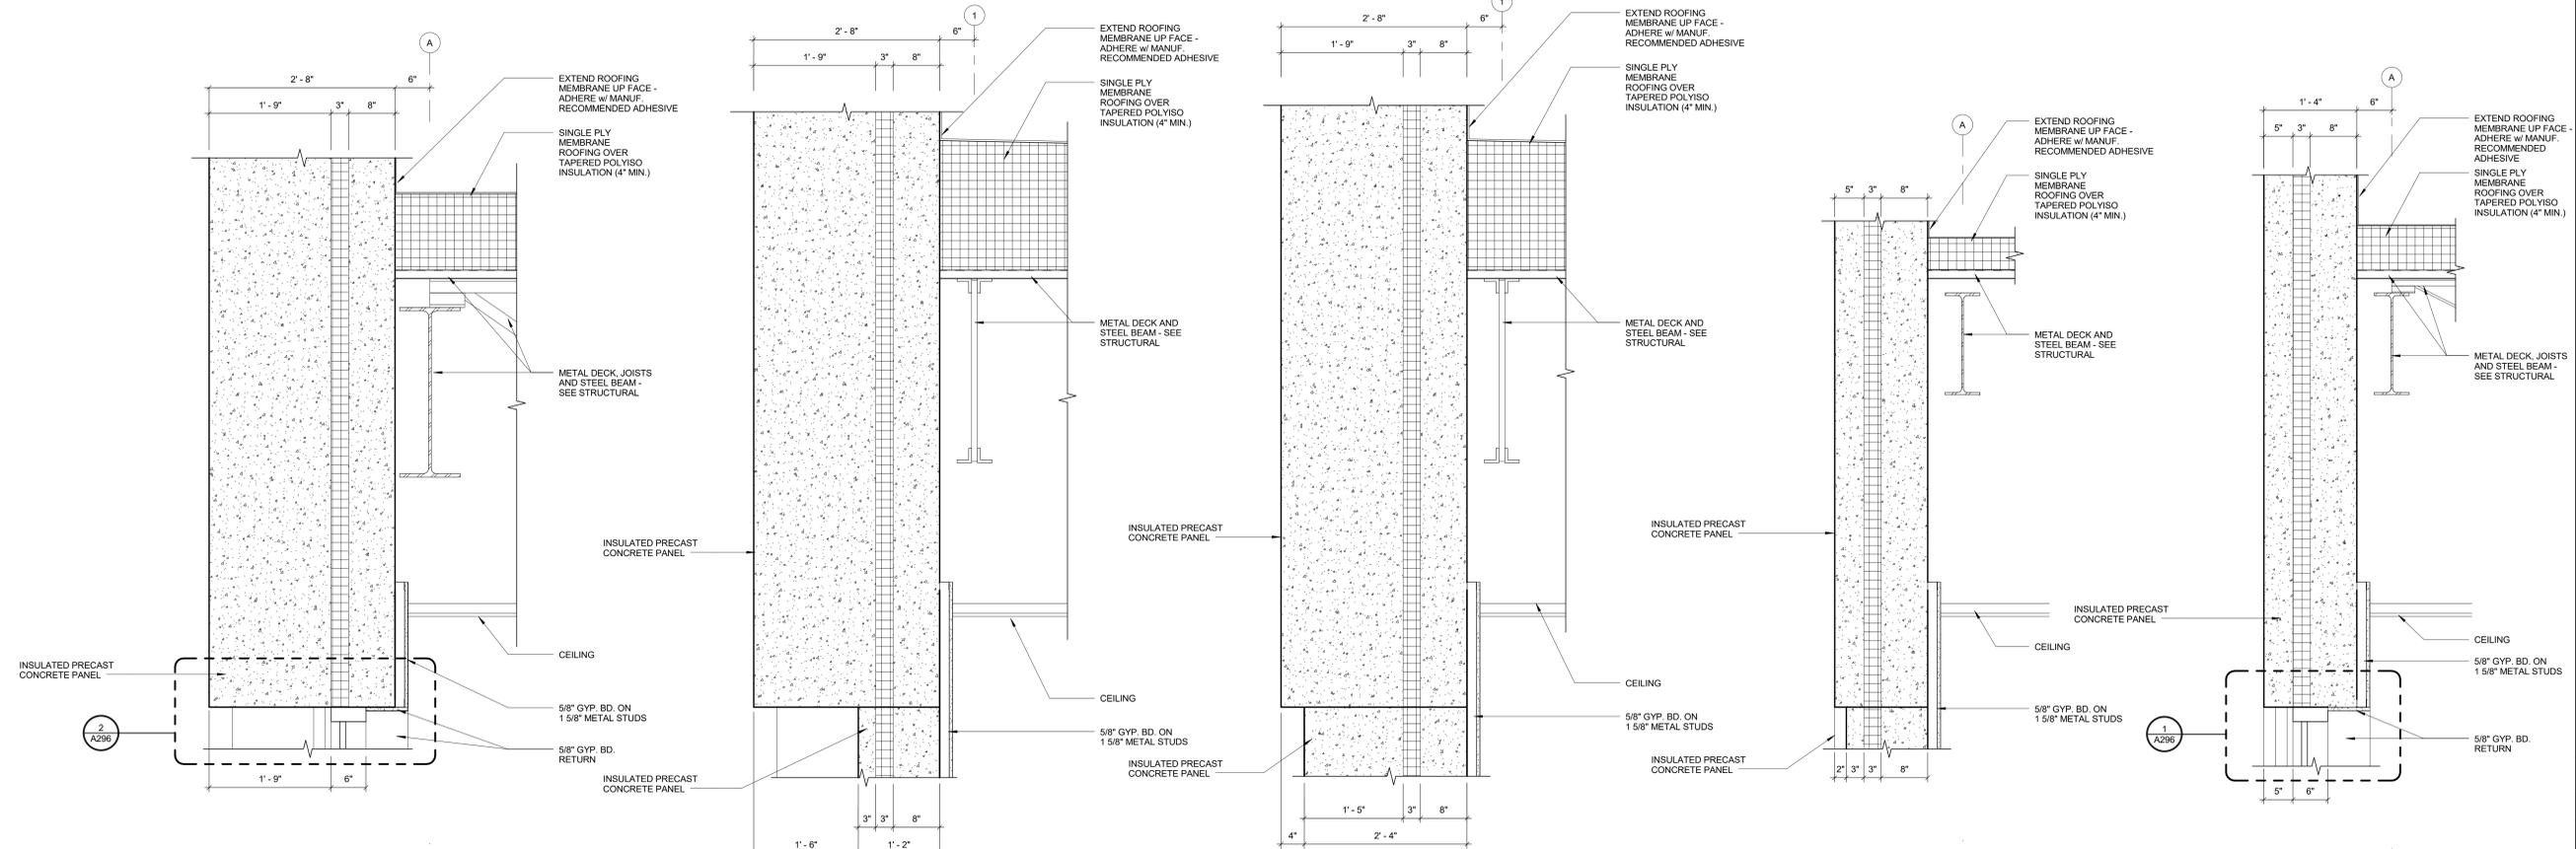

6 DETAIL
A812 1" = 1'-0"

7 DETAIL
A812 1" = 1'-0"

8 DETAIL
A812 1" = 1'-0"


9 DETAIL
A812 1" = 1'-0"

10 DETAIL
A812 1" = 1'-0"


McMahon provides this drawing as a service. All information is provided as is. The client is responsible for verifying the accuracy of the information. McMahon is not responsible for any errors or omissions. McMahon is not responsible for any changes made to the original drawing without the written consent of McMahon.

NO.	DATE	REVISION


DESIGNED	BLG
ASF	BLG
PROJECT NO.	0002-61600160
DATE	MARCH 3, 2017
SHEET NO.	A812

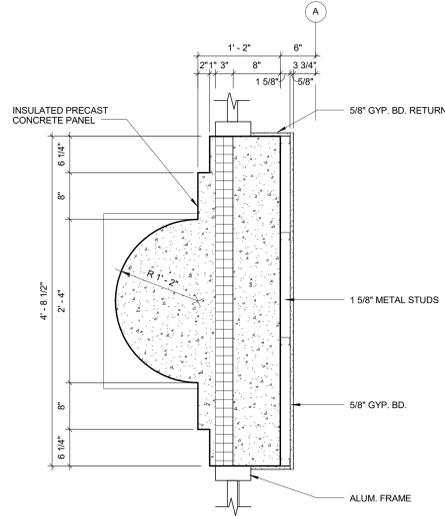


1 PRECAST PLAN DETAIL
A813 1" = 1'-0"

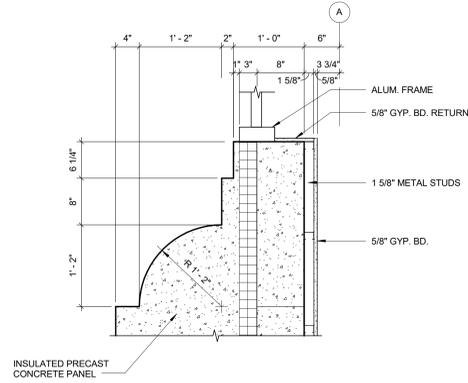


2 PRECAST PLAN DETAIL
A813 1" = 1'-0"

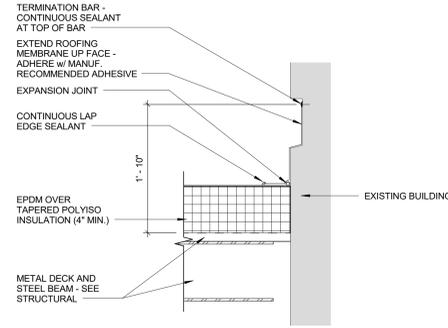


3 NEW ROOF TO EXISTING WALL
A813 1" = 1'-0"

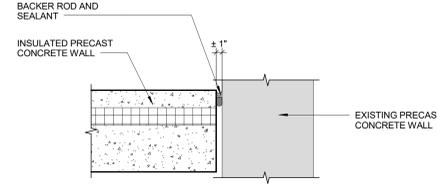


4 NEW PRECAST TO EXISTING
A813 1" = 1'-0"

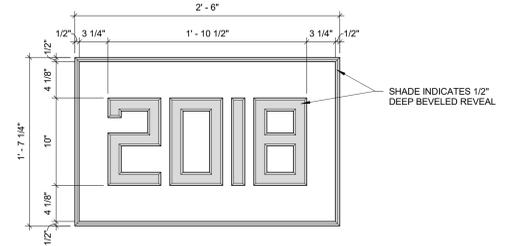


5 DEDICATION DETAIL
A813 1 1/2\"/>

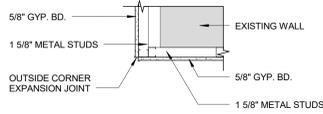


6 CORNER EXPANSION DETAIL
A813 1" = 1'-0"

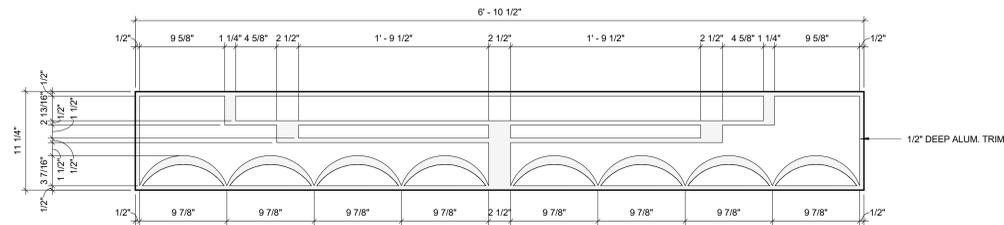

9 TRANSOM DECORATION DETAIL
A813 1 1/2\"/>

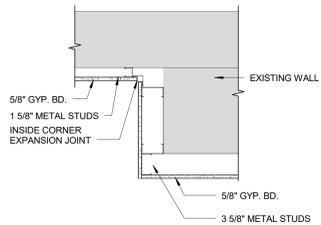

7 CORNER EXPANSION DETAIL
A813 1" = 1'-0"

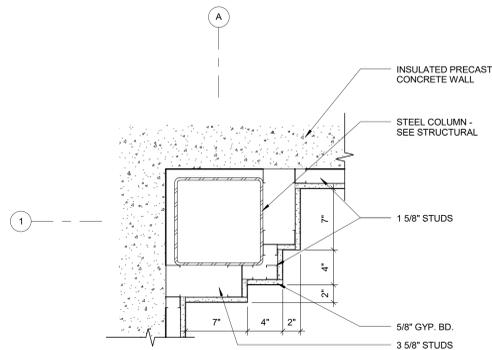

8 COLUMN DETAIL
A813 1 1/2\"/>

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REVISION


DATE

NO.

ALTERATION / ADDITION
OUTAGAME COUNTY ADMINISTRATION CENTER
S. WALNUT & W. 8TH, APPLETON WI 54911
EXTERIOR & MISCELLANEOUS DETAILS


DESIGNED ASF	DRAWN BLG
PROJECT NO. 0002-61600160	
DATE MARCH 3, 2017	
SHEET NO.	

A813

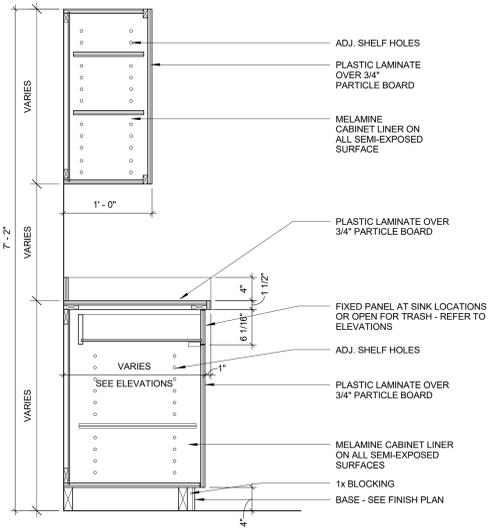


1 CABINET BASE & UPPER

A911 1" = 1'-0"

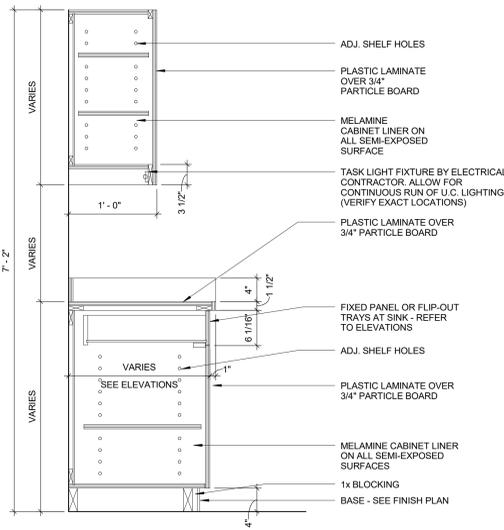


2 CABINET BASE & UPPER W/ U.C. LIGHTING

A911 1" = 1'-0"

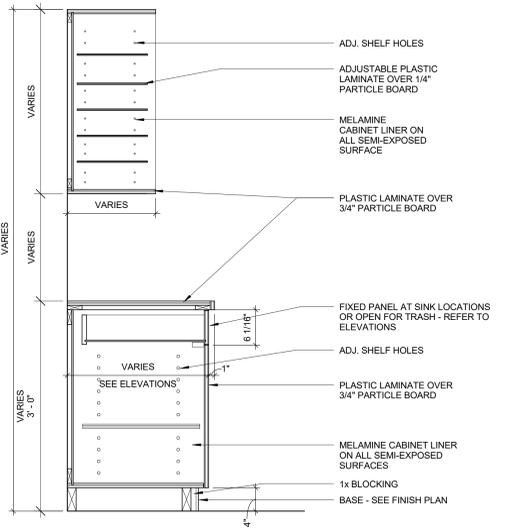

3 CABINET BASE & UPPER MAILBOXES



A911 1" = 1'-0"

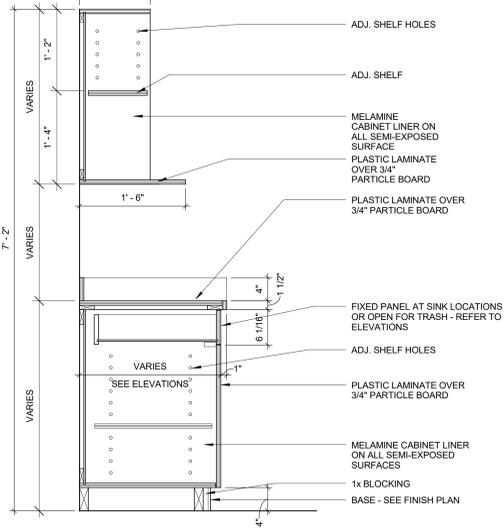

4 CABINET BASE & UPPER MICROWAVE CABINET


A911 1" = 1'-0"

- GENERAL CASEWORK NOTES**
- VERIFY ALL EQUIPMENT WITH OWNER PRIOR TO CONSTRUCTION.
 - COORDINATE GROMMET LOCATIONS WITH OWNER PRIOR TO INSTALLATION.
 - RADIUS ALL OUTSIDE CORNERS OF COUNTERTOPS.
 - ALL DRAWERS MARKED "F" TO HAVE FILE DRAWER HARDWARE AND BE LOCKABLE.
 - ALL VISIBLE CASEWORK SURFACES TO BE PLASTIC LAMINATE.
 - VERIFY ALL ROOM DIMENSIONS PRIOR TO CONSTRUCTION OF CASEWORK.
 - GENERAL CONTRACTOR TO PROVIDE ALL NECESSARY BACKING IN WALLS.
 - SUPPLY AND INSTALL SUPPORT BRACKETS AS NEEDED UNDER COUNTERTOPS.
 - MINIMUM 1" FILLER WHERE CABINET IS 90 DEGREES TO WALL OR OTHER CABINETS

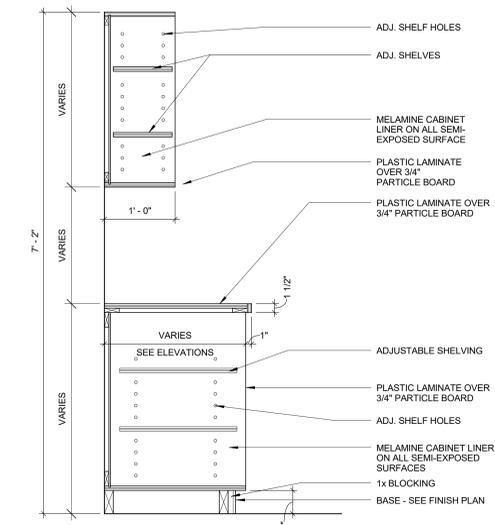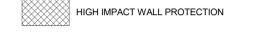


5 CABINET BASE & UPPER OPEN CABINET

A911 1" = 1'-0"

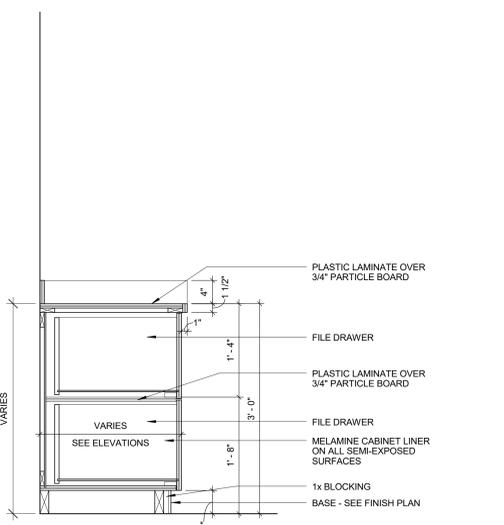


6 CABINET BASE W/ FILE DRAWERS

A911 1" = 1'-0"

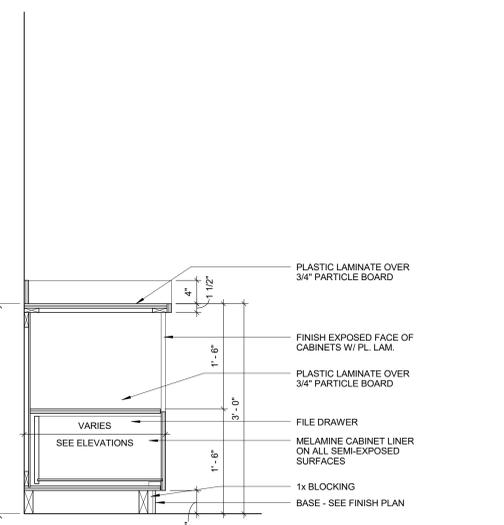


7 CABINET BASE W/ ONE DRAWER

A911 1" = 1'-0"

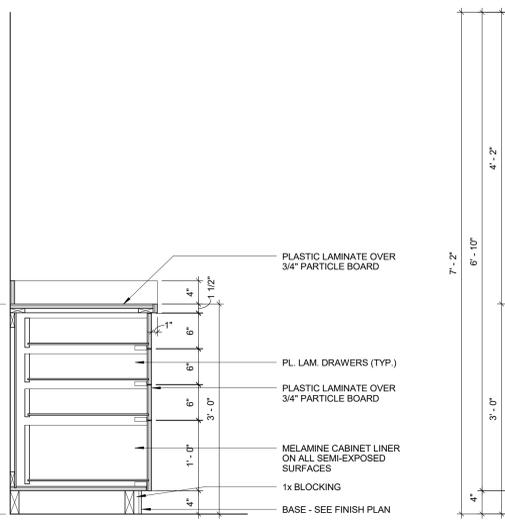


8 CABINET BASE W/ DRAWERS

A911 1" = 1'-0"

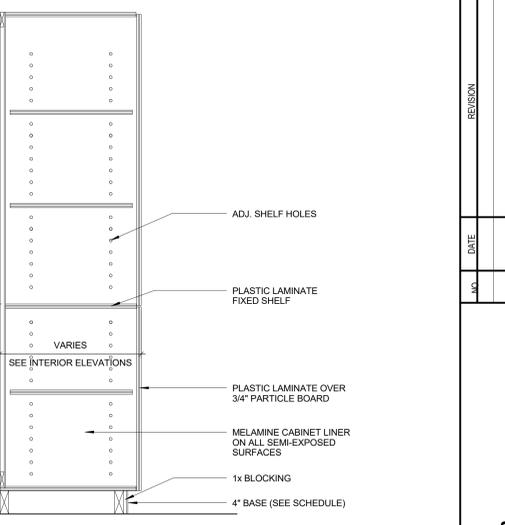


9 FULL HEIGHT CABINET

A911 1" = 1'-0"

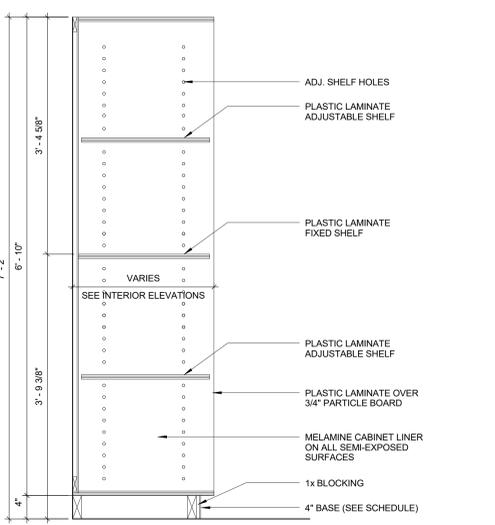


10 FULL HEIGHT CUBBIES

A911 1" = 1'-0"

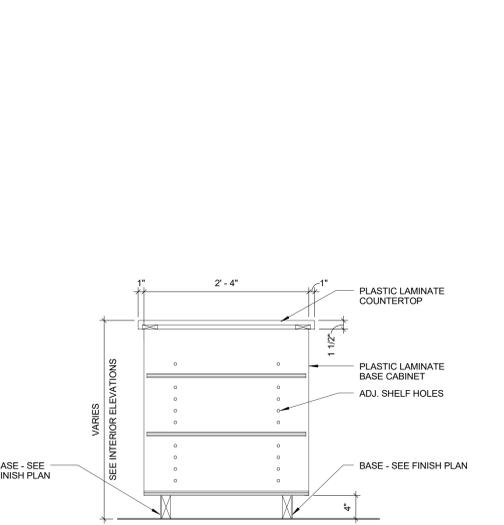


11 ISLAND COUNTER (OPEN BOTH SIDES)

A911 1" = 1'-0"

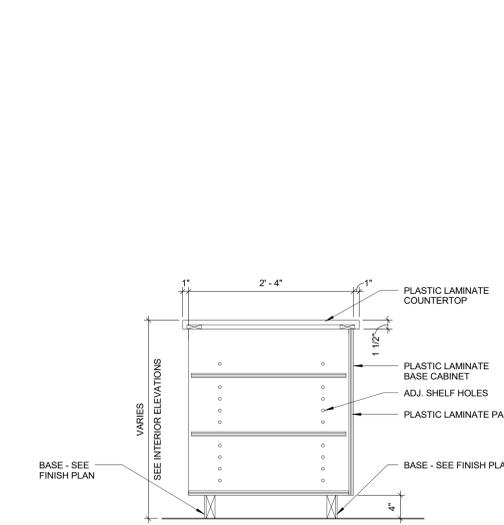


12 ISLAND COUNTER (CLOSED ONE SIDE)

A911 1" = 1'-0"

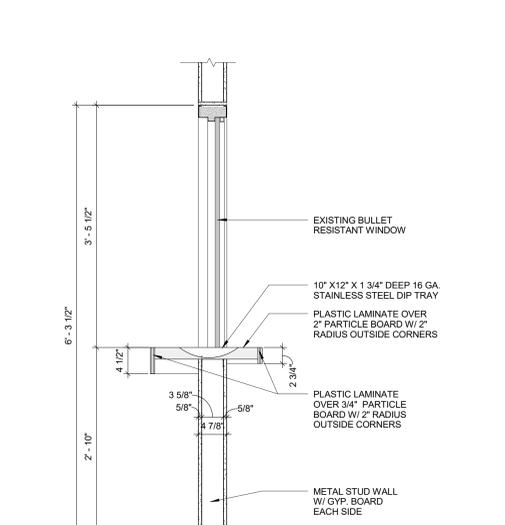

13 D.A. TRANSACTION COUNTER

A911 1" = 1'-0"

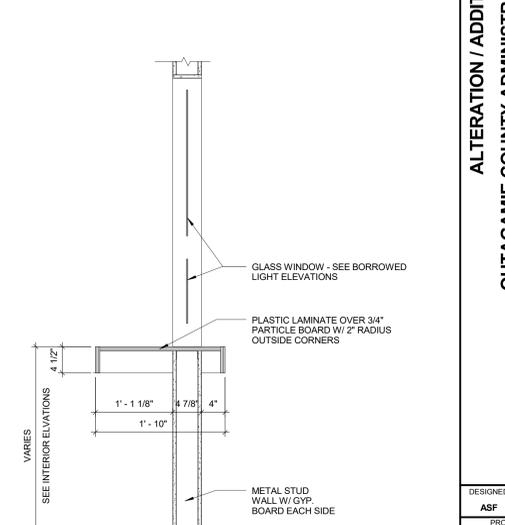

14 TRANSACTION COUNTER

A911 1" = 1'-0"


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NO.	DATE	REVISION


DESIGNED	DRAWN
ASF	BLG

ALTERATION / ADDITION
 OUTAGAME COUNTY ADMINISTRATION CENTER
 S. WALNUT & W. 8TH, APPLETON WI 54911
 INTERIOR DETAILS


PROJECT NO.	0002-61600160
DATE	MARCH 3, 2017
SHEET NO.	A911

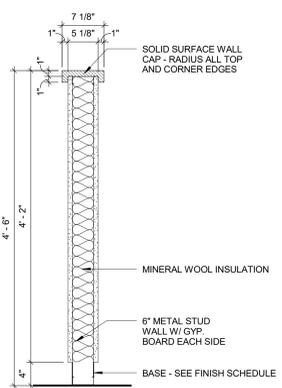


1 HALF WALL DETAIL
A912 1" = 1'-0"

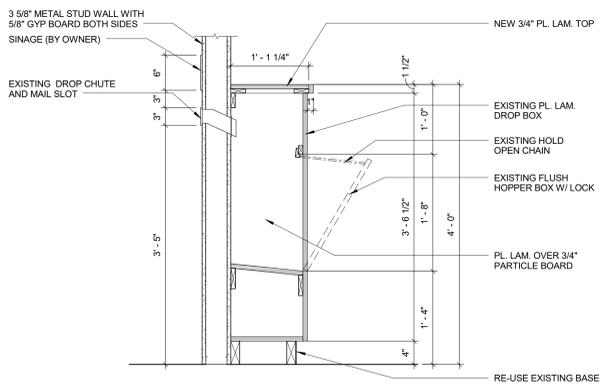


2 DROP BOX
A912 1" = 1'-0"

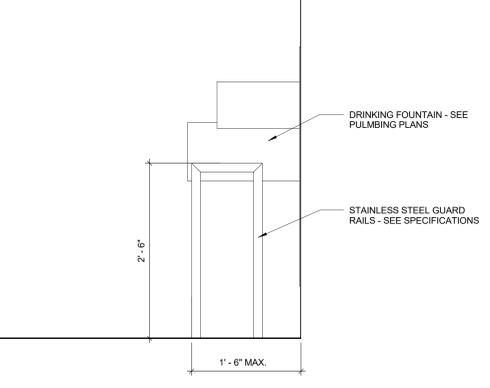


3 DRINKING FOUNTAIN RAILS
A912 1" = 1'-0"

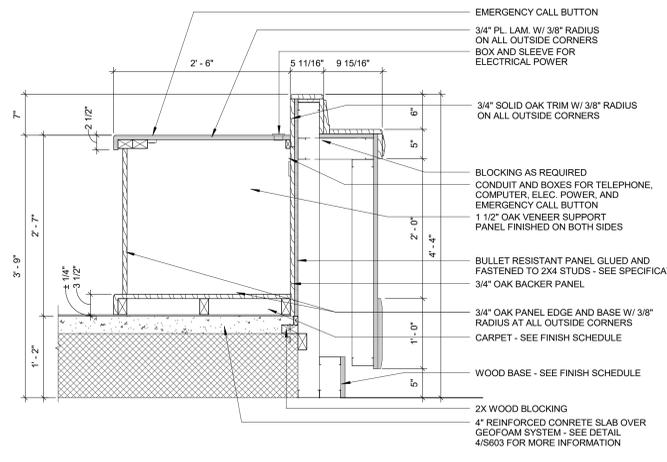


4 JUDGES DESK
A912 1" = 1'-0"

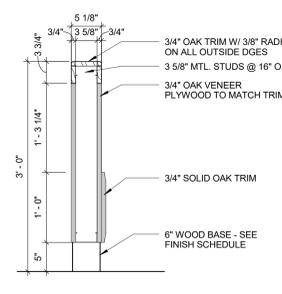


5 TYPICAL RAIL SECTION
A912 1" = 1'-0"

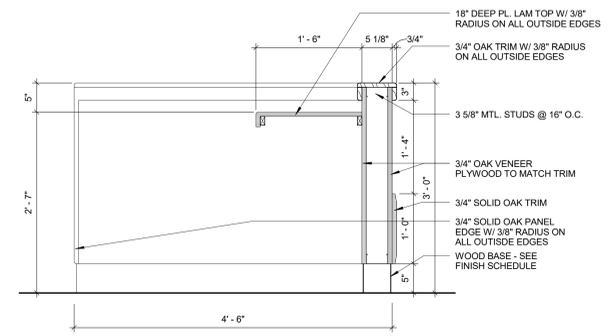


6 WITNESS STAND
A912 1" = 1'-0"

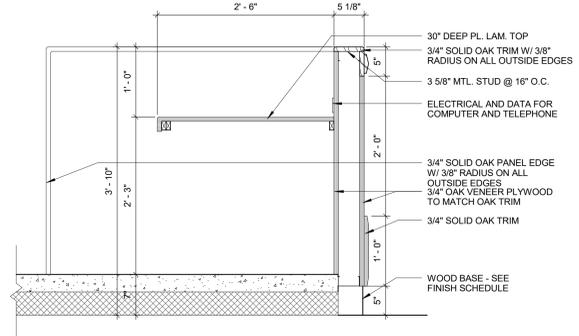


7 CLERK OF COURTS
A912 1" = 1'-0"

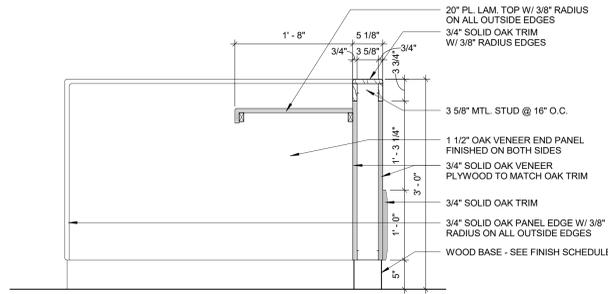


8 COURT REPORTER
A912 1" = 1'-0"

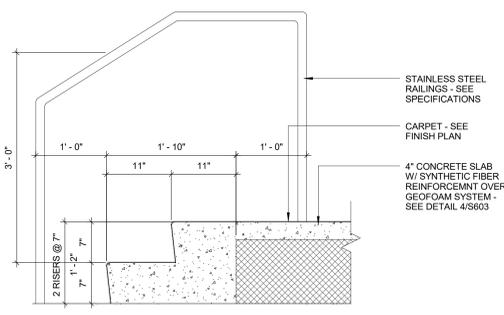


9 TYPICAL COURTROOM PLATFORM
A912 1" = 1'-0"

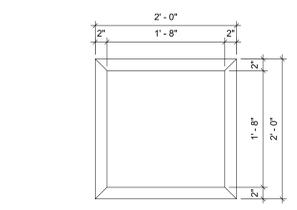


10 COURTROOM WOOD PANEL
A912 1" = 1'-0"

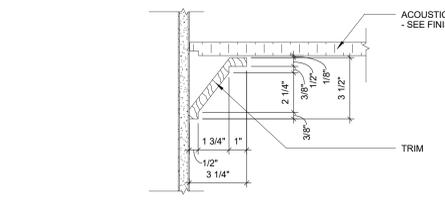


11 COURTROOM CROWN MOULDING
A912 NOT TO SCALE

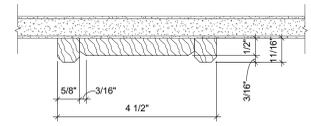


12 COURTROOM STANDING TRIM
A912 6\"/>

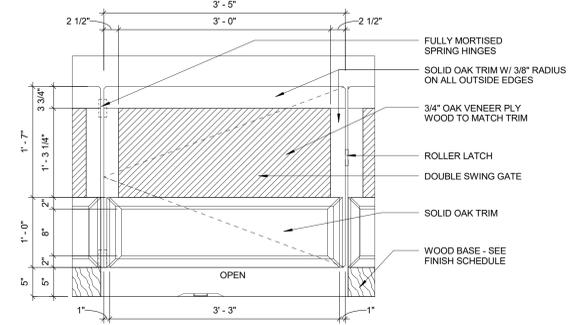


13 RAIL DOOR DETAIL
A912 1" = 1'-0"

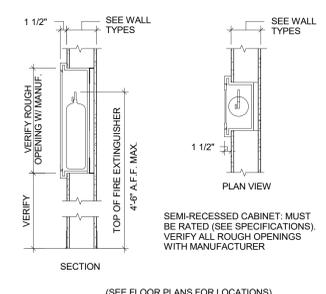


14 FIRE EXTINGUISHER CABINET
A912 3/4\"/>

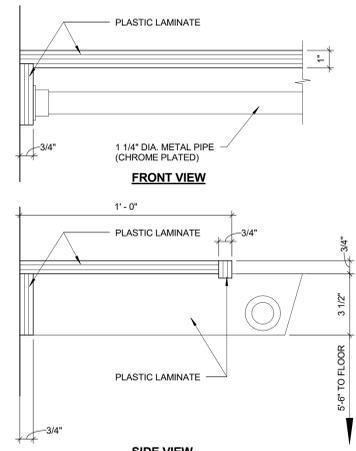


15 ROD AND SHELF
A912 3\"/>

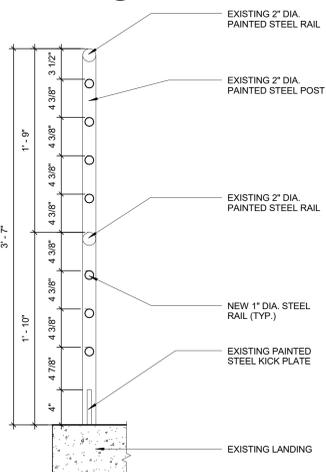


16 GUARDRAIL DETAIL @ LANDING
A912 1 1/2\"/>

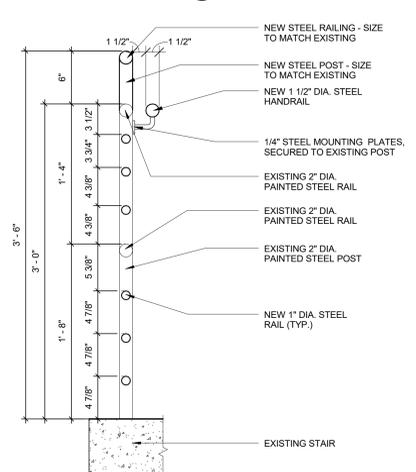

17 GUARDRAIL DETAIL @ STAIR
A912 1 1/2\"/>

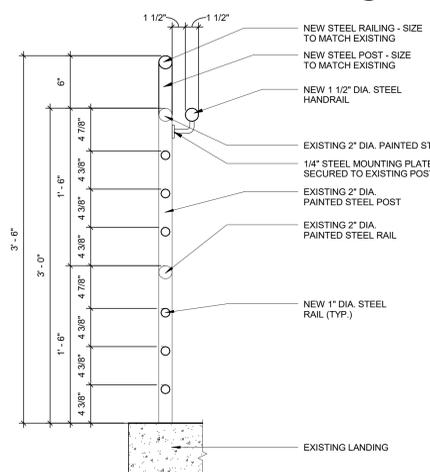

18 GUARDRAIL DETAIL @ TRANSITION
A912 1 1/2\"/>

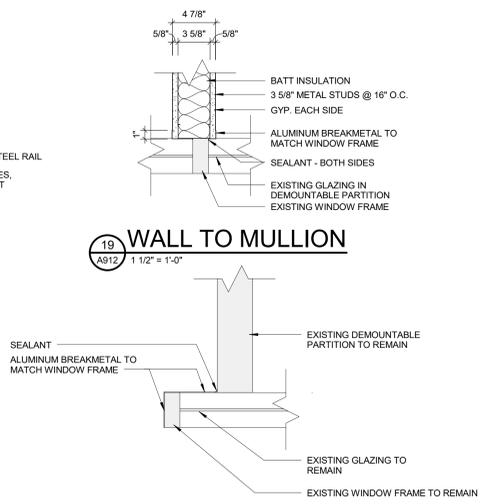

19 WALL TO MULLION
A912 1 1/2\"/>

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NO.	DATE	REVISION

STRUCTURAL SPECIFICATIONS

DESIGN CODE:

- COMPLY WITH THE FOLLOWING CODES:
ASCE 7-05
IBC 2009
WISCONSIN BUILDING CODE, LATEST EDITION

DESIGN LOADS:

1. DEAD LOAD:	ROOF FLOOR	-20 PSF -50 PSF
2. LIVE LOAD:	ROOF FLOOR CORRIDORS STAIRS	-20 PSF -100 PSF -100 PSF -100 PSF
3. SNOW LOAD:	GROUND SNOW LOAD (Pg) UNIFORM SNOW LOAD (Ps) ROOF SLOPE FACTOR (Cs) SNOW EXPOSURE FACTOR (Ce) ROOF THERMAL FACTOR (Ct) IMPORTANCE FACTOR (I) NON-UNIFORM LOADS	-40 PSF -28 PSF -1.00 -1.00 -1.00 -1.00 -SEE SNOW DRIFT PLAN
4. WIND:	BASIC WIND SPEED IMPORTANCE FACTOR (I) WIND EXPOSURE INTERNAL PRESSURE COEFFICIENT (Gcp) COMPONENT DESIGN VELOCITY PRESSURE (qz) EFFECTIVE AREA WALL CENTER WALL CORNER ROOF	-90 MPH -1.00 -C -0.18 (ENCLOSED STRUCTURE) -19.2 PSF -10 FT ² -22.4 PSF -27.6 PSF -SEE ROOF FRAMING NOTES -SEE NET UPLIFT PLAN
5. SEISMIC:	MAPPED SPECTRAL RESPONSE: Ss SI IMPORTANCE FACTOR (I) SITE CLASS SPECTRAL RESPONSE COEFFICIENTS: S0s S1 SEISMIC DESIGN CATEGORY SEISMIC FORCE RESISTING SYSTEM DESIGN BASE SHEAR SEISMIC RESPONSE COEFFICIENT (Cs) RESPONSE MODIFICATION FACTOR (R) ANALYSIS PROCEDURE	-0.069 -0.033 -1.00 -D -0.074 -0.053 -A -BRACED FRAMES -8k -0.001 -3.0 -EQUIVALENT LATERAL FORCE

GENERAL:

- VERIFY ALL DIMENSIONS, ELEVATIONS, SECTIONS AND DETAILS BETWEEN THE ARCHITECTURAL AND STRUCTURAL PLANS PRIOR TO STARTING WORK. NOTIFY ARCHITECT/ENGINEER OF ANY DISCREPANCIES OR INCONSISTENCIES.
- SEE MECHANICAL PLANS FOR CONCENTRATED EQUIPMENT POINT LOADS ON FLOOR AND ROOF FRAMING.
- VERIFY SIZE, LOCATION, AND NUMBER OF WALL, FLOOR, AND ROOF OPENINGS WITH THE STRUCTURAL, ARCHITECTURAL, MECHANICAL, AND ELECTRICAL PLANS. PROVIDE ALL OPENINGS AND SUPPORT FRAMING.
- CONTRACTOR SHALL COORDINATE LOCATIONS OF ALL ARCHITECTURAL AND MECHANICAL ATTACHMENTS AND OPENINGS.
- SEE ELECTRICAL PLANS FOR REQUIRED ELECTRICAL GROUNDING TO BE CONSTRUCTED INTEGRAL WITH STRUCTURAL FOUNDATIONS.
- PROVIDE ALL NECESSARY TEMPORARY BRACING, SHORING, GUYING, OR OTHER MEANS TO AVOID EXCESSIVE STRESSES AND TO HOLD STRUCTURAL ELEMENTS IN PLACE DURING CONSTRUCTION.
- SUBMIT SHOP DRAWINGS FOR ALL PRE-FABRICATED ITEMS SUCH AS REINFORCING STEEL AND ACCESSORIES, STRUCTURAL STEEL JOISTS, STEEL DECK, PRECAST CONCRETE, LIGHT GAUGE METAL FRAMING AND CONCRETE MIX DESIGNS. CONTRACTOR SHALL REVIEW SHOP DRAWINGS BEFORE SUBMITTING TO ENGINEER. FABRICATE ITEMS AFTER REVIEW BY ENGINEER.
- JOBSITE SAFETY IS THE CONTRACTOR'S RESPONSIBILITY.
- CONTRACTOR SHALL CONFORM WITH ALL OSHA REGULATIONS.
- THE ENGINEER/ARCHITECT IS NOT RESPONSIBLE FOR THE MEANS AND METHODS OF CONSTRUCTION OR THE SAFETY OF THE JOB SITE. THESE RESPONSIBILITIES ARE INTENDED TO REMAIN SOLELY THOSE OF THE CONTRACTOR.
- ALL MATERIAL INSTALLATIONS SHALL BE INSTALLED PER THE MANUFACTURERS' RECOMMENDATIONS.
- THE STRUCTURAL PLANS AND DETAILS HAVE NOT BEEN INVESTIGATED FOR POTENTIAL ERECTION AND CONSTRUCTION LOADS. CONTRACTOR SHALL BE RESPONSIBLE FOR ANY INVESTIGATION OF THE STRUCTURAL FRAMING FOR ERECTION OR CONSTRUCTION LOADS.
- WHEN REFERENCED IN THE PLANS AND DETAILS, THE FOLLOWING POST-INSTALLED ANCHORS SHALL BE PERMISSIBLE. CONTRACTOR SHALL SUBMIT SUBSTITUTION REQUEST FOR ANY ALTERNATE POST-INSTALLED ANCHORS.
 - ADHESIVE/EPOXY ANCHORS
 - HILTI-HY 200, HY 150 MAX
 - POWERS-AC108+ GOLD
 - EXPANSION ANCHORS
 - HILTI-KWIK BOLT TZ
 - POWERS - POWER-STUD+ S02

EXISTING CONSTRUCTION/CONDITIONS:

- CONTRACTOR SHALL FIELD VERIFY ALL DIMENSIONS AND ELEVATIONS CORRESPONDING TO THE LOCATION OF EXISTING ELEMENTS (COLUMNS, BEAMS, WALLS, ETC.).
- CONTRACTOR SHALL FIELD VERIFY EXISTING CONDITIONS AND NOTIFY ARCHITECT/ENGINEER OF ANY CONFLICTS WITH CONSTRUCTION DOCUMENTS.
- REMOVE AND REPLACE AND/OR MODIFY ALL EXISTING CONSTRUCTION (ARCHITECTURAL, STRUCTURAL, ELECTRICAL, MECHANICAL) AS REQUIRED IN ORDER TO PLACE NEW STRUCTURAL WORK SHOWN ON THE CONSTRUCTION DOCUMENTS.
- CONTRACTOR SHALL DESIGN AND PROVIDE ALL SHORING REQUIRED TO SUPPORT EXISTING CONSTRUCTION AND NEW CONSTRUCTION AS REQUIRED.

FOUNDATION:

- ALLOWABLE SOIL BEARING - 2,000 PSF. SEE GEOTECHNICAL REPORT PREPARED BY RIVER VALLEY TESTING, DATED MAY 9, 2016.
- CONTRACTOR SHALL OBTAIN A SOILS ENGINEER TO INSPECT SUB-GRADE AFTER EXCAVATION TO VERIFY SOIL BEARING PRESSURES. AT THE DIRECTION OF THE GEOTECHNICAL ENGINEER, REMOVE UNSATISFACTORY SOILS TO AN ELEVATION WHERE SATISFACTORY SOIL IS ENCOUNTERED. REPLACE UNSATISFACTORY SOIL w/ EITHER COMPACTED STRUCTURAL FILL OR CONCRETE SLURRY - SEE GEOTECHNICAL REPORT.
- PLACE FOUNDATION CONCRETE ON CLEAN FIRM BEARING SOILS MATERIAL.
- WALL FOOTINGS ARE CENTERED ON WALLS (U.N.O.) COLUMN FOOTINGS ARE CENTERED ON COLUMNS (U.N.O.)
- MINIMUM DEPTH TO ALL EXTERIOR FOOTINGS SHALL BE 4'-0" BELOW GRADE.
- INSTALL 2" THICK RIGID INSULATION VERTICALLY AT ALL EXTERIOR FOUNDATION LOCATIONS. USE EXTRUDED POLYSTYRENE INSULATION WITH R=10. SEE ARCHITECTURAL PLANS FOR LOCATION.
- CONTRACTOR TO CONSULT WITH LOCAL AUTHORITIES PRIOR TO EXCAVATION TO LOCATE UNDERGROUND GAS, SEWER, WATER, AND ELECTRICAL OBSTACLES.
- STRUCTURAL FILL

LOCATION:	ALL BACKFILL WITHIN 5'-0" OF THE BUILDING LINES, BELOW STRUCTURAL FOUNDATIONS, AND BEHIND RETAINING WALLS WITHIN A WEDGE EXTENDING UPWARDS 45 DEGREES FROM THE BACK FACE OF RETAINING WALL FOOTINGS.
TYPE:	PREDOMINANTLY WELL GRADED GRANULAR MATERIAL, UNLESS MORE STRINGENT REQUIREMENTS ARE SPECIFIED BY THE PROJECT GEOTECHNICAL ENGINEER, PROVIDE MATERIAL WITH 100% PASSING THE 3" SIEVE, 70-100% PASSING THE #4 SIEVE AND LESS THAN 15% PASSING THE #200 SIEVE.
COMPACTION:	UNLESS MORE STRINGENT REQUIREMENTS ARE SPECIFIED BY THE PROJECT GEOTECHNICAL ENGINEER, COMPACT TO 95% MODIFIED PROCTOR (ASTM: D1557) PLACED IN LIFTS NOT TO EXCEED 8".
- IN AREAS OF COMPACTED FILL WITHIN THE BUILDING LINES, BACKFILLING AGAINST BOTH SIDES OF WALLS SHALL BE DONE AT THE SAME RATE TO PREVENT STRESS AND OVERTURNING OF FOUNDATION WALLS.
- ALL EARTHWORK WITH ON-SITE MATERIALS SHOULD BE PERFORMED WHEN TEMPERATURES ARE ABOVE FREEZING. FROZEN SOIL SHOULD NOT BE USED BENEATH STRUCTURES. ALL FOUNDATION EXCAVATION MUST BE INSULATED AGAINST FREEZING UNTIL CONSTRUCTION OF FOUNDATION IS COMPLETE.
- SOILS THAT BECOME RUTTED OR DISTURBED BY CONSTRUCTION VEHICLES WILL BE UNSUITABLE FOR SUPPORTING FOUNDATION AND CONCRETE SLABS. THE SOILS SHALL BE REMOVED AND REPLACED WITH COMPACTED STRUCTURAL FILL.
- NO SOIL DISTURBANCES, HOLES, OR TRENCHES ARE PERMITTED BELOW FOOTINGS, WITHIN A WEDGE EXTENDING DOWNWARDS 45 DEGREES FROM THE BOTTOM EDGE OF THE FOOTING. FOOTINGS SHALL BE STEPPED DOWN AS REQUIRED TO AVOID SUCH DISTURBANCES.

CONCRETE:

- CONCRETE AND ITS PLACEMENT SHALL BE IN ACCORDANCE WITH ACI 318, ACI 301, AND THE PROJECT SPECIFICATIONS, EXCEPT AS MODIFIED BELOW. PROTECT ALL CONCRETE IN ACCORDANCE WITH ACI STANDARDS FOR HOT & COLD WEATHER CONCRETING.
- STANDARD WEIGHT CONCRETE SHALL COMPLY WITH THE FOLLOWING:
 - MINIMUM COMPRESSIVE STRENGTH (AT 28 DAYS) - 4,000 PSI
 - MAXIMUM WATER/CEMENT RATIO - .45 (AIR ENTRAINED)
 - MAXIMUM AGGREGATE SIZE - .52 (NON-AIR ENTRAINED)
 - TOTAL AIR CONTENT - .34% (TYPICAL)
 - MAX SLUMP - 1 1/2" (FOOTINGS GREATER THAN 12" THICK)
 - REINFORCING BARS: PROVIDE DEFORMED BARS COMPLYING WITH ASTM A615 GRADE 60.
 - WELDED WIRE FABRIC: ASTM A185, COLD DRAWN STEEL PLAN.
 - NO ADMIXTURES WITHOUT REVIEW FROM ENGINEER. ADMIXTURES CONTAINING CHLORIDES SHALL NOT BE USED.
- CONCRETE COVERAGE FOR REINFORCING (U.N.O.):
 - UNFORMED CONCRETE IN CONTACT WITH EARTH = 3"
 - FORMED CONCRETE IN CONTACT WITH EARTH = 2"
 - OTHER CONCRETE = 1 1/2"
- LAP SPLICES SHALL BE THE FOLLOWING BAR DIAMETERS UNLESS NOTED OTHERWISE ON DRAWINGS. LOCATE SPLICES AT POINT OF MINIMUM STRESS. WELDED SPLICES ARE NOT PERMITTED.

REINFORCEMENT	LAP LENGTH IN BAR DIAMETERS
#3 THROUGH #6	38
#7 THROUGH #11	48
- HORIZONTAL REINFORCEMENT SO PLACED THAT MORE THAN 12 INCH OF CONCRETE IS CAST BELOW THE REINFORCEMENT (I.E. HORIZONTAL WALL REINFORCEMENT AND TOP BEAM REINFORCEMENT)

REINFORCEMENT	LAP LENGTH IN BAR DIAMETERS
#3 THROUGH #6	50
#7 THROUGH #11	62
- WELDED WIRE FABRIC - MESH SPACE +2".
- COMPLY WITH ACI 301. POSITION, SUPPORT AND SECURE REINFORCEMENT AGAINST DISPLACEMENT. LOCATE AND SUPPORT WITH METAL CHAIRS, RUNNERS, BOLSTERS, SPACERS, AND HANGERS, AS REQUIRED. SET WIRE TIES SO ENDS ARE DIRECTED INTO CONCRETE, NOT TOWARD EXPOSED CONCRETE SURFACES.
- RE-ENTRANT CORNERS: AT ALL RE-ENTRANT CORNERS IN SLABS, WALLS AND TOPPING, THE CONTRACTOR SHALL INSTALL TWO (2) #3x3'-0" LONG, EACH MAT, AT 3-INCH O.C.
- PROVIDE BENT CORNER BARS TO MATCH AND LAP HORIZONTAL BARS AT CORNERS AND INTERSECTIONS OF WALLS AND FOOTING.
- PROVIDE DOWELS OF SAME SIZE AND SPACING AS VERTICAL WALL OR COLUMN REINFORCING, WITH STANDARD HOOKS, AT THE FOUNDATION (U.N.O.)
- MAXIMUM FREE DROP OF ALL CONCRETE = 2'-0".
- CONCRETE CAN ONLY BE PLACED ON A FROST-FREE SUBGRADE
- MECHANICALLY VIBRATE ALL CONCRETE.
- PROVIDE A 3/4"x3/4" CHAMFER ON ALL EXPOSED CORNERS OF CONCRETE, UNLESS CONCRETE IS ADJACENT TO GRATING.
- ALL CAST-IN-PLACE CONCRETE SHALL BE PROTECTED AGAINST RAPID DRYING AND MUST BE KEPT MOIST FOR A MINIMUM OF (7) DAYS FOR NOMINAL CONCRETE.
- AT LEAST 24 HOURS SHALL PASS BETWEEN POURING ADJACENT CONCRETE SECTIONS BETWEEN CONSTRUCTION JOINTS.
- CONSTRUCTION JOINTS SHALL BE PROVIDED AT A MAXIMUM OF 40'-0" o.c. (U.N.O.).
- PIPES OR CONDUIT ENCASED WITHIN OR PASSING THROUGH CONCRETE SHALL COMPLY WITH STRUCTURAL DETAILS, AND THE FOLLOWING CRITERIA:
 - HAVE A MINIMUM OF 2" OF CONCRETE CLEAR COVER.
 - DOES NOT INTERFERE OR DISPLACE WITH REINFORCING BARS, UNLESS SPECIFICALLY DETAILED OTHERWISE.
 - SPACED AT LEAST THREE PIPE DIAMETERS AWAY FROM ADJACENT PIPES, UNLESS SPECIFICALLY DETAILED OTHERWISE.
 - ALUMINUM CONDUIT SHALL NOT BE ENCASED IN CONCRETE.
 - AT CONCRETE BEAMS, AN ADDITIONAL STIRRUP SHALL BE PROVIDED AT EACH SIDE OF THE PIPE.
- CONCRETE FIELD TESTS FOR SLUMP, AIR CONTENT, YIELD AND STRENGTH SHALL BE CONDUCTED BY A CERTIFIED CONCRETE TECHNICIAN IN ACCORDANCE WITH ACI 301. TESTS SHALL BE SUBMITTED TO ENGINEER FOR REVIEW.
- PROVIDE WATERSTOP JOINTS AT ALL CONSTRUCTION JOINTS BELOW THE GROUNDWATER TABLE, WITHIN ALL WATER-RETAINING TANKS, AND AT ADDITIONAL LOCATIONS AS INDICATED ON THE PLANS.

REINFORCEMENT	LAP LENGTH IN BAR DIAMETERS
#3 THROUGH #6	38
#7 THROUGH #11	48

REINFORCEMENT	LAP LENGTH IN BAR DIAMETERS
#3 THROUGH #6	50
#7 THROUGH #11	62

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REINFORCEMENT	LAP LENGTH IN BAR DIAMETERS
#3 THROUGH #6	50
#7 THROUGH #11	62

MASONRY:

- COMPLY WITH RECOMMENDATIONS OF BRICK INSTITUTE OF AMERICA (BIA), NATIONAL CONCRETE MASONRY ASSOCIATION (NCMA), AND ACI 530. PROTECT ALL MASONRY IN ACCORDANCE WITH ACI STANDARDS FOR HOT & COLD WEATHER CONCRETING.
- MASONRY SHALL COMPLY WITH THE FOLLOWING:
 - COMPRESSIVE STRENGTH - 2,000 PSI
 - MAXIMUM WATER/CEMENT RATIO - .45 (AIR ENTRAINED)
 - MORTAR - TYPE S = 2,000 PSI ABOVE GRADE
- TYPE M = 2,000 PSI BELOW GRADE
 - MORTAR - ASTM A615, GRADE 60
 - ASSEMBLY COMPRESSIVE STRENGTH - 2,000 PSI (fm)
- ADMIXTURES CONTAINING CHLORIDES SHALL NOT BE USED.
- SPECIAL SHAPES: PROVIDE SPECIAL BLOCK TYPES WHERE REQUIRED FOR CORNERS, CONTROL JOINTS, HEADERS, LINTELS AND OTHER SPECIAL CONDITIONS.
- ALL MASONRY SHALL BE LAID PLUMB, TRUE TO LINE, AND WITH LEVEL COURSES. LAY IN RUNNING BOND, OVERLAY CORNER BLOCK UNITS.
- CONTRACTOR SHALL DESIGN TEMPORARY BRACING AS REQUIRED TO STABILIZE MASONRY WALLS UNTIL PERMANENT SUPPORTS ARE INSTALLED.
- SEE PLANS FOR VERTICAL MASONRY CONTROL JOINT LOCATIONS.

GUIDELINES:	LOCATE FIRST JOINT 10'-0" FROM EACH CORNER AND 22'-0" MAX. SPACING ON CENTER BETWEEN JOINTS. DO NOT LOCATE JOINTS AT WINDOWS OR DOORS.
	MAXIMUM GROUT LIFT WITHOUT CLEAN-OUTS = 4'-0".
	MAXIMUM GROUT LIFT WITH CLEAN-OUTS = 8'-0".
- FULL MORTAR BED JOINTS ARE REQUIRED, TYPICAL.
- ALL VERTICAL REINFORCING SHALL BE CONTINUOUSLY GROUTED IN CELLS.
- PLACE HOOKED DOWELS AT ALL VERTICAL MASONRY REINFORCING LOCATIONS INTO FOUNDATION SYSTEM.
- DOOR AND WINDOW JAMBS SHALL BE SOLID GROUTED 8" MINIMUM WIDTH (U.N.O.)
- BOND BEAMS AND PILASTERS SHALL HAVE REINFORCEMENT AS INDICATED ON DRAWINGS, AND SHALL BE SOLID GROUTED.
- BELOW STEEL BEAM BEARING LOCATIONS, MASONRY SHALL BE SOLID GROUTED TO A MINIMUM OF 16" DEEP BY 32" WIDE (U.N.O.)
- LAP SPLICES IN MASONRY 48 BAR DIAMETERS.
- JOINT REINFORCEMENT - NEW MASONRY WALLS TO BE REINFORCED WITH 9 GAUGE DUR-O-WAL EVERY OTHER BLOCK COURSE.
- ON EXTERIOR WALLS, PROVIDE WEEP HOLES TO THE EXTERIOR ABOVE LINTELS AND AT BOTTOM OF WALL.
- SEE ARCHITECTURAL PLANS FOR REQUIRED FIRE RATINGS.
- CHECK ELECTRICAL PLANS TO LOCATE ANY ELECTRICAL CONDUIT TO BE INSTALLED IN MASONRY CORE.

STRUCTURAL STEEL:

- ALL DETAILING, FABRICATION AND ERECTION SHALL CONFORM TO ANSIAISC 360 AND AISC 303.
- STRUCTURAL STEEL SHALL MEET THE FOLLOWING MINIMUM YIELD STRENGTHS AND SPECIFICATIONS.

STEEL SHAPES	ASTM A992
ANGLES & RODS	ASTM A36
PLATES	ASTM A36
STRUCTURAL TUBES	ASTM A500 GRADE B
ANCHOR BOLTS	F1554 GRADE 36
STRUCTURAL BOLTS	ASTM A325 TYPE N
WELDS	E70 XX
GROUT	ASTM C1107, GRADE B, PREMIXED NON-SHRINK, NON-METALLIC, CEMENTITIOUS GROUT. MINIMUM COMPRESSIVE STRENGTH 7000 PSI.
- ALL WELDING SHALL BE PERFORMED BY A CERTIFIED WELDER IN ACCORDANCE WITH A.W.S. CODE FOR WELDING IN BUILDING CONSTRUCTION. SURFACES FOR FIELD WELDED MATERIAL SHALL BE PROPERLY PREPARED PRIOR TO BEING WELDED TO ASSURE A GOOD QUALITY WELD. REMOVE PAINT, GREASE, DIRT, ETC.
- THE FABRICATOR SHALL BE RESPONSIBLE FOR THE DESIGN AND ADEQUACY OF ALL CONNECTIONS THAT ARE NOT DESIGNED AND FULLY DETAILED ON THE CONTRACT DOCUMENTS. CONNECTIONS SHALL BE DESIGNED AND DETAILED IN ACCORDANCE WITH ANSIAISC 360. BEAM CONNECTIONS SHALL BE 'SIMPLE FRAMING' TYPE N (UNLESS NOTED OTHERWISE).
- PROVIDE DOUBLE NUTS AND WASHERS FOR ALL STEEL COLUMN ANCHOR BOLTS TO ALLOW FOR ADJUSTMENT IN BASE PLATE ELEVATION. PROVIDE 1 1/2" OF NON-SHRINK GROUT UNDER PLATE AFTER ERECTION.
- SET COLUMN BASES AT CORRECT ELEVATION ON FULL BED OF NON-SHRINK GROUT.
- ERECTION: COMPLY WITH AISC CODE AND SPECIFICATIONS. THE ERECTOR SHALL FURNISH AND INSTALL TEMPORARY SUPPORTS TO SECURE ANY ELEMENT OR ELEMENTS OF THE STEEL FRAMING UNTIL THEY ARE MADE STABLE WITHOUT EXTERNAL SUPPORT.
- PROVIDE ALL LOOSE LINTELS AND MISCELLANEOUS STRUCTURAL STEEL AS SHOWN ON DRAWINGS.
- DO NOT PRIME SURFACES THAT WILL BE FIELD WELDED.
- SEE ARCHITECTURAL PLANS FOR LOCATIONS OF ADDITIONAL MISCELLANEOUS STEEL MEMBERS.
- SEE SPECIFICATIONS MANUAL FOR REQUIRED STEEL SURFACE PREPARATION AND PAINT REQUIREMENTS.

STEEL JOISTS:

- PROVIDE OPEN WEB STEEL JOISTS COMPLYING WITH REQUIREMENTS OF STANDARD SPECIFICATIONS FOR OPEN WEB JOISTS, LH SERIES, SJI/AISC.
- PROVIDE DIAGONAL TYPE AND HORIZONTAL TYPE BRIDGING AND END ANCHORAGE COMPLYING WITH SJI SPECIFICATIONS. IF ADDITIONAL BRIDGING IS REQUIRED FOR UPLIFT, STEEL JOIST SUPPLIER SHALL NOTIFY CONTRACTOR AND STEEL ERECTOR. THIS SHALL INCLUDE HORIZONTAL BRIDGING AT THE BOTTOM CHORD OF THE FIRST PANEL POINT OF EACH JOIST.
- PROVIDE EXTENDED ENDS FOR TOP CHORDS OF JOISTS WHERE REQUIRED. REFER TO DRAWINGS FOR SIZE AND LOCATIONS.
- PROVIDE BEVELED ENDS OR SLOPED SHOES ON SLOPED JOISTS. INSTALL JOISTS SO THAT THEIR WEBS ARE IN A VERTICAL PLANE.
- SEE PLANS FOR SPECIAL LOADING CONSIDERATION.
- STEEL JOISTS SHALL BE FURNISHED SHOP PRIMED WITH JOIST MANUFACTURER'S STANDARD RED OXIDE PRIMER.
- ERECTION OF STEEL JOISTS SHALL BE IN ACCORDANCE WITH SJI AND AISC STANDARDS.
- WHERE JOISTS BEAR ON STEEL BEAMS, WELD OR BOLT ALL BEARING POINTS IN ACCORDANCE WITH SJI SPECIFICATIONS.
- INSTALL BRIDGING IN PROPER ALIGNMENT SECURELY WELDED TO CHORDS OF JOISTS AND SPLICES, AND SECURED AT ENDS OF RUNS. WELD TO PARALLEL STEEL BEAMS. BRIDGING TO BE INSTALLED BEFORE PLACEMENT OF METAL ROOF DECK.
- FIELD WELDING COMPONENTS INDICATED ON DRAWINGS AND SHOP DRAWINGS.
- JOISTS SHALL BE DESIGNED FOR AN UPLIFT FORCE AS INDICATED ON NET UPLIFT PLAN. PROVIDE ADDITIONAL BRIDGING AND BRACING AS REQUIRED BY SJI.

STEEL DECK:

- ALL DETAILING, FABRICATION, AND ERECTION SHALL CONFORM TO THE STEEL DECK INSTITUTE.
- ALL STEEL DECK SHALL MEET THE FOLLOWING MINIMUM YIELD STRENGTHS AND SPECIFICATIONS:

ROOF DECK - 1 1/2" TYPE B

- WHERE REQUIRED, RIDGE AND VALLEY PLATES, CLOSURES AND ROOF SUMP RECESSES SHALL BE FURNISHED BY DECK SUPPLIER AND SHALL BE ATTACHED DIRECTLY TO THE DECK TO PROVIDE A SUITABLE SURFACE FOR THE APPLICATION OF INSULATION AND ROOFING.
- END LAPS OF SHEETS SHOULD BE A MINIMUM OF 2-INCHES AND SHALL OCCUR OVER SUPPORTING MEMBERS.
- FIELD CUT ALL OPENINGS FOR DUCTS, VENTS, ETC.
- TOUCH-UP PRIME PAINT AFTER ERECTION.
- DECK SUPPLIER SHALL PROVIDE ALL POUR STOPS, COLUMN CLOSURES, AND CLOSURE COVER PLATES AND GIRDER FILERS AS REQUIRED TO CREATE AN ADEQUATE ENCLOSURE FORM FOR THE CONCRETE DECK.
- FLOOR DECK SHALL BE FASTENED TO SUPPORTING MEMBERS W/ #12 TEK AT 16" MIN. AND AT SIDE LAPS W/ #10 TEK AT 36" O.C.

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REVISION



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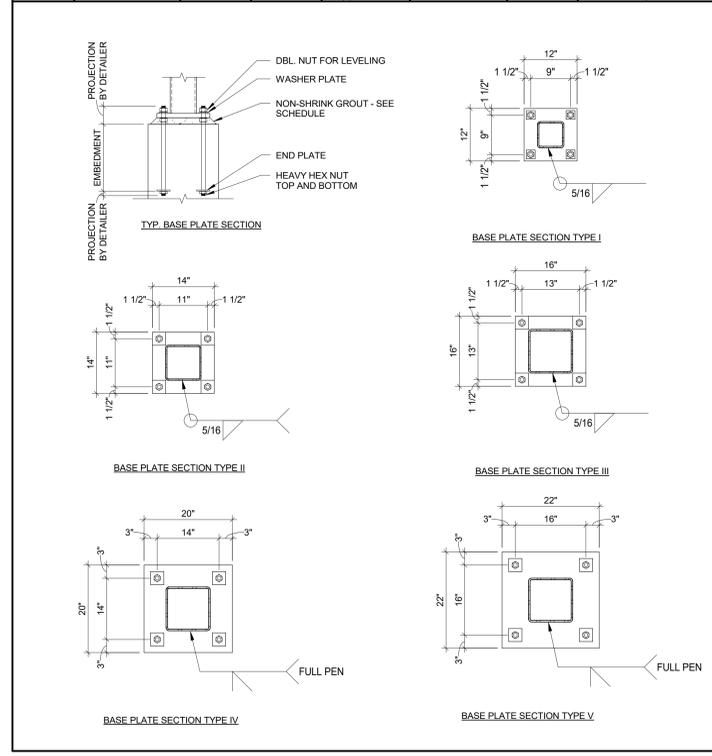
ALTERATION / ADDITION
OUTAGAMIE COUNTY ADMINISTRATION CENTER
S. WALNUT & W. 8TH, APPLETON WI 54911
STRUCTURAL SPECIFICATIONS

MARK	FOOTING SIZE			FOOTING - TOP REINF.	FOOTING - BOTTOM REINF.
	LENGTH	WIDTH	THICKNESS		
F3.0	3'-0"	3'-0"	12"	-	(3) #4 EA. WAY W/ STD. HOOK
F4.0	4'-0"	4'-0"	24"	(4) #5 EA. WAY	(4) #5 EA. WAY
F4.0x5.0	4'-0"	5'-0"	24"	(4) #5 EA. WAY	(4) #5 EA. WAY
F4.0x7.0	4'-0"	7'-0"	24"	(10) #5 SHORT, (7) #8 LONG	(10) #5 SHORT, (7) #8 LONG
F5.0	5'-0"	5'-0"	12"	(5) #5 EA. WAY	(5) #5 EA. WAY
F6.0x10.0	6'-0"	10'-0"	24"	(10) #5 SHORT, (7) #8 LONG	(10) #5 SHORT, (7) #8 LONG
F6.0x14.0	6'-0"	14'-0"	42"	(14) #8 SHORT, (8) #8 LONG	(14) #8 SHORT, (8) #8 LONG
F7.0	7'-0"	7'-0"	14"	(7) #5 EA. WAY	(7) #5 EA. WAY
F8.0x14.0	8'-0"	14'-0"	42"	(14) #8 SHORT, (10) #8 LONG	(14) #8 SHORT, (10) #8 LONG
F9.0	9'-0"	9'-0"	18"	(9) #6 EA. WAY	(9) #6 EA. WAY
F9.0A	9'-0"	9'-0"	18"	(9) #6 EA. WAY	(9) #6 EA. WAY
F10.0	10'-0"	10'-0"	20"	-	-
F11.0	11'-0"	11'-0"	20"	(11) #7 EA. WAY	(11) #7 EA. WAY
F11.0A	11'-0"	11'-0"	20"	(11) #7 EA. WAY	(11) #7 EA. WAY
F12.0	12'-0"	12'-0"	22"	-	(12) #7 EA. WAY
F12.0A	12'-0"	12'-0"	20"	(11) #5 EA. WAY	(11) #7 EA. WAY
F13.0A	13'-0"	13'-0"	24"	(13) #7 EA. WAY	(13) #7 EA. WAY
F14.0	14'-0"	14'-0"	26"	(14) #8 EA. WAY	(14) #8 EA. WAY
F14.0A	14'-0"	14'-0"	26"	(14) #5 EA. WAY	(14) #8 EA. WAY

MARK	WIDTH	LENGTH	REINFORCEMENT			T.O. PIER ELEV. (U.N.O.)
			VERT.	TIES	TYPE	
P18	18"	18"	(4) #6	#4 @ 12"	I	SEE PLAN
P20	20"	20"	(4) #6	#4 @ 12"	I	SEE PLAN
P22	22"	22"	(8) #6	#4 @ 12"	II	SEE PLAN
P26	26"	26"	(8) #8	#4 @ 12"	II	SEE PLAN
P28	28"	28"	(8) #8	#4 @ 12"	II	SEE PLAN



MARK	COLUMN	BASE PLATE		ANCHOR BOLTS	EMBEDMENT	WASHER PLATE	END PLATE	GROUT THICKNESS
		THICKNESS	TYPE					
C1	HSS6X6X5/16	1 1/4"	I	(4) 1" DIA.	12"	3/8"x3"x3"	-	1 1/2"
C2	HSS8X8X5/16	1 1/4"	II	(4) 1" DIA.	12"	3/8"x3"x3"	-	1 1/2"
C2A	HSS8X8X5/16	1 3/4"	IV	(4) 1 3/4" DIA.	30"	5/8"x5"x5"	1/2"x4"x4"	3"
C3	HSS8X8X3/8	1 1/4"	II	(4) 1" DIA.	12"	3/8"x3"x3"	-	1 1/2"
C4	HSS10X10X5/16	1 1/4"	III	(4) 1" DIA.	12"	3/8"x3"x3"	-	1 1/2"
C4A	HSS10X10X5/16	1 3/4"	V	(4) 1 3/4" DIA.	30"	5/8"x5"x5"	1/2"x4"x4"	3"
C5	HSS10X10X3/8	1 1/4"	III	(4) 1" DIA.	12"	3/8"x3"x3"	-	1 1/2"
C5A	HSS10X10X3/8	1 3/4"	V	(4) 1 3/4" DIA.	30"	5/8"x5"x5"	1/2"x4"x4"	3"
C6	HSS5X5X5/16	3/4"	I	(4) 3/4" DIA.	8"	1/4"x2"x2"	-	1 1/2"

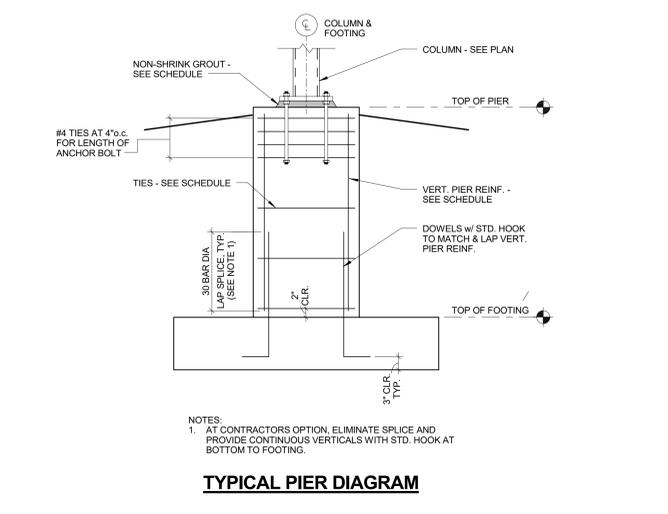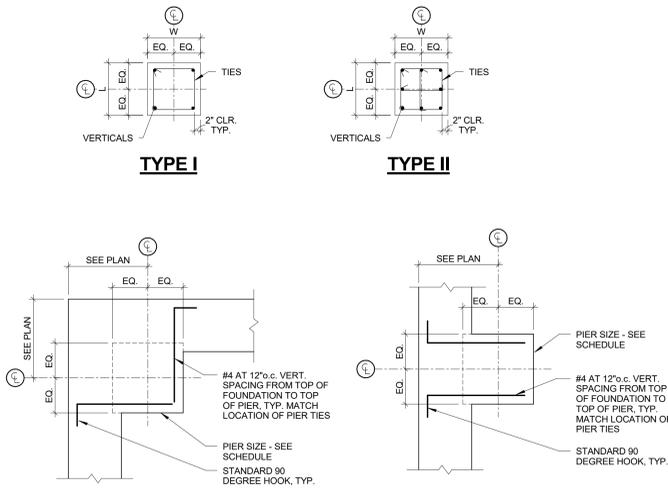


STRUCTURAL ABBREVIATIONS			
BRG	BEARING	SJ	SAWCUT JOINT
CJ	CONTROL JOINT	TBE	TOP OF BEAM ELEVATION
CMU	CONCRETE MASONRY UNIT	TFE	TOP OF FOOTING ELEVATION
DSE	DECK BEARING ELEVATION	TLE	TOP OF LEASE ELEVATION
ELEV	ELEVATION	TPE	TOP OF PIER ELEVATION
JBE	JOIST BEARING ELEVATION	TSE	TOP OF SLAB ELEVATION
LLH	LONG LEG HORIZONTAL	TWE	TOP OF WALL ELEVATION
LLV	LONG LEG VERTICAL	UNO	UNLESS NOTED OTHERWISE
PBE	PRECAST BEARING ELEVATION	WP	WORKING POINT
SF	STEP FOOTING	WWF	WELDED WIRE FABRIC

McMAHON ENGINEERS ARCHITECTS
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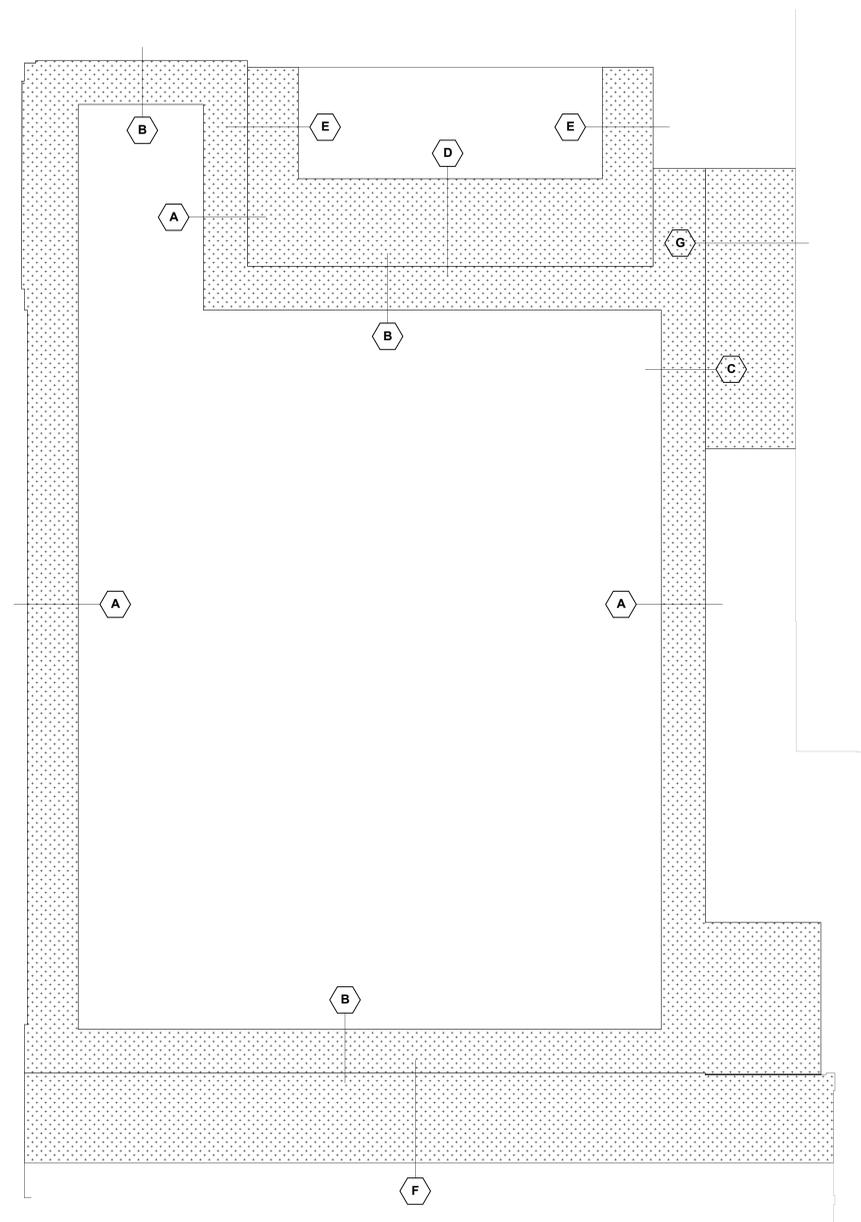
DESIGNED: PEB DRAWN: MLR
 PROJECT NO.: 0002-61600160
 DATE: MARCH 3, 2017
 SHEET NO.: S002

ALTERATION / ADDITION
 OUTAGAMIE COUNTY ADMINISTRATION CENTER
 S. WALNUT & W. 8TH, APPLETON WI 54911
 STRUCTURAL SCHEDULES




UPLIFT PLAN
SCALE: 1/16" = 1'-0"

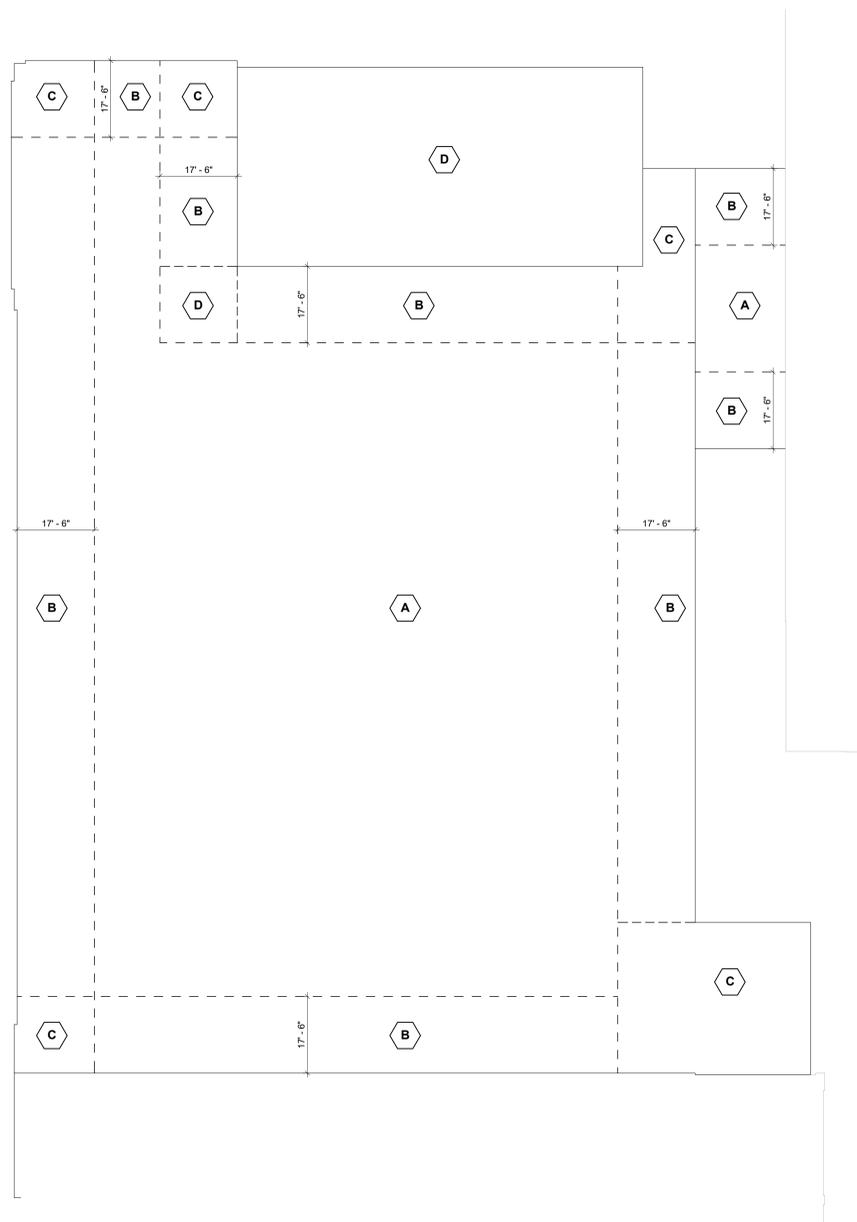NET UPLIFT WIND PRESSURES	
ZONE	PRESSURE (PSF)
A	10.6
B	26.0
C	45.1
D	0



NOTE: EXISTING STRUCTURE ROOF WAS DESIGNED FOR FUTURE FLOOR. UPGRADES FOR SNOW DRIFT LOADS NOT REQUIRED.
SNOW DRIFT PLAN
SCALE: 1/16" = 1'-0"

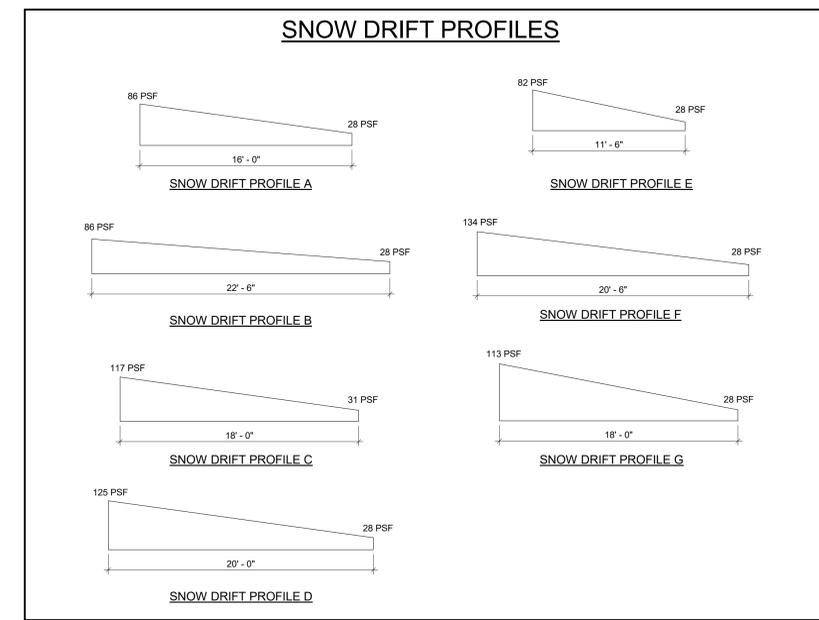


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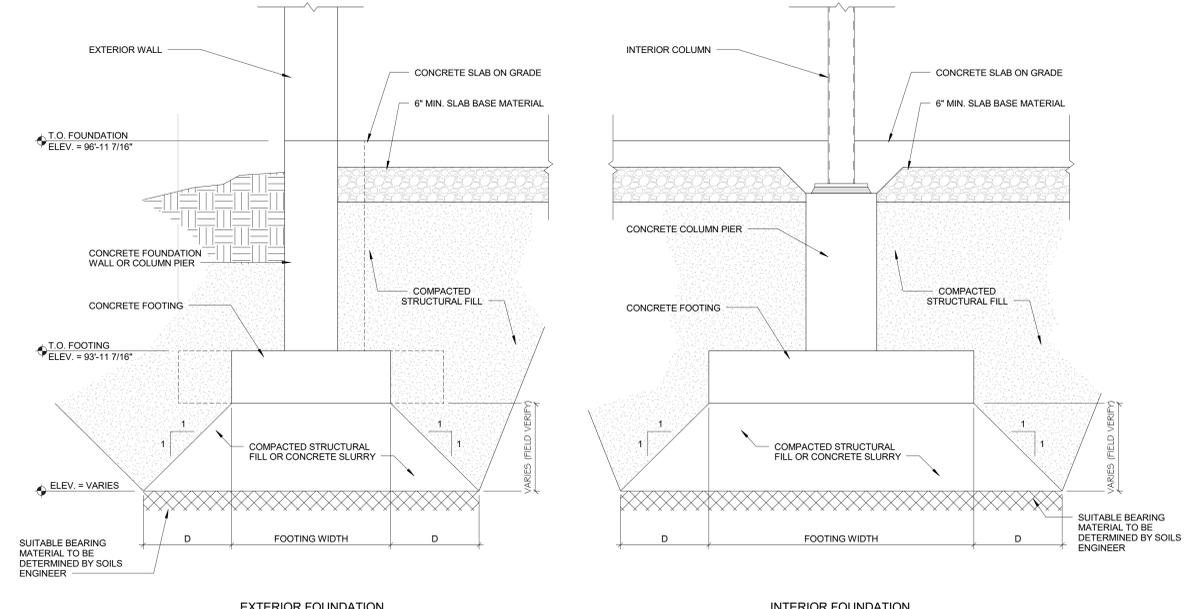
NO.	DATE	REVISION

ALTERATION / ADDITION
OUTAGAMIE COUNTY ADMINISTRATION CENTER
S. WALNUT & W. 8TH, APPLETON WI 54911
NET UPLIFT AND SNOW DRIFT PLANS

DESIGNED PEB	DRAWN MLR
PROJECT NO. 0002-61600160	
DATE MARCH 3, 2017	
SHEET NO.	

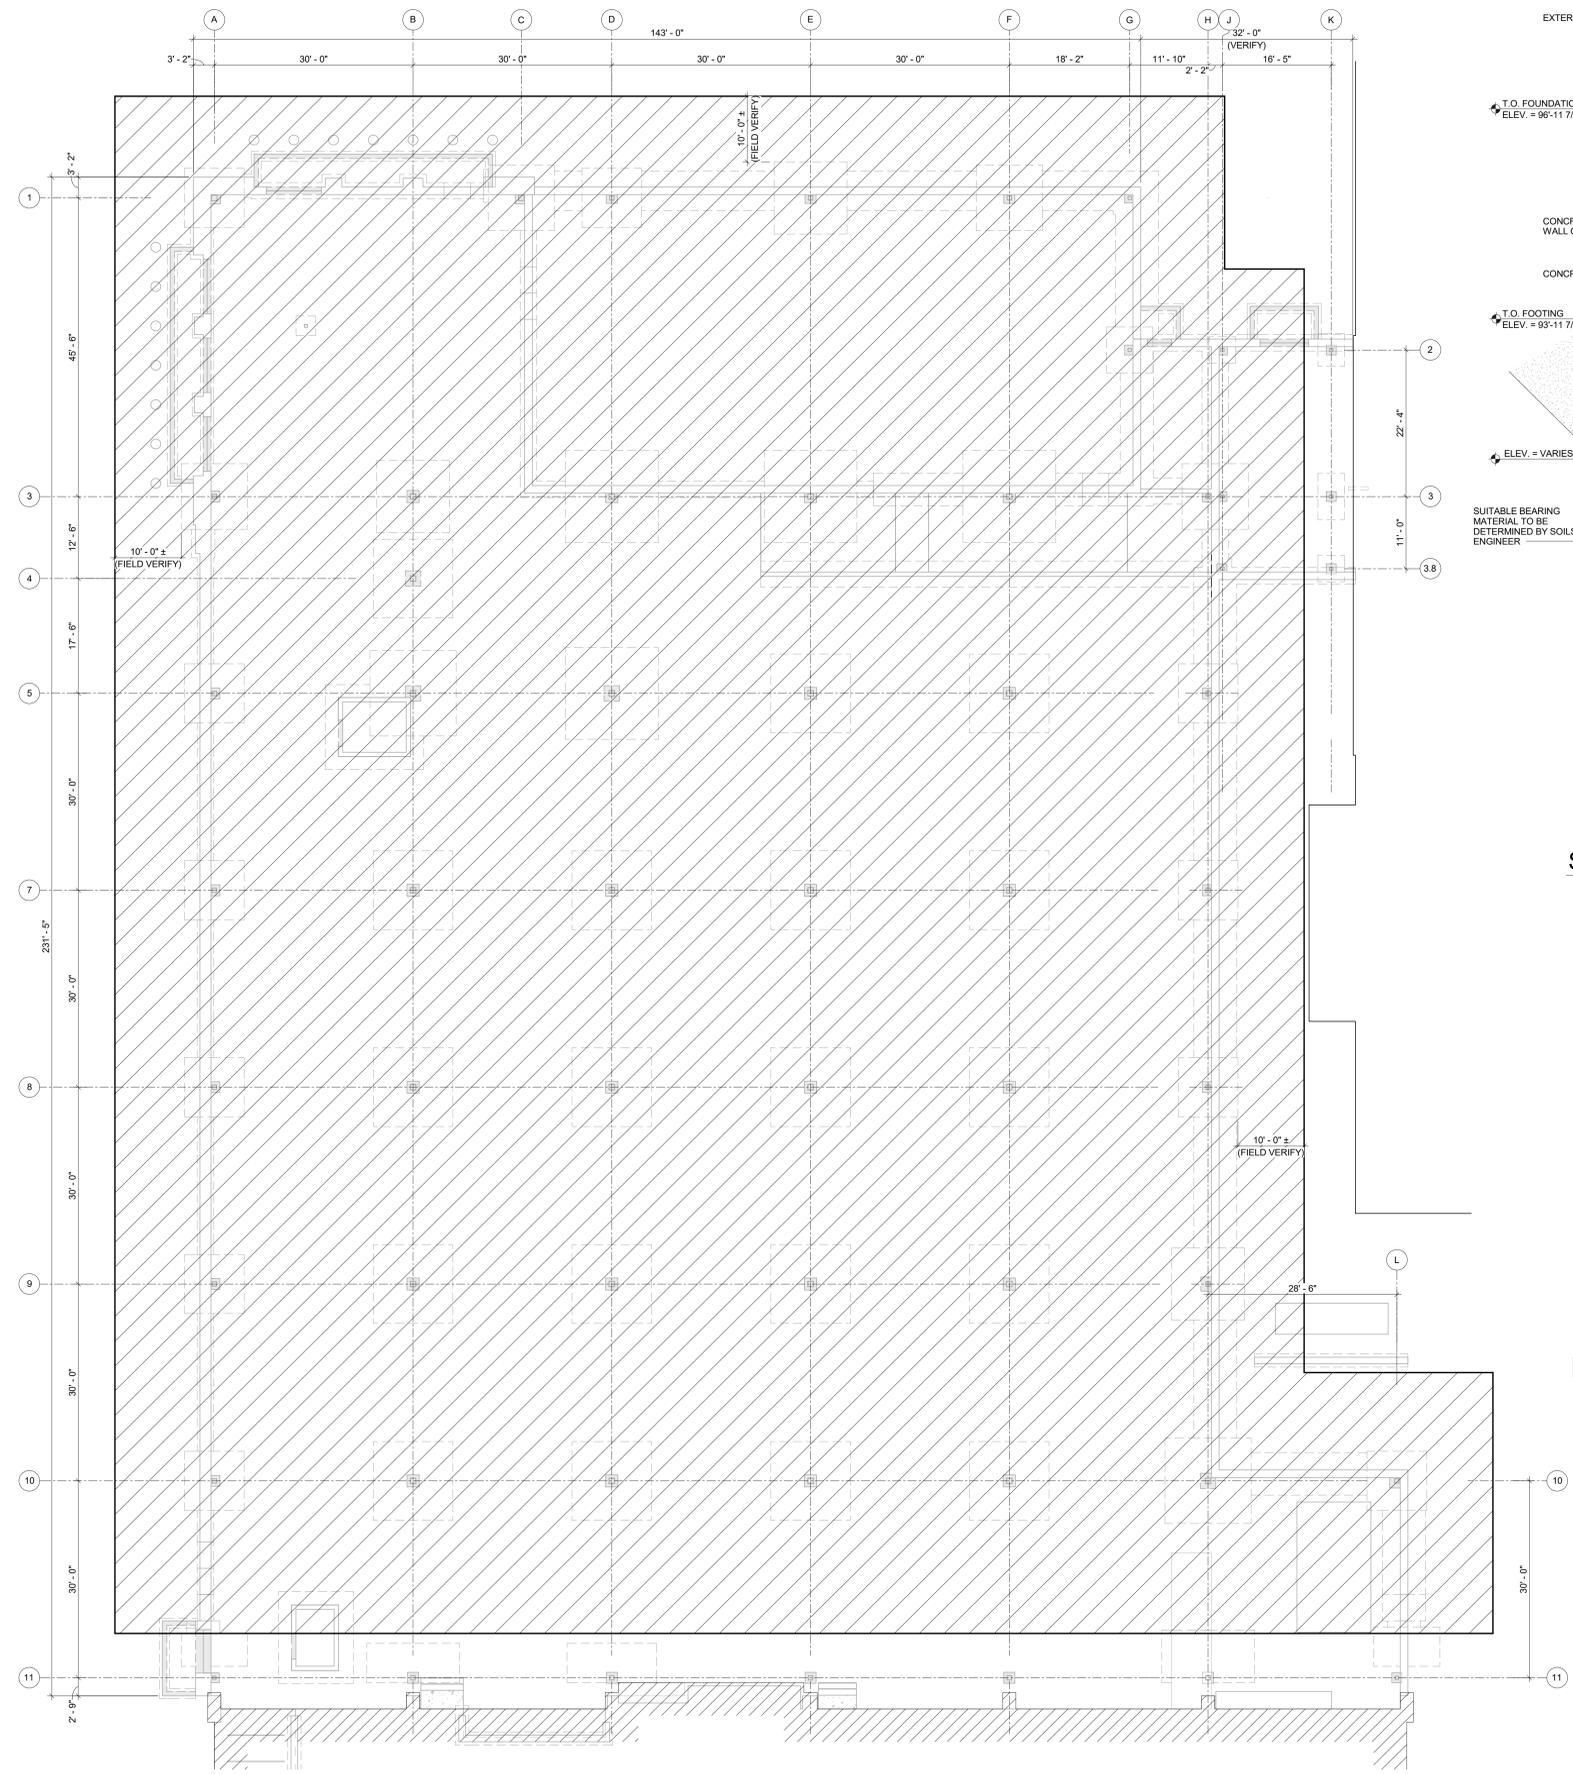

EXCAVATION PLAN
SCALE: 3/32" = 1'-0"




EXTERIOR FOUNDATION **INTERIOR FOUNDATION**

- NOTES:**
1. SEE GEOTECHNICAL REPORT FOR DESCRIPTION OF SUBGRADE CONDITIONS, EXTENTS OF EXCAVATIONS, SITE PREPARATION, ETC.
 2. VAPOR BARRIER SHALL BE PLACED WHERE INDICATED ON ARCHITECTURAL PLANS. VAPOR BARRIER SHALL BE LOCATED ON TOP OF SLAB BASE MATERIAL.
 3. CONTRACTOR SHALL OBTAIN A GEOTECHNICAL ENGINEER TO INSPECT SUB-GRADE AFTER EXCAVATION TO VERIFY SOIL BEARING PRESSURES. AT THE DIRECTION OF THE GEOTECHNICAL ENGINEER, REMOVE UNSATISFACTORY SOILS TO AN ELEVATION WHERE SATISFACTORY SOIL IS ENCOUNTERED. REPLACE UNSATISFACTORY SOIL W/ EITHER COMPACTED STRUCTURAL FILL OR CONCRETE SLURRY - SEE GEOTECHNICAL REPORT.
 4. PRIOR TO CONCRETE PLACEMENT GEOTECHNICAL ENGINEER SHALL PROVIDE A SIGNED/STAMPED COMPLIANCE CERTIFICATE ACKNOWLEDGING THAT SLAB SUBGRADE AND SLAB BASE MATERIAL SATISFY THE REQUIREMENTS DETAILED IN THE PROJECT GEOTECHNICAL REPORT.

SUBGRADE PREP

- HATCHING INDICATES EXTENTS OF OVEREXCAVATION. CONTRACTOR SHALL REMOVE BETWEEN 4'-6" TO 10'-6" OF EXISTING FILL BELOW EXISTING GRADE - SEE CIVIL DRAWINGS FOR EXISTING SITE GRADES.

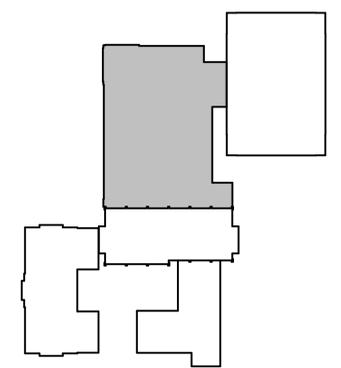


PLAN KEY - ENTIRE BUILDING

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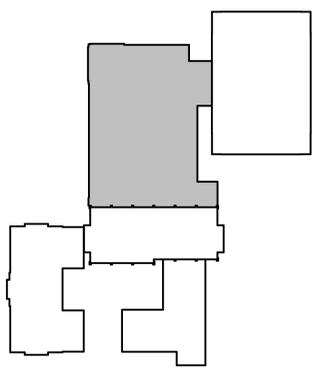
NO.	DATE	REVISION

ALTERATION / ADDITION
OUTAGAMIE COUNTY ADMINISTRATION CENTER
S. WALNUT & W. 8TH, APPLETON WI 54911
EXCAVATION PLAN

DESIGNED	DRAWN
PEB	MLR
PROJECT NO. 0002-61600160	
DATE MARCH 3, 2017	
SHEET NO. S005	

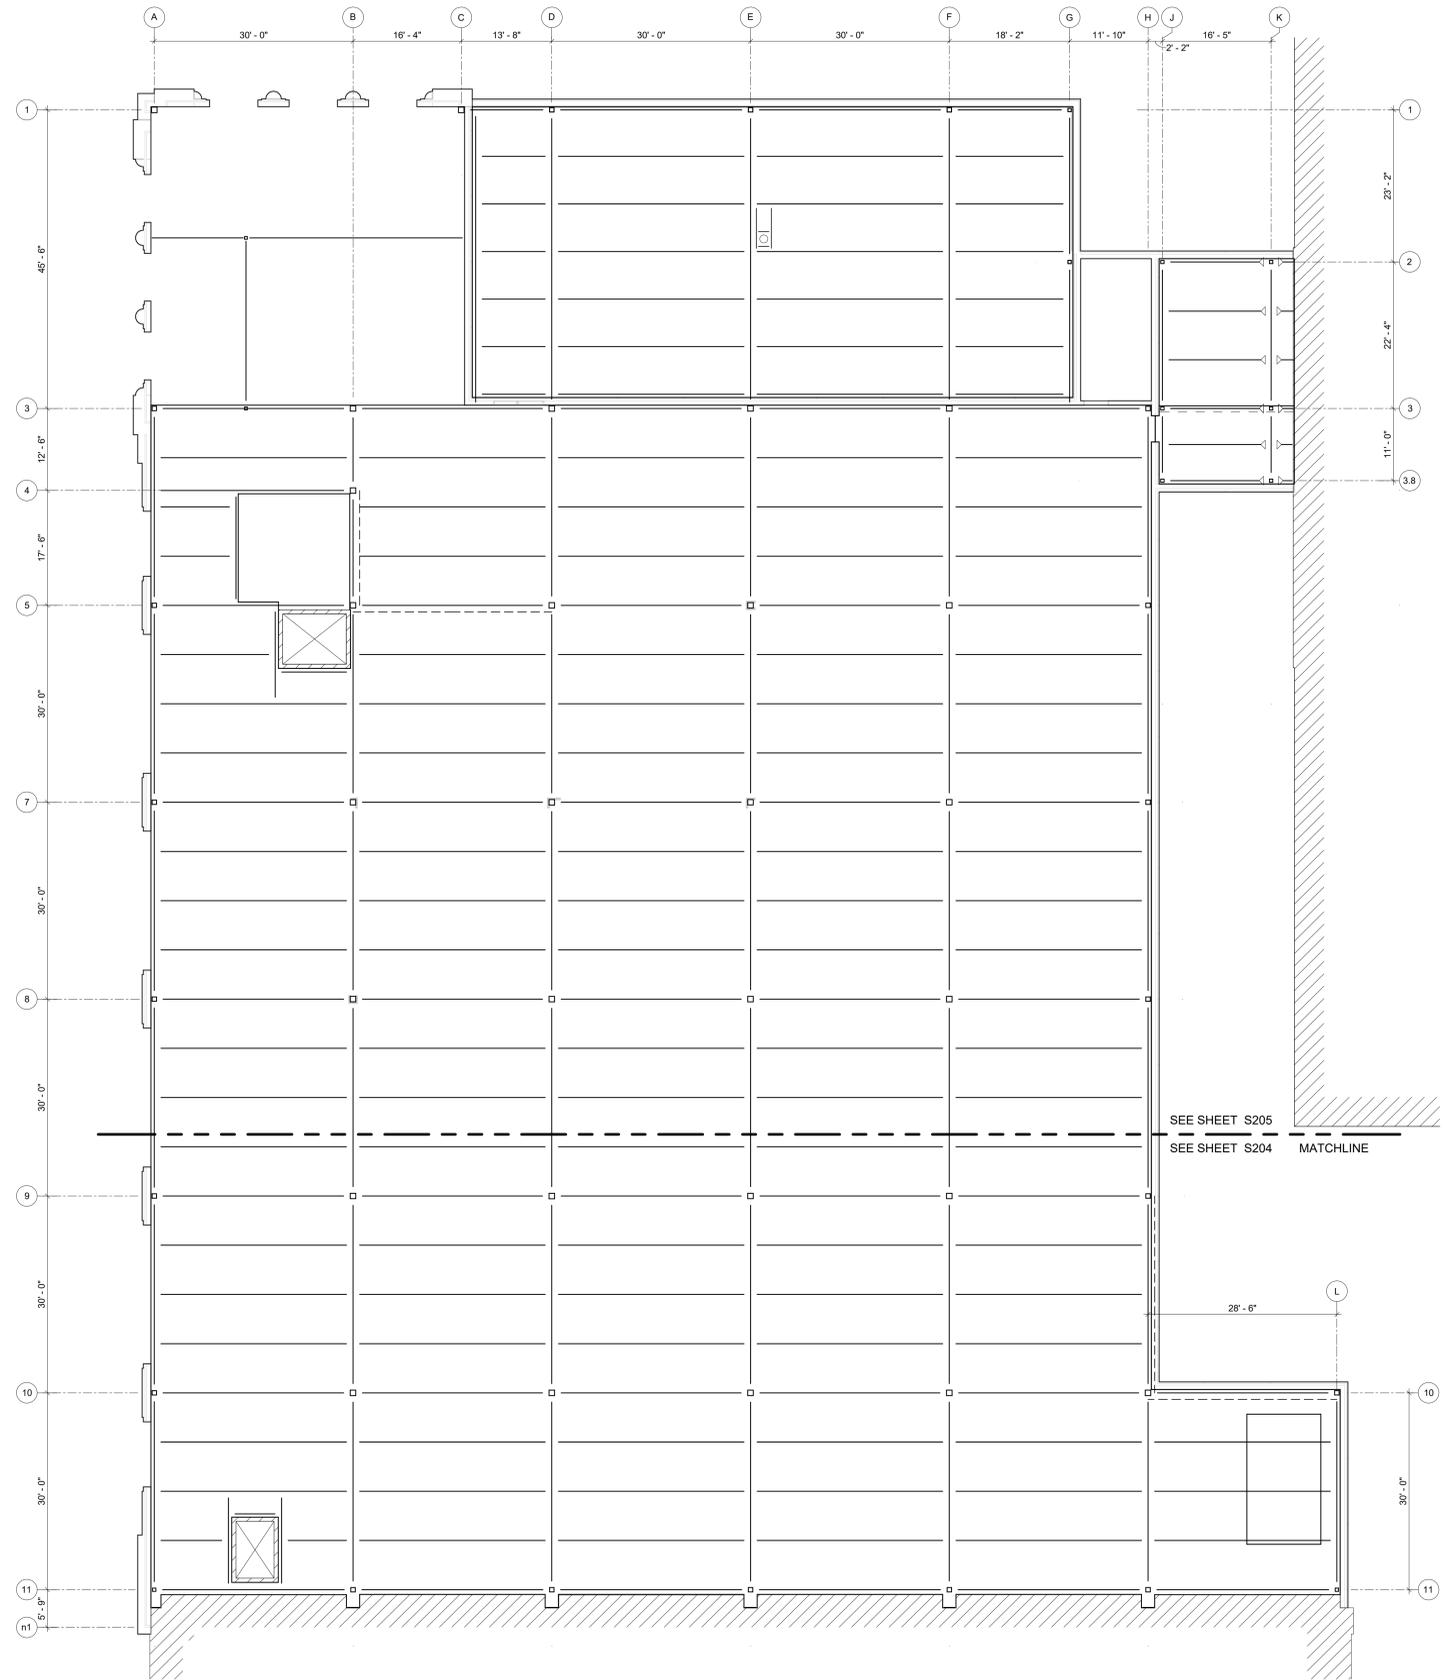

SECOND FLOOR & LOW ROOF FRAMING PLAN NORTH
 SCALE: 3/32" = 1'-0" T.O. STEEL - 112'-8 11/16" (J.N.O.)




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NO.	DATE	REVISION

ALTERATION / ADDITION
OUTAGAMIE COUNTY ADMINISTRATION CENTER
 S WALNUT & W. 8TH - APPLETON WI 54911
 OCAC - OVERALL 2ND FLOOR FRAMING PLAN


DESIGNED PEB	DRAWN MLR
PROJECT NO. 0002-61600160	
DATE MARCH 3, 2017	
SHEET NO.	

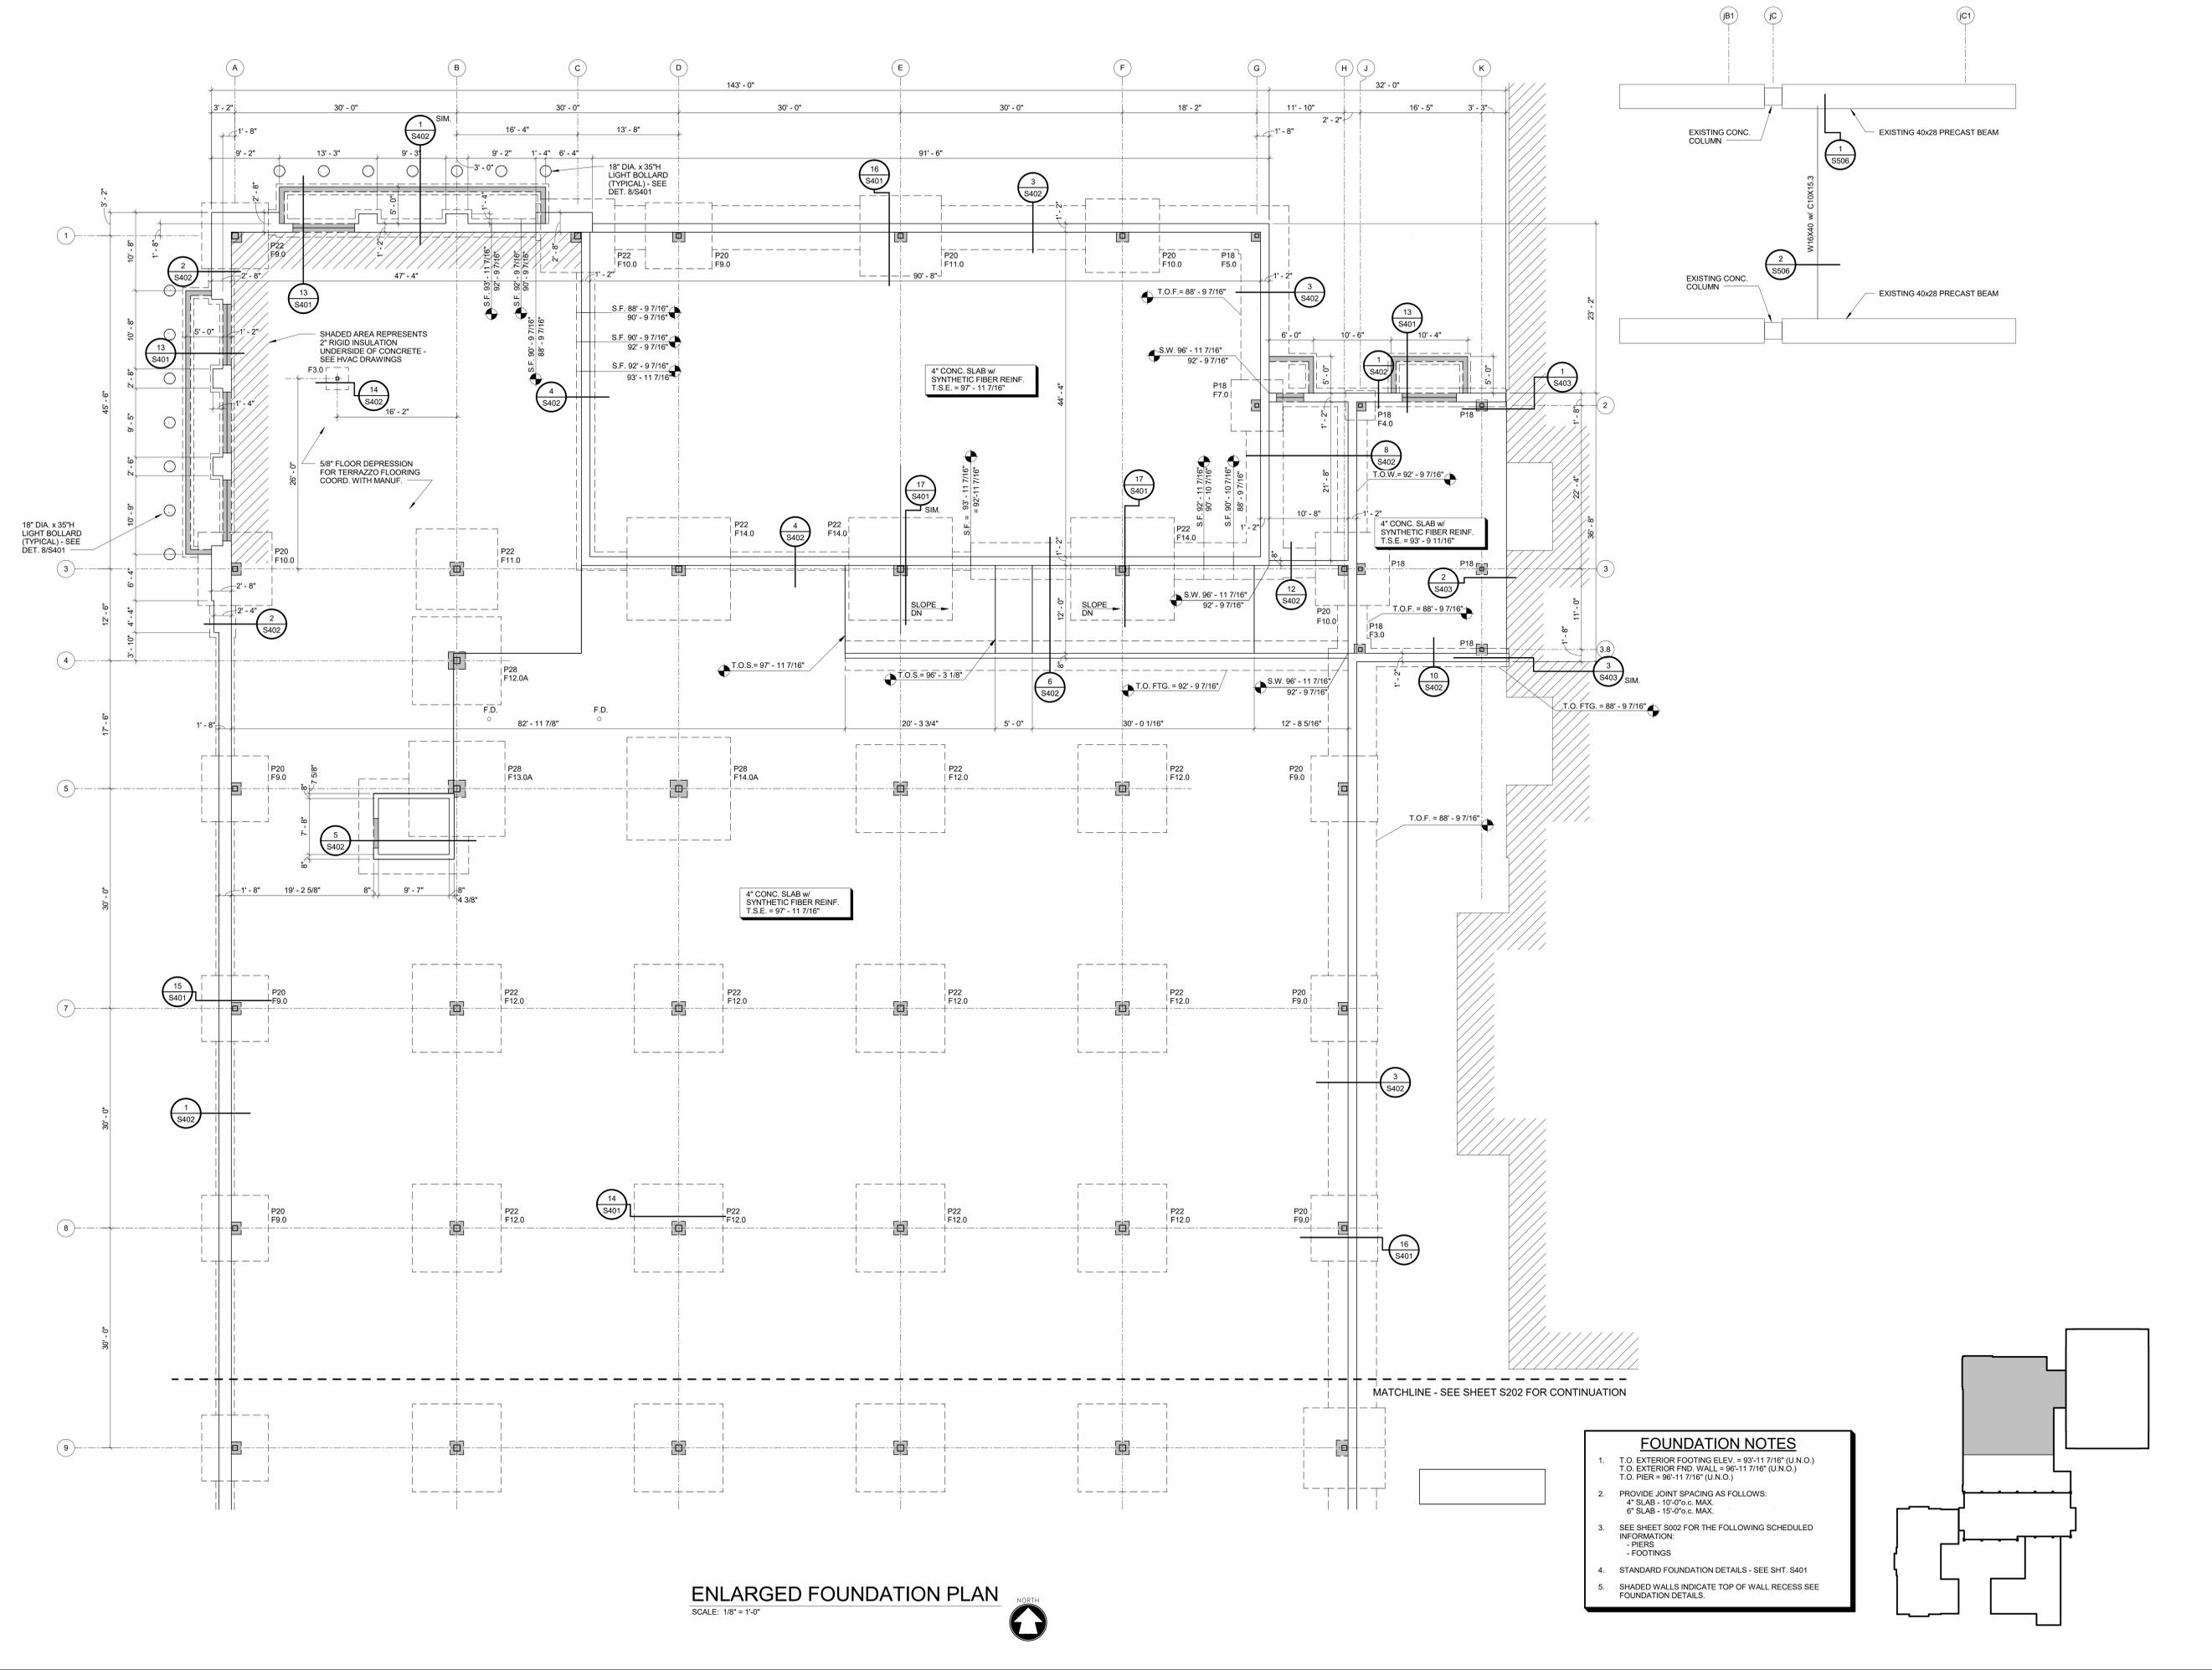

FOUNDATION NOTES

- T.O. EXTERIOR FOOTING ELEV. = 93'-11 7/16" (U.N.O.)
T.O. EXTERIOR FND. WALL = 96'-11 7/16" (U.N.O.)
T.O. PIER = 96'-11 7/16" (U.N.O.)
- PROVIDE JOINT SPACING AS FOLLOWS:
4" SLAB - 10'-0" c. MAX.
6" SLAB - 15'-0" c. MAX.
- SEE SHEET S202 FOR THE FOLLOWING SCHEDULED INFORMATION:
- PIERS
- FOOTINGS
- STANDARD FOUNDATION DETAILS - SEE SHT. S401
- SHADED WALLS INDICATE TOP OF WALL RECESS SEE FOUNDATION DETAILS.

ENLARGED FOUNDATION PLAN
SCALE: 1/8" = 1'-0"


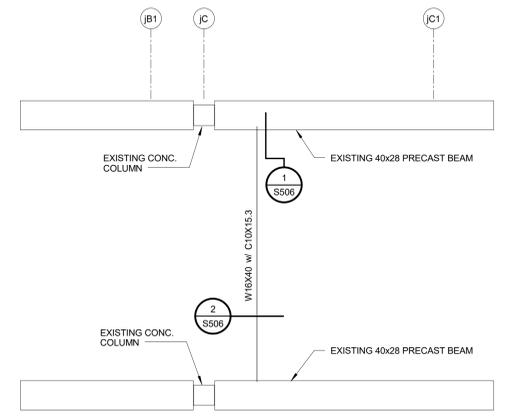


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NO.	DATE	REVISION

ALTERATION / ADDITION
OUTAGAMIE COUNTY ADMINISTRATION CENTER
S. WALNUT & W. 8TH, APPLETON WI 54911
ENLARGED FOUNDATION PLAN


DESIGNED PEB	DRAWN MLR
PROJECT NO. 0002-61600160	
DATE MARCH 3, 2017	
SHEET NO. S203	

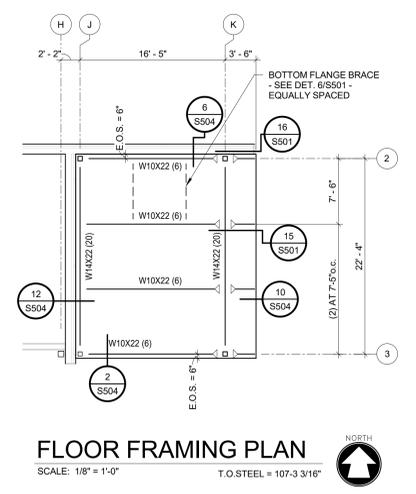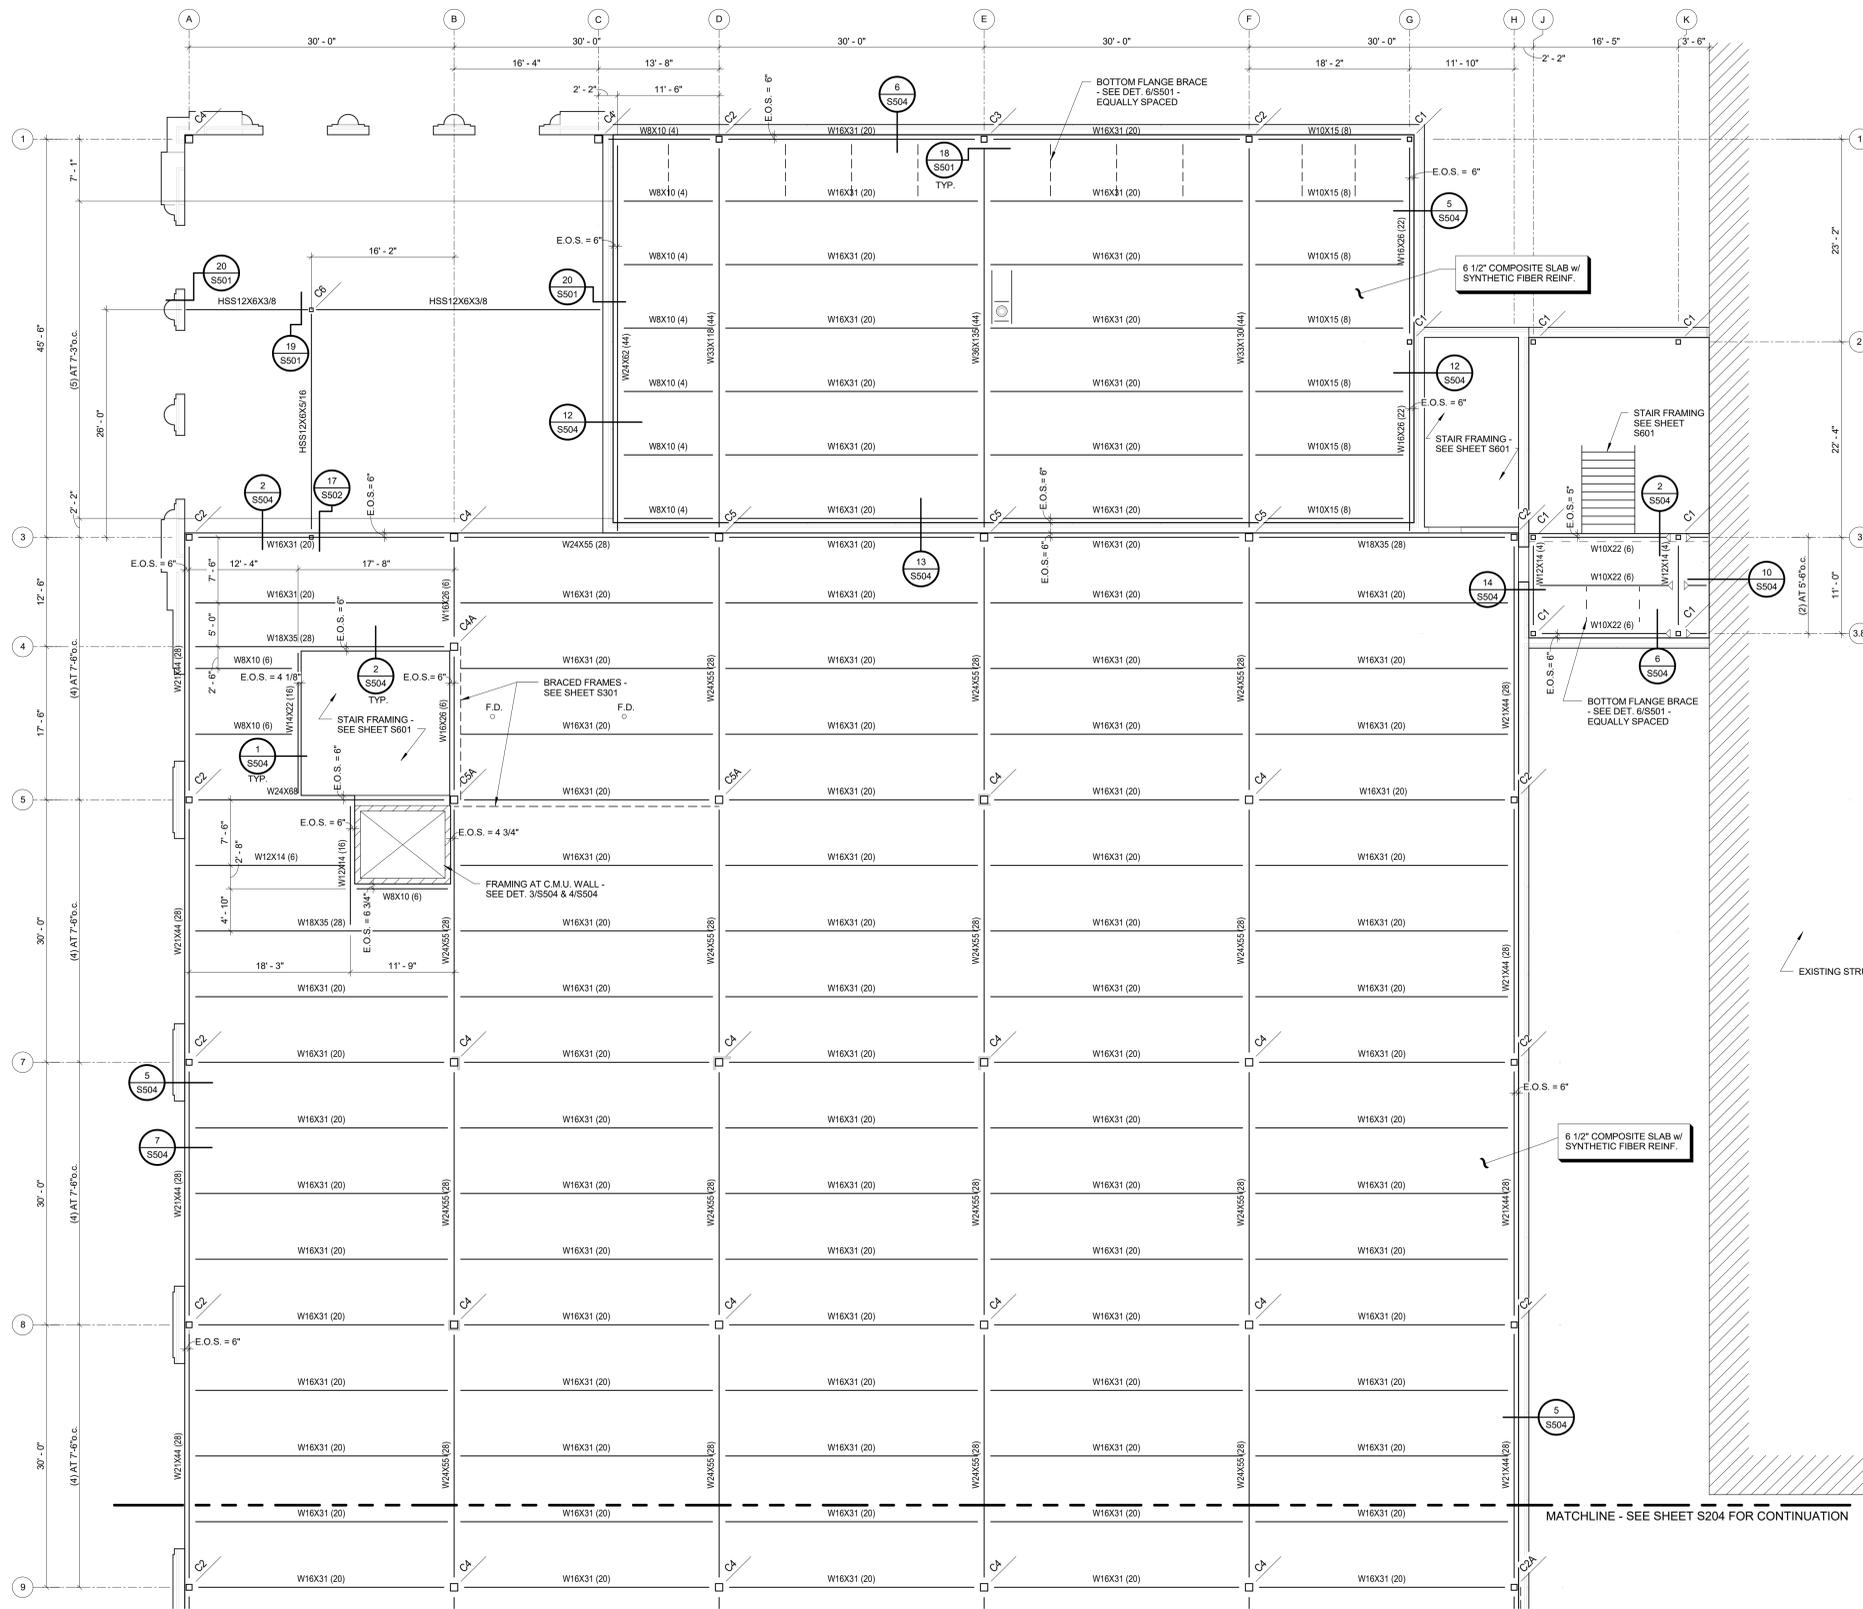

FLOOR FRAMING PLAN
SCALE: 1/8" = 1'-0"
T.O. STEEL = 107'-3 3/16"

SECOND FLOOR & LOW ROOF FRAMING PLAN
SCALE: 1/8" = 1'-0"
T.O. STEEL = 112'-8 11/16"

- FRAMING NOTES**
- () INDICATES T.O. STEEL OR JOIST BEARING ELEVATION.
 - SEE SHEET S202 FOR THE FOLLOWING SCHEDULED INFORMATION:
- COLUMNS & BASEPLATES
 - STANDARD FRAMING DETAILS - SEE SHT. S501 & S502
 - SEE STANDARD DETAILS SHEET S503 FOR MASONRY AND STEEL LINTELS. LINTELS IN NON-BRG. PARTITION WALLS SHALL BE MASONRY - SEE SCHEDULE.
 - MASONRY WALL REINF. - #5 AT 32" o.c.
 - VERIFY OPENINGS IN FLOOR w/MECHANICAL & ELECTRICAL DRAWINGS. PROVIDE SUPPORT FRAMING AS REQUIRED AND SHOWN IN DETAIL S5502 & S5502.
 - - INDICATES MOMENT CONNECTION

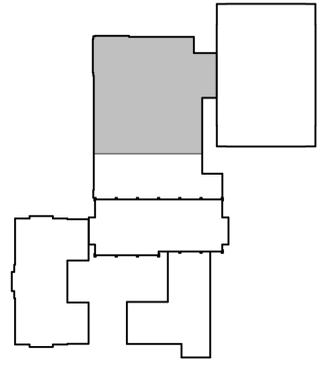


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MILWAUKEE, WI 53233
TEL: (414) 224-1200 FAX: (414) 224-1201
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DESIGNED: PEB
DRAWN: MLR
PROJECT NO.: 00002-61600160
DATE: MARCH 3, 2017
SHEET NO.: S205

ALTERATION / ADDITION
OUTAGAMIE COUNTY ADMINISTRATION CENTER
S. WALNUT & W. 8TH, APPLETON WI 54911
ENLARGED 2ND FLOOR AND LOW ROOF FRAMING PLAN


NO.	DATE	REVISION

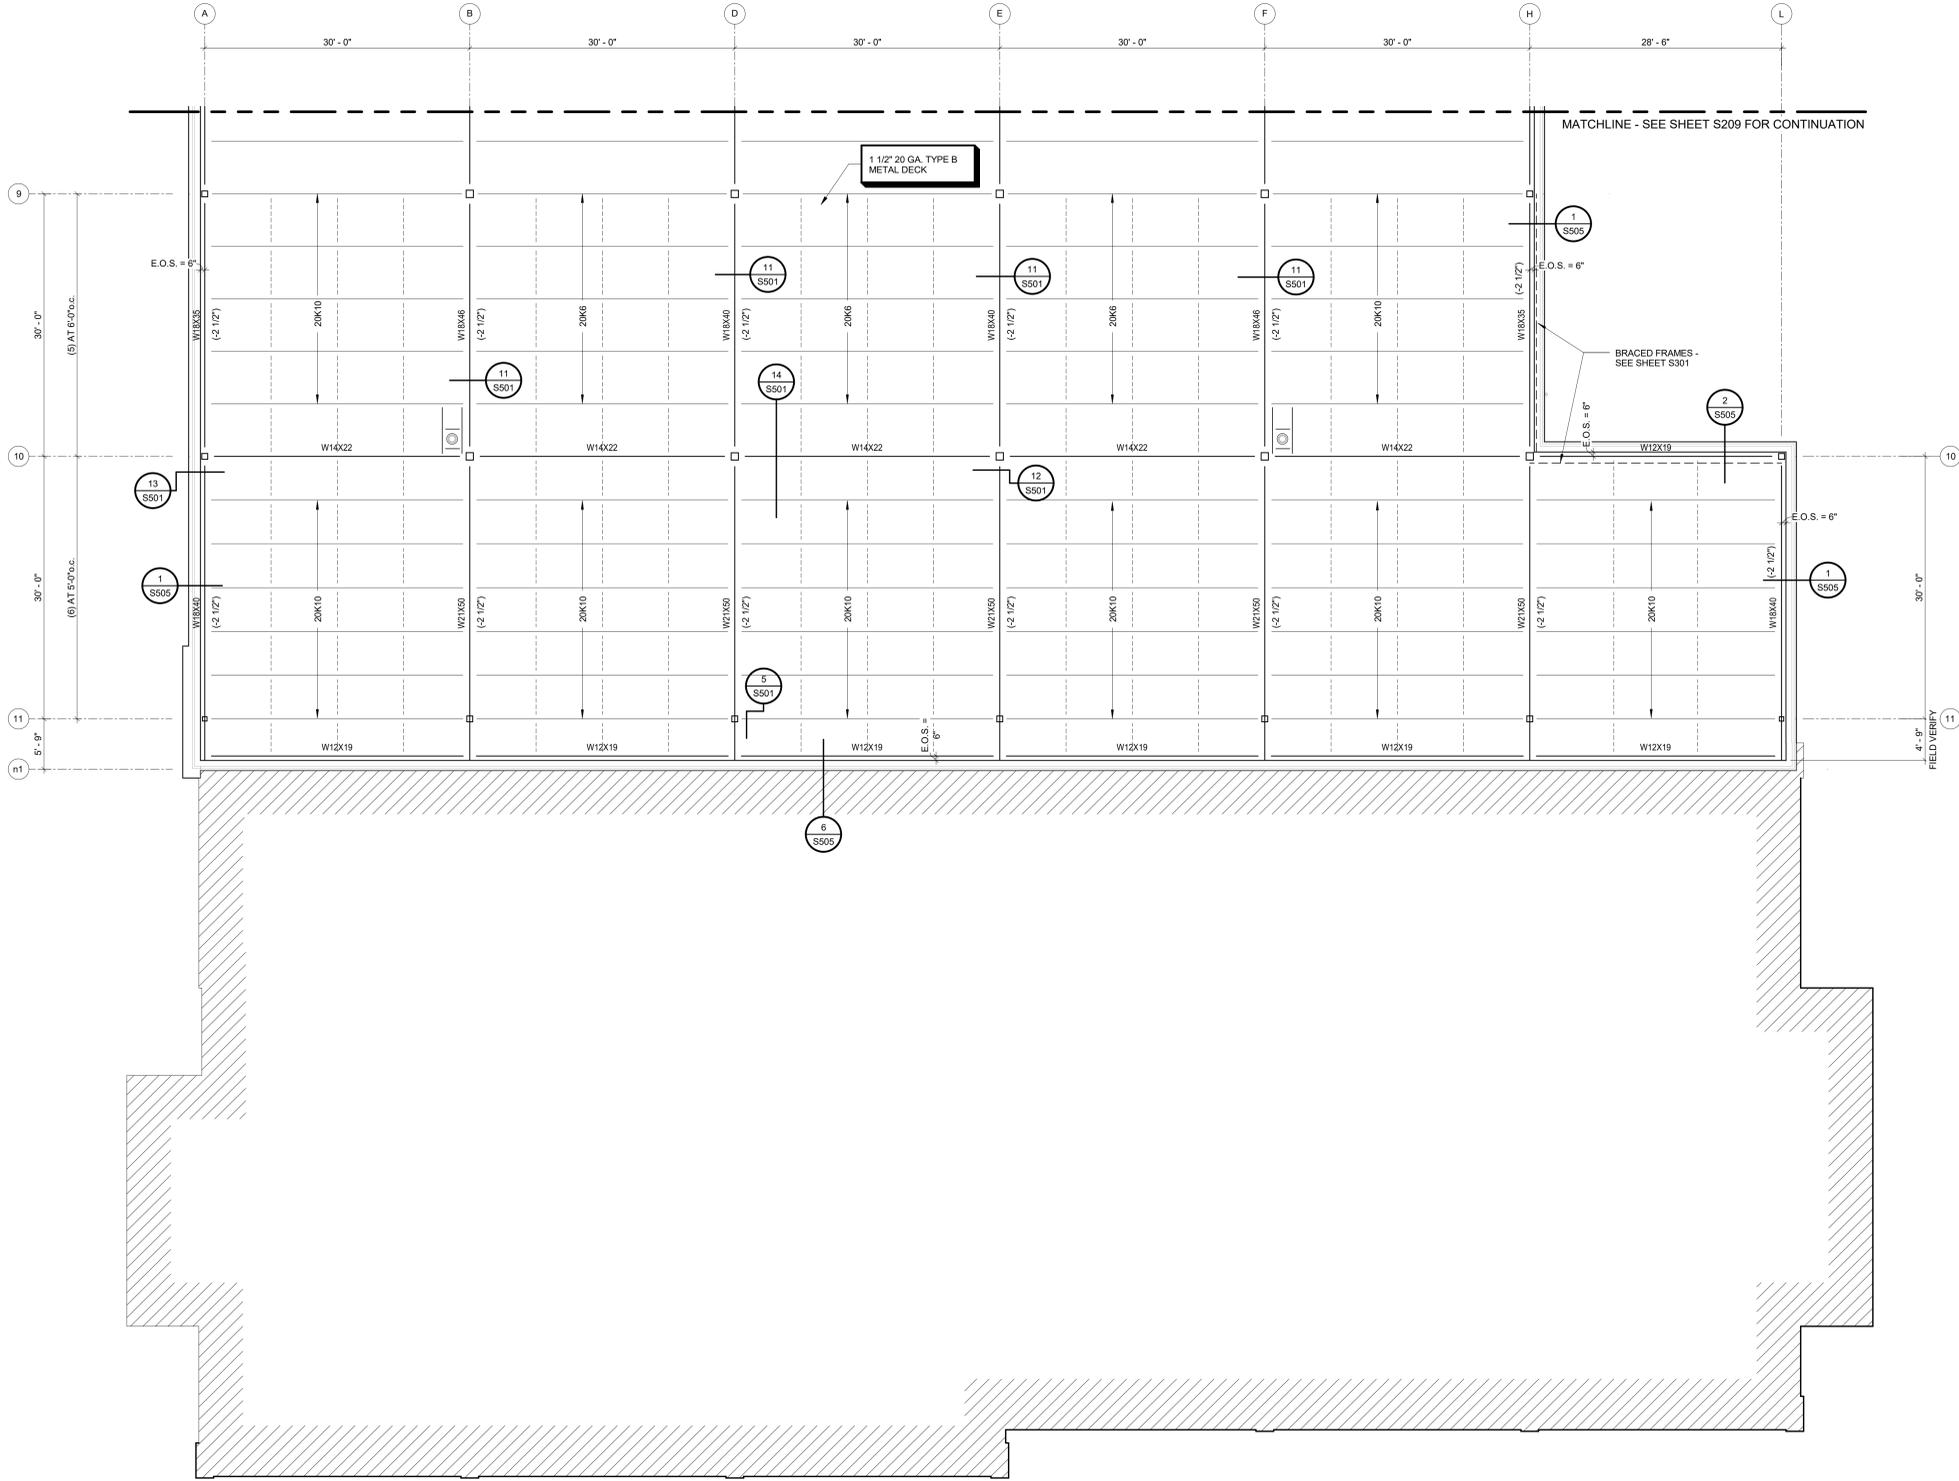

ROOF FRAMING PLAN
 SCALE: 1/8" = 1'-0" DECK BEARING - 143'-3 15/16"



- ROOF FRAMING NOTES**
- INDICATES HORIZONTAL BRIDGING.
 - () INDICATES T.O. STEEL OR JOIST BEARING ELEVATION.
 - SEE SHEET S502 FOR THE FOLLOWING SCHEDULED INFORMATION - COLUMNS & BASEPLATES
 - STANDARD FRAMING DETAILS - SEE SHT. S501 & S502
 - AT ROOF SLUMP LOCATIONS, PROVIDE STEEL FRAME. SEE SHEET S502 FOR STANDARD DETAILS.
 - VERIFY OPENINGS IN ROOF w/ MECHANICAL & ELECTRICAL DRAWINGS. PROVIDE SUPPORT FRAMING AS REQUIRED SEE SHEET S502 FOR STANDARD DETAILS.
 - SEE STANDARD DETAILS SHEET S503 FOR MASONRY AND STEEL LINTELS. LINTELS IN NON-BRG. PARTITION WALLS SHALL BE MASONRY - SEE SCHEDULE.
 - MASONRY WALL REINF. - #5 AT 32" o.c.

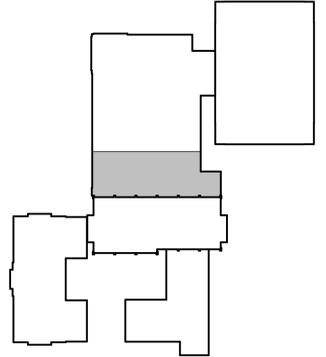


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NO.	DATE	REVISION


ALTERATION / ADDITION
OUTAGAMIE COUNTY ADMINISTRATION CENTER
S. WALNUT & W. 8TH, APPLETON WI 54911
ENLARGED ROOF FRAMING PLAN

DESIGNED	DRAWN
PEB	MLR
PROJECT NO. 0002-61600160	
DATE MARCH 3, 2017	
SHEET NO. S208	

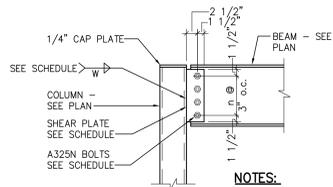


- NOTES:**
1. ALL BOLTS SHALL BE A325N IN BEARING TYPE CONNECTION.
 2. USE STANDARD ROUND HOLES.

CONNECTION SCHEDULE			
BEAM SIZE	BOLTS	PLATE THICKNESS	WELD
WB & W10	(2) 7/8" DIA.	5/16"	1/4"
W12	(3) 7/8" DIA.	5/16"	1/4"
W14 & W16	(4) 7/8" DIA.	5/16"	1/4"
W18	(5) 7/8" DIA.	3/8"	5/16"
W21	(6) 7/8" DIA.	3/8"	5/16"
W24	(7) 7/8" DIA.	3/8"	5/16"
W27	(8) 7/8" DIA.	3/8"	5/16"
W30	(9) 7/8" DIA.	3/8"	5/16"
W33	(10) 7/8" DIA.	3/8"	5/16"

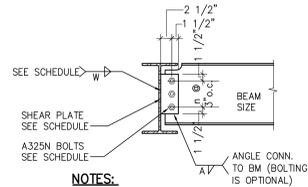


- NOTES:**
1. ALL BOLTS SHALL BE A325 N IN BEARING TYPE CONNECTION.
 2. USE STANDARD ROUND HOLES COPE UPPER & LOWER FLANGE AS REQUIRED.


CONNECTION SCHEDULE			
BEAM SIZE	BOLTS	PLATE THICKNESS	WELD
WB & W10	(2) 7/8" DIA.	5/16"	1/4"
W12	(3) 7/8" DIA.	5/16"	1/4"
W14 & W16	(4) 7/8" DIA.	5/16"	1/4"
W18	(5) 7/8" DIA.	3/8"	5/16"
W21	(6) 7/8" DIA.	3/8"	5/16"
W24	(7) 7/8" DIA.	3/8"	5/16"
W27	(8) 7/8" DIA.	3/8"	5/16"
W30	(9) 7/8" DIA.	3/8"	5/16"
W33	(10) 7/8" DIA.	3/8"	5/16"

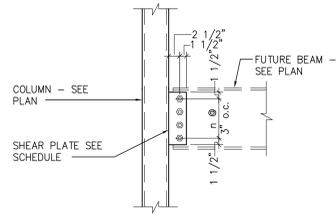

NOTE: PROVIDE SHEAR TAB FOR FUTURE BEAM. VERIFY TAB WILL NOT CONFLICT W/ PRECAST WALL.

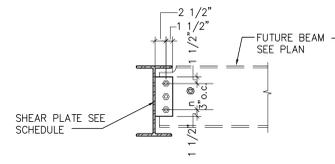


NOTE: PROVIDE SHEAR TAB FOR FUTURE BEAM.

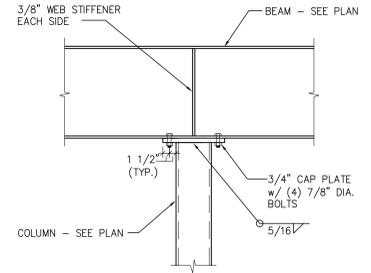

BEAM TO COLUMN CONNECTION SCHEDULE

SCALE: 3/4" = 1'-0"

1 S501

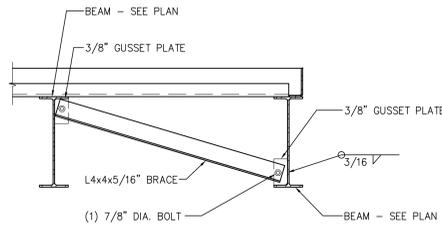

BEAM BOTTOM FLANGE BRACE


SCALE: 3/4" = 1'-0"

6 S501

BEAM CONNECTION DETAIL

SCALE: 3/4" = 1'-0"

2 S501

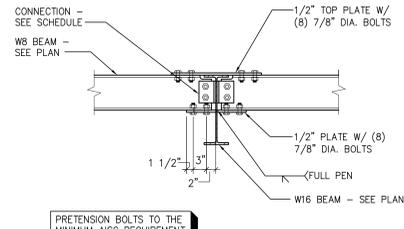

PRETENSION BOLTS TO THE MINIMUM AISC REQUIREMENT.

MOMENT CONNECTION


SCALE: 3/4" = 1'-0"

7 S501

FUTURE BEAM TO COLUMN CONNECTION

SCALE: 3/4" = 1'-0"

3 S501

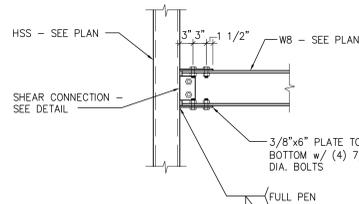

TUBE MOMENT CONNECTION


SCALE: 3/4" = 1'-0"

8 S501

FUTURE BEAM TO BEAM CONNECTION

SCALE: 3/4" = 1'-0"

4 S501

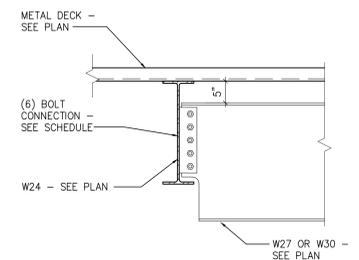

BEAM TO BEAM CONNECTION


SCALE: 3/4" = 1'-0"

9 S501

BEAM BEARING AT COLUMN

SCALE: 3/4" = 1'-0"


5 S501

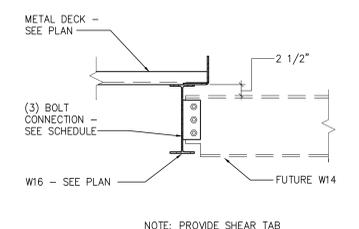

FUTURE BEAM TO BEAM CONNECTION

SCALE: 3/4" = 1'-0"

10 S501

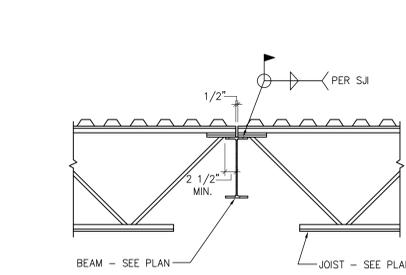


NOTE: STAGGER JOISTS IF END BEARING IS GREATER THAN BEAM FLANGE PROVIDES.

JOIST BEARING ON STEEL BEAM

SCALE: 3/4" = 1'-0"

11 S501

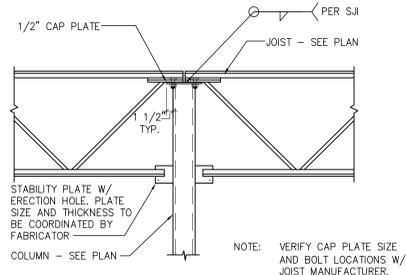


NOTE: VERIFY CAP PLATE SIZE AND BOLT LOCATIONS W/ JOIST MANUFACTURER.

STEEL JOIST BEARING AT COLUMN

SCALE: 3/4" = 1'-0"

12 S501

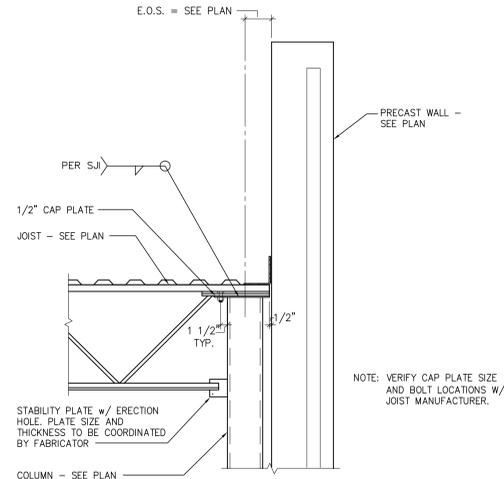


NOTE: VERIFY CAP PLATE SIZE AND BOLT LOCATIONS W/ JOIST MANUFACTURER.

STEEL JOIST BEARING AT COLUMN

SCALE: 3/4" = 1'-0"


13 S501

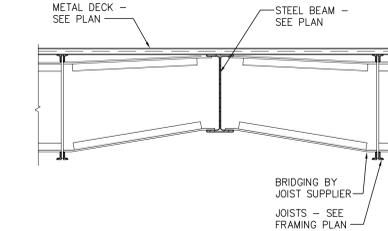

DECK BEARING AT STEEL BEAM

SCALE: 3/4" = 1'-0"

14 S501

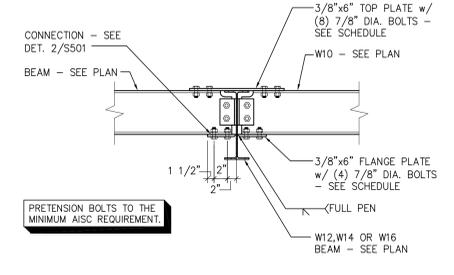


PRETENSION BOLTS TO THE MINIMUM AISC REQUIREMENT.

MOMENT CONNECTION

SCALE: 3/4" = 1'-0"


15 S501

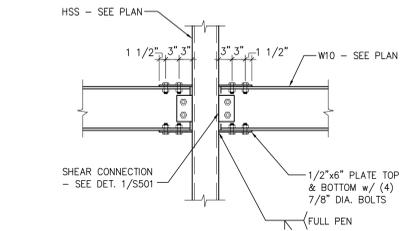

TUBE MOMENT CONNECTION

SCALE: 3/4" = 1'-0"


16 S501

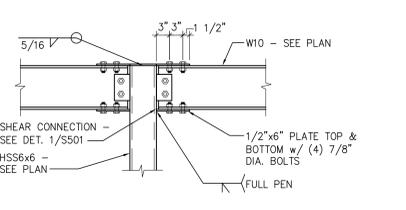

TUBE MOMENT CONNECTION

SCALE: 3/4" = 1'-0"


17 S501

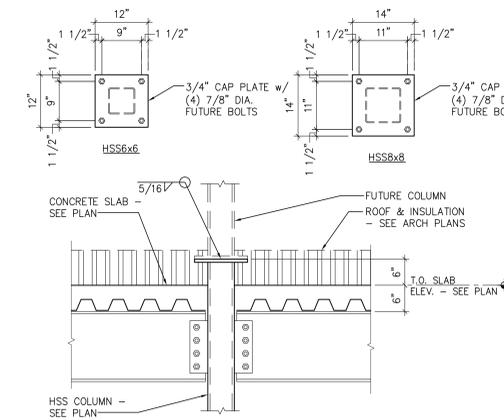

COLUMN SPLICE

SCALE: 3/4" = 1'-0"


18 S501

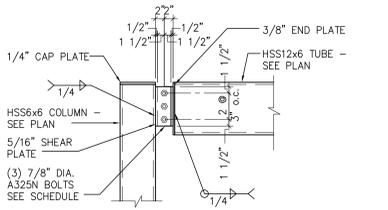

TUBE TO COLUMN CONNECTION

SCALE: 3/4" = 1'-0"

19 S501

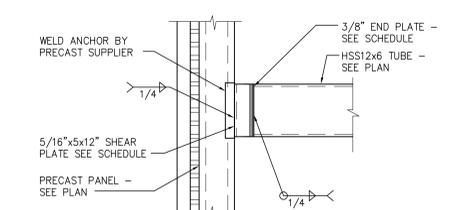

TUBE TO PRECAST WALL

SCALE: 3/4" = 1'-0"

20 S501


mcmahon, w:\PROJECTS\00002\61600160\Drawings\Autocad\S501 - STANDARD FRAMING DETAILS.dwg, Plot Date: 3/1/2017 9:56 AM, xref:framing

McMAHON
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ALTERATION/ADDITION OUTAGAME COUNTY ADMINISTRATION CENTER
S. WALNUT & W. 8TH, APPLETON, WI 54911
STANDARD FRAMING DETAILS

DESIGNED	MLR
DRAWN	MLR
PROJECT NO.	00002-61600160
DATE	MARCH 3, 2017
SHEET NO.	S501




NOTES:

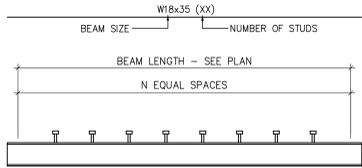1. HEADED STUDS SHALL BE 3/4" DIA. A108 x 5" (U.N.O.).
2. MIN. LONGITUDINAL SPACING = 4 1/2" MIN. TRANSVERSE SPACING = 3" MAX. LONGITUDINAL SPACING = 18" (MAX. SPACING MAY BE INCREASED TO 36" IF METAL DECK IS SECURED TO SUPPORTS w/ PUDDLE WELDS @ 18" o.c.)
3. STUDS SHALL BE SPACED UNIFORMLY & EQUALLY EACH SIDE OF BEAM CENTERLINE (U.N.O.).
4. HEADED STUDS SHALL BE FIELD WELDED TO TOP OF BEAM THRU BOTTOM OF STEEL DECK FLUTE.

COMPOSITE BEAM

SCALE: NONE

1 S502

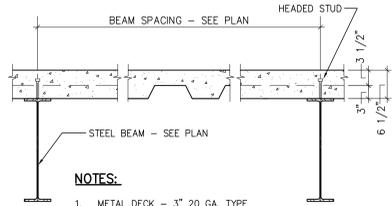


NOTES:

1. METAL DECK - 3" 20 GA. TYPE VL COMPOSITE DECK.
2. DECK SHALL BE SHORED FOR SINGLE SPANS GREATER THAN 4'-10" OR CONTINUOUS SPANS GREATER THAN 6'-8".

CONCRETE SLAB AT STEEL BEAMS

SCALE: 3/4" = 1'-0"


2 S502

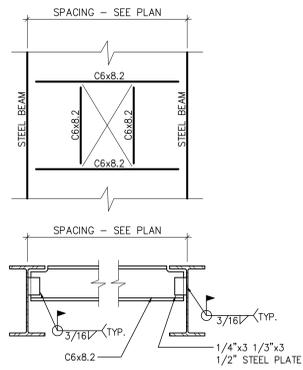

LARGE FLOOR OPENING

SCALE: 3/4" = 1'-0"


3 S502

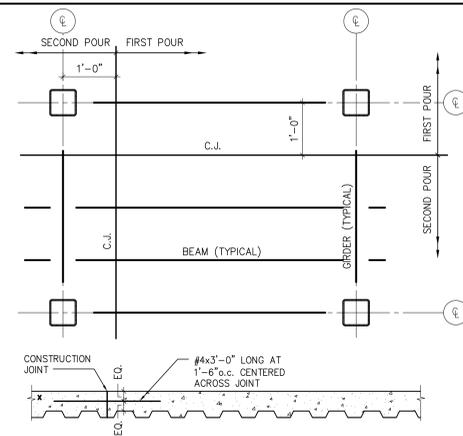

SLAB CONSTRUCTION JOINT

SCALE: 3/4" = 1'-0"

4 S502

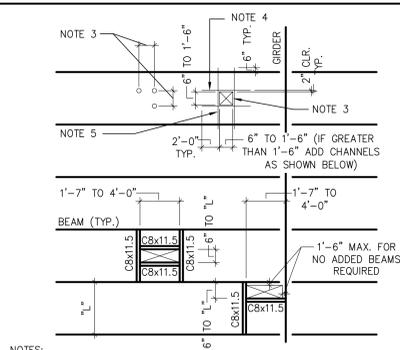


NOTES:

1. OPENINGS SHALL BE BLOCKED OUT BEFORE PLACING CONCRETE, AFTER CONCRETE HAS CURED REMOVE BLOCKOUT AND CUT DECK AT UNFRAMED OPENINGS.
2. CONTRACTOR SHALL COORDINATE OPENING SIZE AND LOCATION WITH MECHANICAL AND ELECTRICAL CONTRACTORS AND ARCHITECTURAL DRAWINGS.
3. SPACING OF ADJACENT HOLES SHALL NOT BE LESS THAN 3x LARGEST HOLE SIZE, HOLES LESS THAN 6" DO NOT REQUIRE REINFORCING.
4. PROVIDE (1) ADDITIONAL #4 AT ALL SIDES BOTTOM LOCATE 1" CLEAR FROM BOTTOM OF DECK.
5. BARS PARALLEL TO DECK SHALL BE LOCATED IN BOTTOM OF DECK FLUTE (MINIMUM 1" CLEAR) ADJACENT TO OPENING

SLAB OPENINGS

SCALE: 1/8" = 1'-0"

5 S502

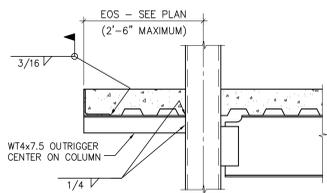


NOTES:

1. DETAIL DOES NOT APPLY WHERE PRECAST CONCRETE, C.M.U. OR OTHER GRAVITY LOAD IS SUPPORTED AT SLAB EDGE.
2. WHERE EDGE OF SLAB IS SHOWN TO BE CURVED, SDI POUR STOPS AND BENT PLATE SHALL BE ROLLED TO MATCH INDICATED CURVE.

DECK SUPPORT AT EXTERIOR COLUMNS

SCALE: 3/4" = 1'-0"

6 S502

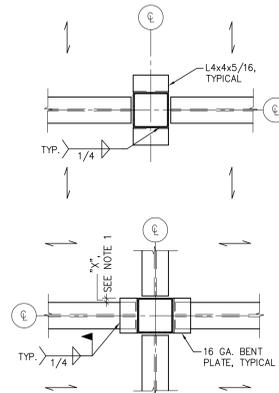


NOTE:

1. DECK SUPPORT PLATE IS NOT REQUIRED IF "X" IS LESS THAN 4"

DECK SUPPORT AT INTERIOR COLUMNS

SCALE: 3/4" = 1'-0"


7 S502

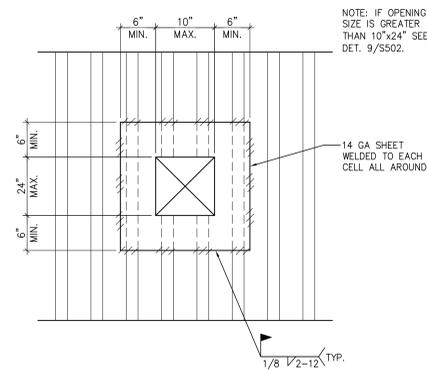

SMALL DECK OPENING

SCALE: 3/4" = 1'-0"

8 S502

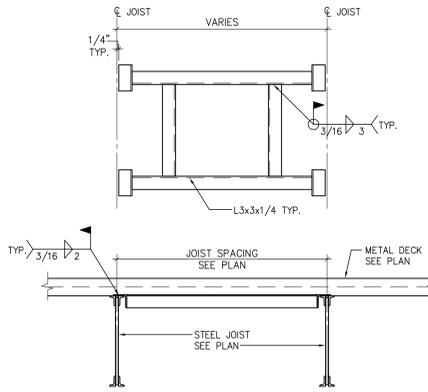

ROOF OPENING FRAMING


SCALE: 3/4" = 1'-0"

9 S502

ROOF DRAIN SUPPORT FRAME

SCALE: 3/4" = 1'-0"

10 S502

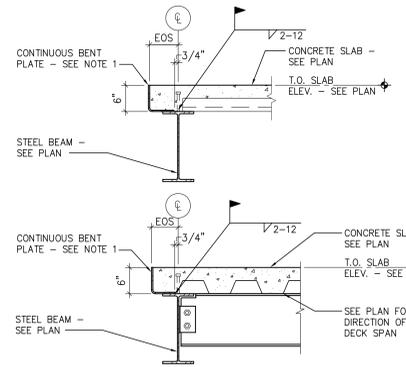


NOTE:

1. BENT PLATE THICKNESS EOS - 6" OR LESS = 5/16" EOS - 6"-2'-0" = 3/8"
2. AS AN ALTERNATE TO BENT PLATE FABRICATOR CAN PROVIDE EQUIVALENT ANGLE.

PERIMETER BENT FLOOR PLATE

SCALE: 3/4" = 1'-0"

15 S502

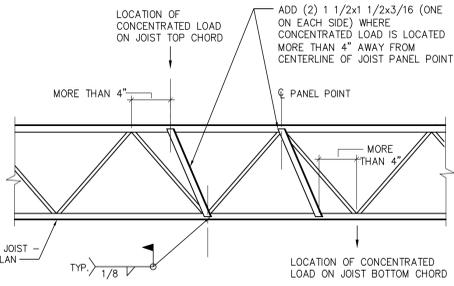


1. STEEL JOIST MANUFACTURER TO SUPPLY SPECIALLY DESIGNED JOIST FOR ADDITIONAL LOADS.

LOADS OFFSET FROM PANEL POINTS

SCALE: 3/4" = 1'-0"


11 S502

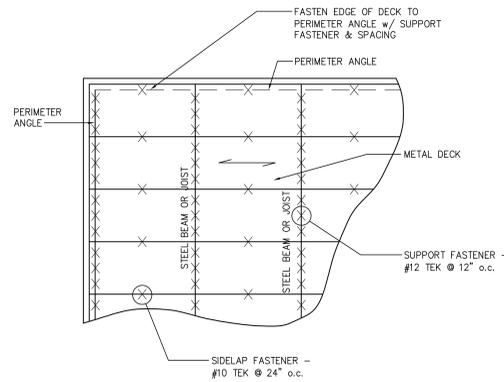

DECK CONNECTION DIAGRAM

NO SCALE

12 S502

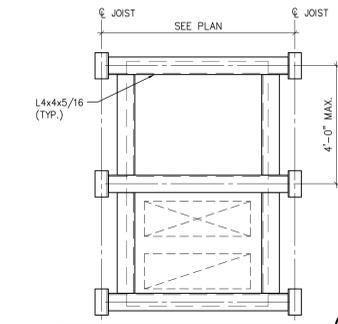


1. PROVIDE CONT. ANGLE BELOW MECHANICAL UNIT CURB.
2. MECHANICAL UNIT DIMENSIONS & LOCATIONS SHALL BE DETERMINED BY THE MECHANICAL CONTRACTOR AND COORDINATED WITH THE STEEL FABRICATOR, THE ENGINEER / ARCHITECT WILL NOT PROVIDE OR VERIFY THIS INFORMATION.

SMALL MECHANICAL UNIT SUPPORT

SCALE: 3/4" = 1'-0"

13 S502

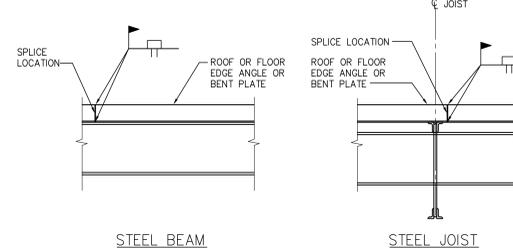


1. WELD ALL ROOF OR FLOOR EDGE ANGLE OR BENT PLATE SEGMENTS TOGETHER WITH BUTT WELD, BOTH LEGS.

ROOF PERIMETER EDGE ANGLE OR BENT PLATE SPLICE

SCALE: 3/4" = 1'-0"

14 S502

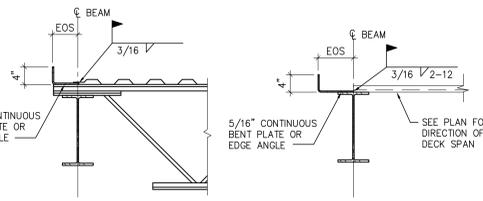


- NOTE: AS AN ALTERNATE TO BENT PLATE FABRICATOR CAN PROVIDE EQUIVALENT ANGLE.

PERIMETER BENT ROOF PLATE

SCALE: 3/4" = 1'-0"

16 S502

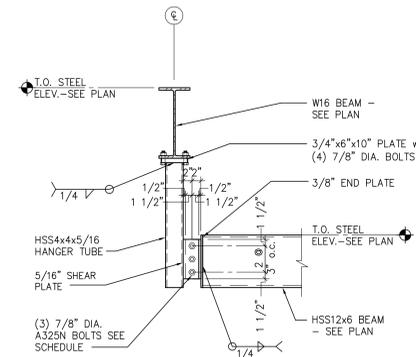

TUBE HANGER CONNECTION


SCALE: 3/4" = 1'-0"

17 S502

McMAHON ENGINEERS ARCHITECTS
 1100 P.O. BOX 1025 NEENAH, WI 54957-1025
 Tel: (920) 751-4200 Fax: (920) 751-4284
 www.mcmahongrp.com

DESIGNED: PEB DRAWN: MLR
 PROJECT NO: 00002-61600160
 DATE: MARCH 3, 2017
 SHEET NO: S502


ALTERATION/ADDITION OUTAGAME COUNTY ADMINISTRATION CENTER
 S. WALNUT & W. 8TH, APPLETON, WI 54911
 FRAMING DETAILS

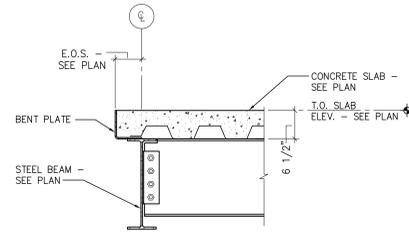

PERIMETER STEEL BEAM

SCALE: 3/4" = 1'-0"


1
S504

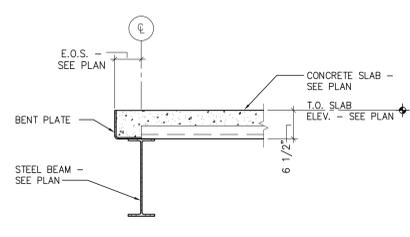

PERIMETER STEEL BEAM

SCALE: 3/4" = 1'-0"


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S504

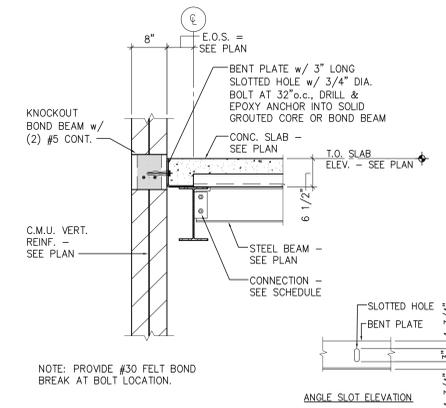

PERIMETER BEAM AT C.M.U. WALL

SCALE: 3/4" = 1'-0"


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S504

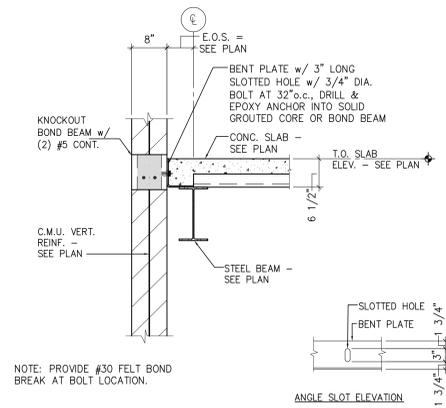

PERIMETER BEAM AT C.M.U. WALL

SCALE: 3/4" = 1'-0"


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PERIMETER STEEL BEAM

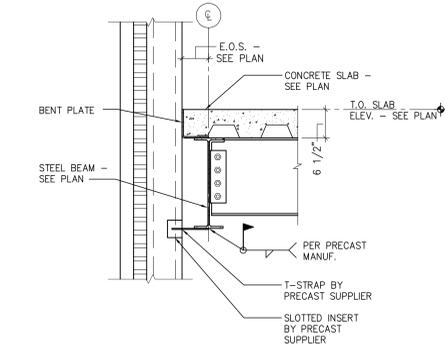SCALE: 3/4" = 1'-0"


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S504



PERIMETER STEEL BEAM

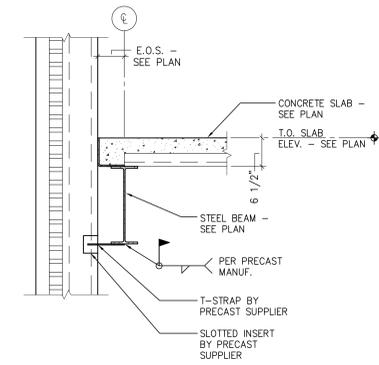SCALE: 3/4" = 1'-0"


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PERIMETER STEEL BEAM

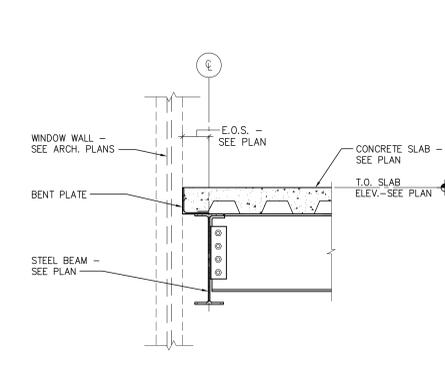SCALE: 3/4" = 1'-0"


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S504



PERIMETER STEEL BEAM

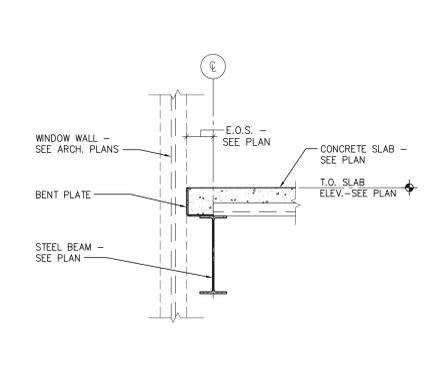SCALE: 3/4" = 1'-0"


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S504

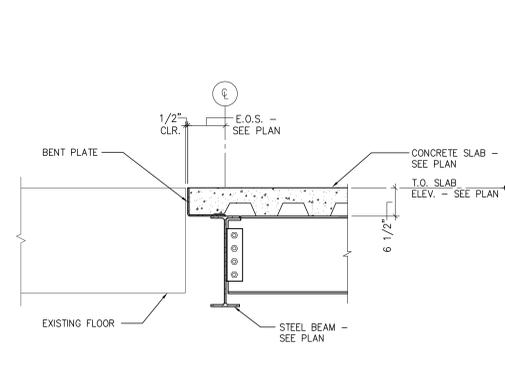

PERIMETER STEEL BEAM

SCALE: 3/4" = 1'-0"


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S504

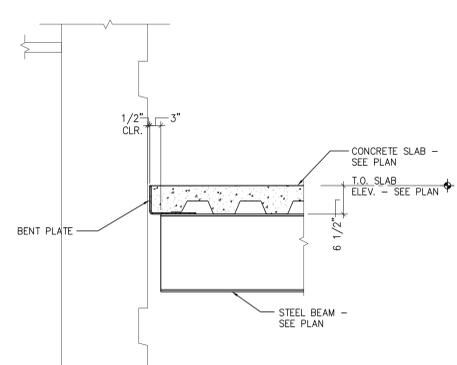

PERIMETER STEEL BEAM

SCALE: 3/4" = 1'-0"


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S504

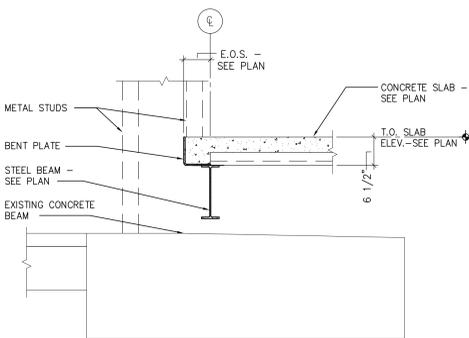

PERIMETER STEEL BEAM

SCALE: 3/4" = 1'-0"


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S504

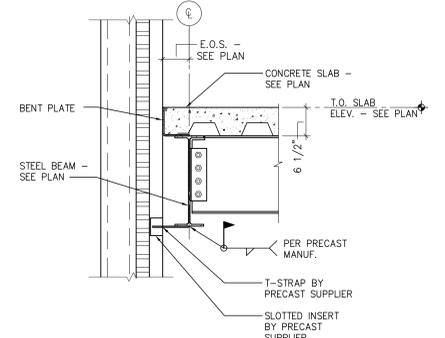

PERIMETER STEEL BEAM

SCALE: 3/4" = 1'-0"


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S504

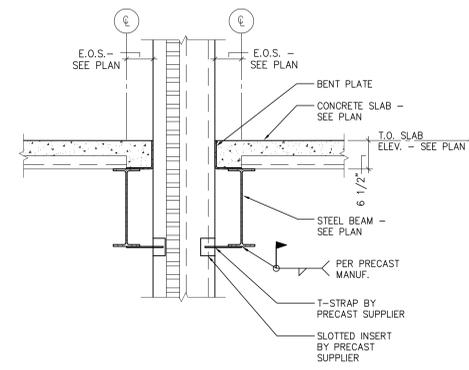

PERIMETER STEEL BEAM

SCALE: 3/4" = 1'-0"


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S504

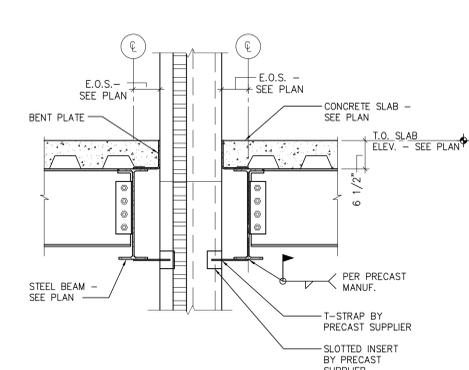

PERIMETER STEEL BEAM

SCALE: 3/4" = 1'-0"


14
S504

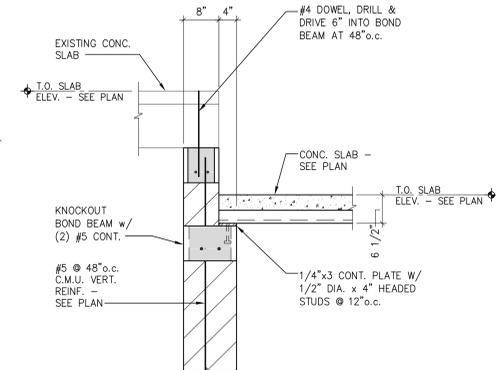

SLAB BEARING AT C.M.U. WALL

SCALE: 3/4" = 1'-0"


15
S504

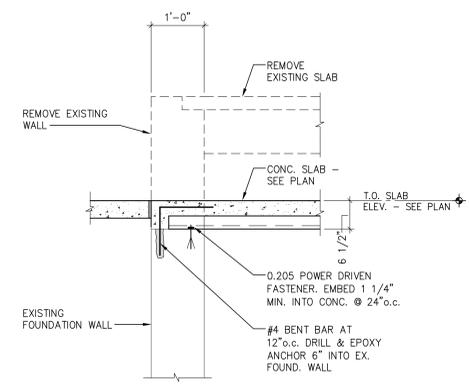

NEW SLAB AT EXISTING WALL

SCALE: 3/4" = 1'-0"


16
S504

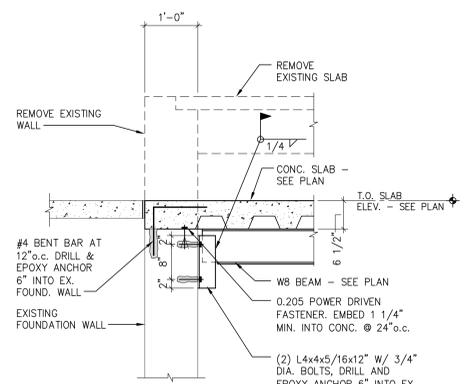

NEW SLAB AT EXISTING BUILDING

SCALE: 3/4" = 1'-0"


17
S504

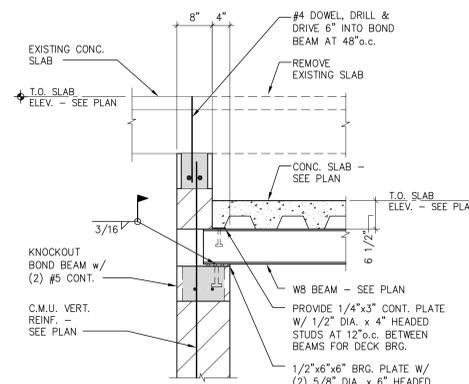

BEAM BEARING AT C.M.U. WALL

SCALE: 3/4" = 1'-0"

18
S504

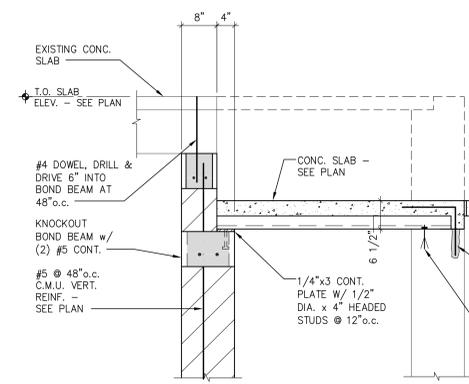

NEW SLAB AT EXISTING WALL

SCALE: 3/4" = 1'-0"


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S504

McMAHON
ENGINEERS ARCHITECTS


1500 W. WALNUT ST., SUITE 200, MILWAUKEE, WI 53233
TEL: (414) 224-1200 FAX: (414) 224-1201
WWW.MCMAGROUP.COM

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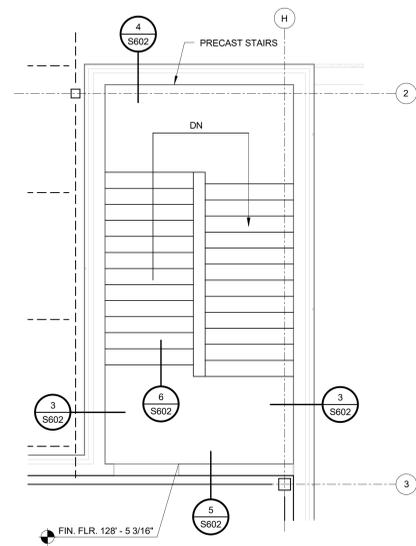
DESIGNED	PEB	MLR
DRAWN		
PROJECT NO.	00002-61600160	
DATE	MARCH 3, 2017	
SHEET NO.	S504	

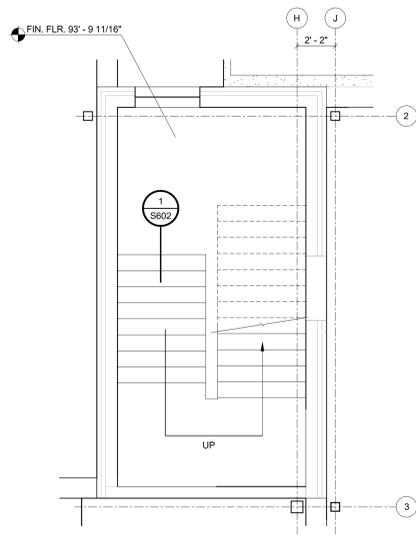


STAIR FRAMING PLAN
SCALE: 1/4" = 1'-0"

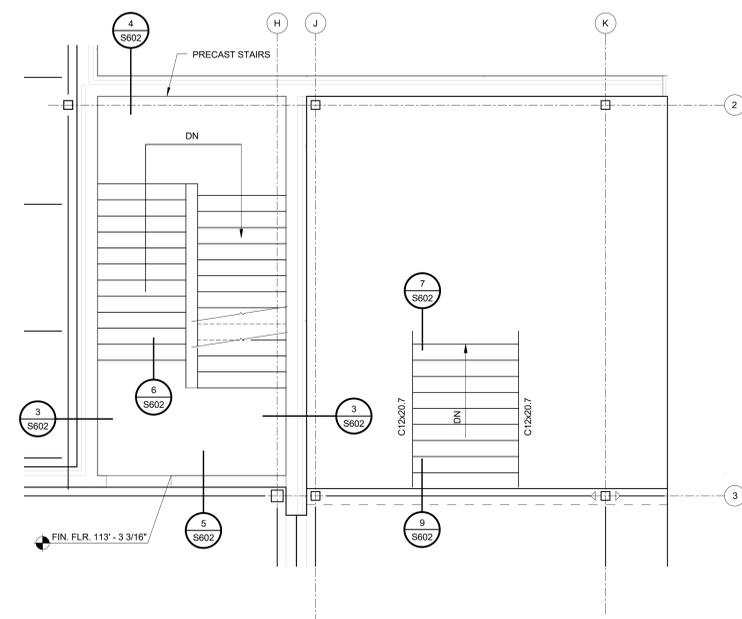


STAIR FRAMING PLAN
SCALE: 1/4" = 1'-0"




STAIR FRAMING PLAN
SCALE: 1/4" = 1'-0"

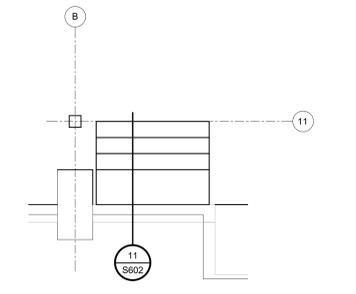


STAIR FRAMING PLAN
SCALE: 1/4" = 1'-0"

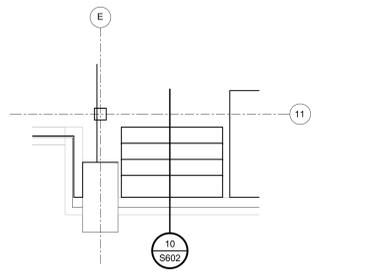


STAIR FRAMING PLAN
SCALE: 1/4" = 1'-0"

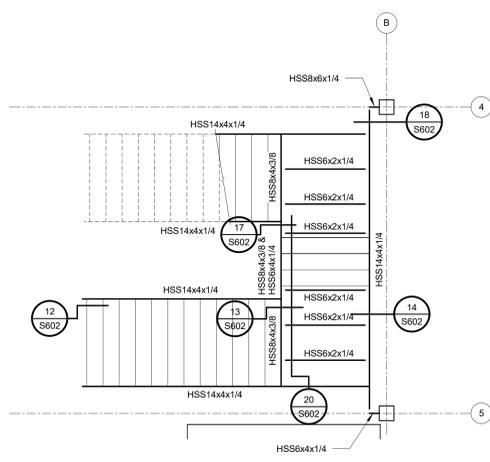

STAIR FRAMING PLAN GROUND FLR.
SCALE: 1/4" = 1'-0"

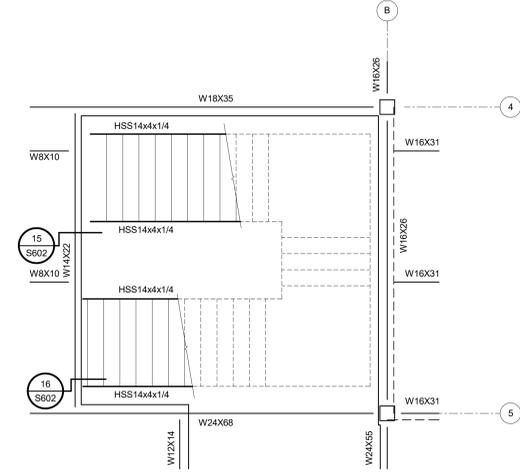

STAIR FRAMING PLAN 2ND FLR.
SCALE: 1/4" = 1'-0"

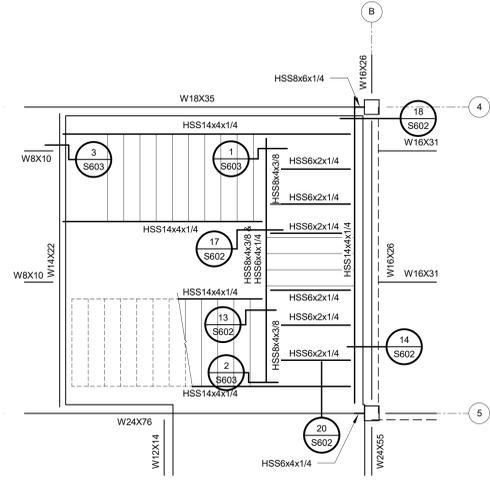


STAIR FRAMING PLAN 3RD FLR.
SCALE: 1/4" = 1'-0"

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NO.	DATE	REVISION

ALTERATION / ADDITION
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STAIR FRAMING PLAN


DESIGNED PEB	DRAWN MLR
PROJECT NO. 0002-61600160	
DATE MARCH 3, 2017	
SHEET NO.	

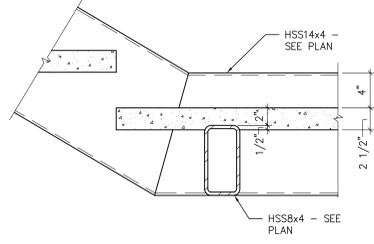

STRINGER TO TUBE CONNECTION

SCALE: 1 1/2" = 1'-0"

1
S603

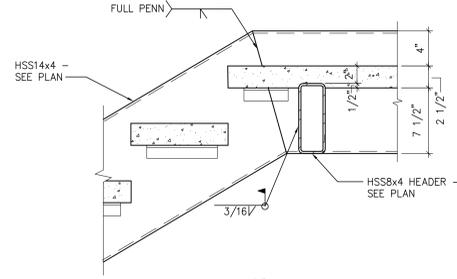


NOTE: PROVIDE 1/4" CLOSER PLATE BETWEEN STRINGER AT CENTER CONNECTION.

STRINGER TO TUBE CONNECTION

SCALE: 1 1/2" = 1'-0"


2
S603

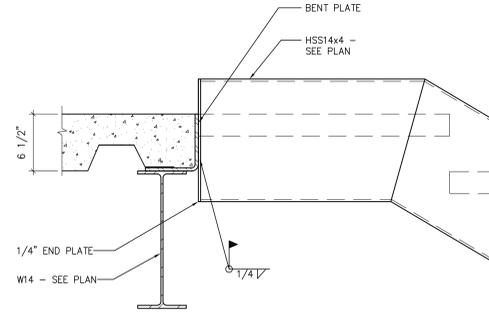

STAIR PURLIN TO FLOOR BEAM

SCALE: 1 1/2" = 1'-0"

3
S603

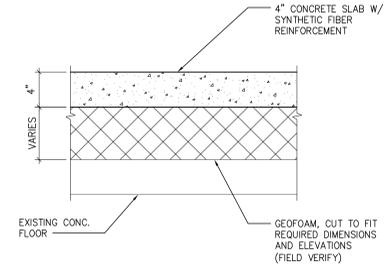

NEW SLAB AT RAISED FLOOR

SCALE: 1 1/2" = 1'-0"

4
S603

mccesken_w:\PROJECTS\00002\61600160\Drawings\AutoCAD\S603_STAIR_FRAMING_DETAILS.dwg, Plot Date: 3/7/2017 9:57 AM, xref: none

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NO.	DATE	REVISION

ALTERATION/ADDITION OUTAGAMIE COUNTY ADMINISTRATION CENTER
S. WALNUT & W. 8TH, APPLETON, WI 54911
STAIR FRAMING DETAILS

DESIGNED PEB	DRAWN MLR
PROJECT NO. 00002-61600160	
DATE MARCH 3, 2017	
SHEET NO. S603	